

CIVIL ENGINEERS

323 WEST ELM STREET

LODI, CALIFORNIA 95240

DATE: 3-17-98


R.C.E. NO. 42764


EXP DATE: 3 31-2000

8888-4

FILE NO.

8888-4D2.DWG

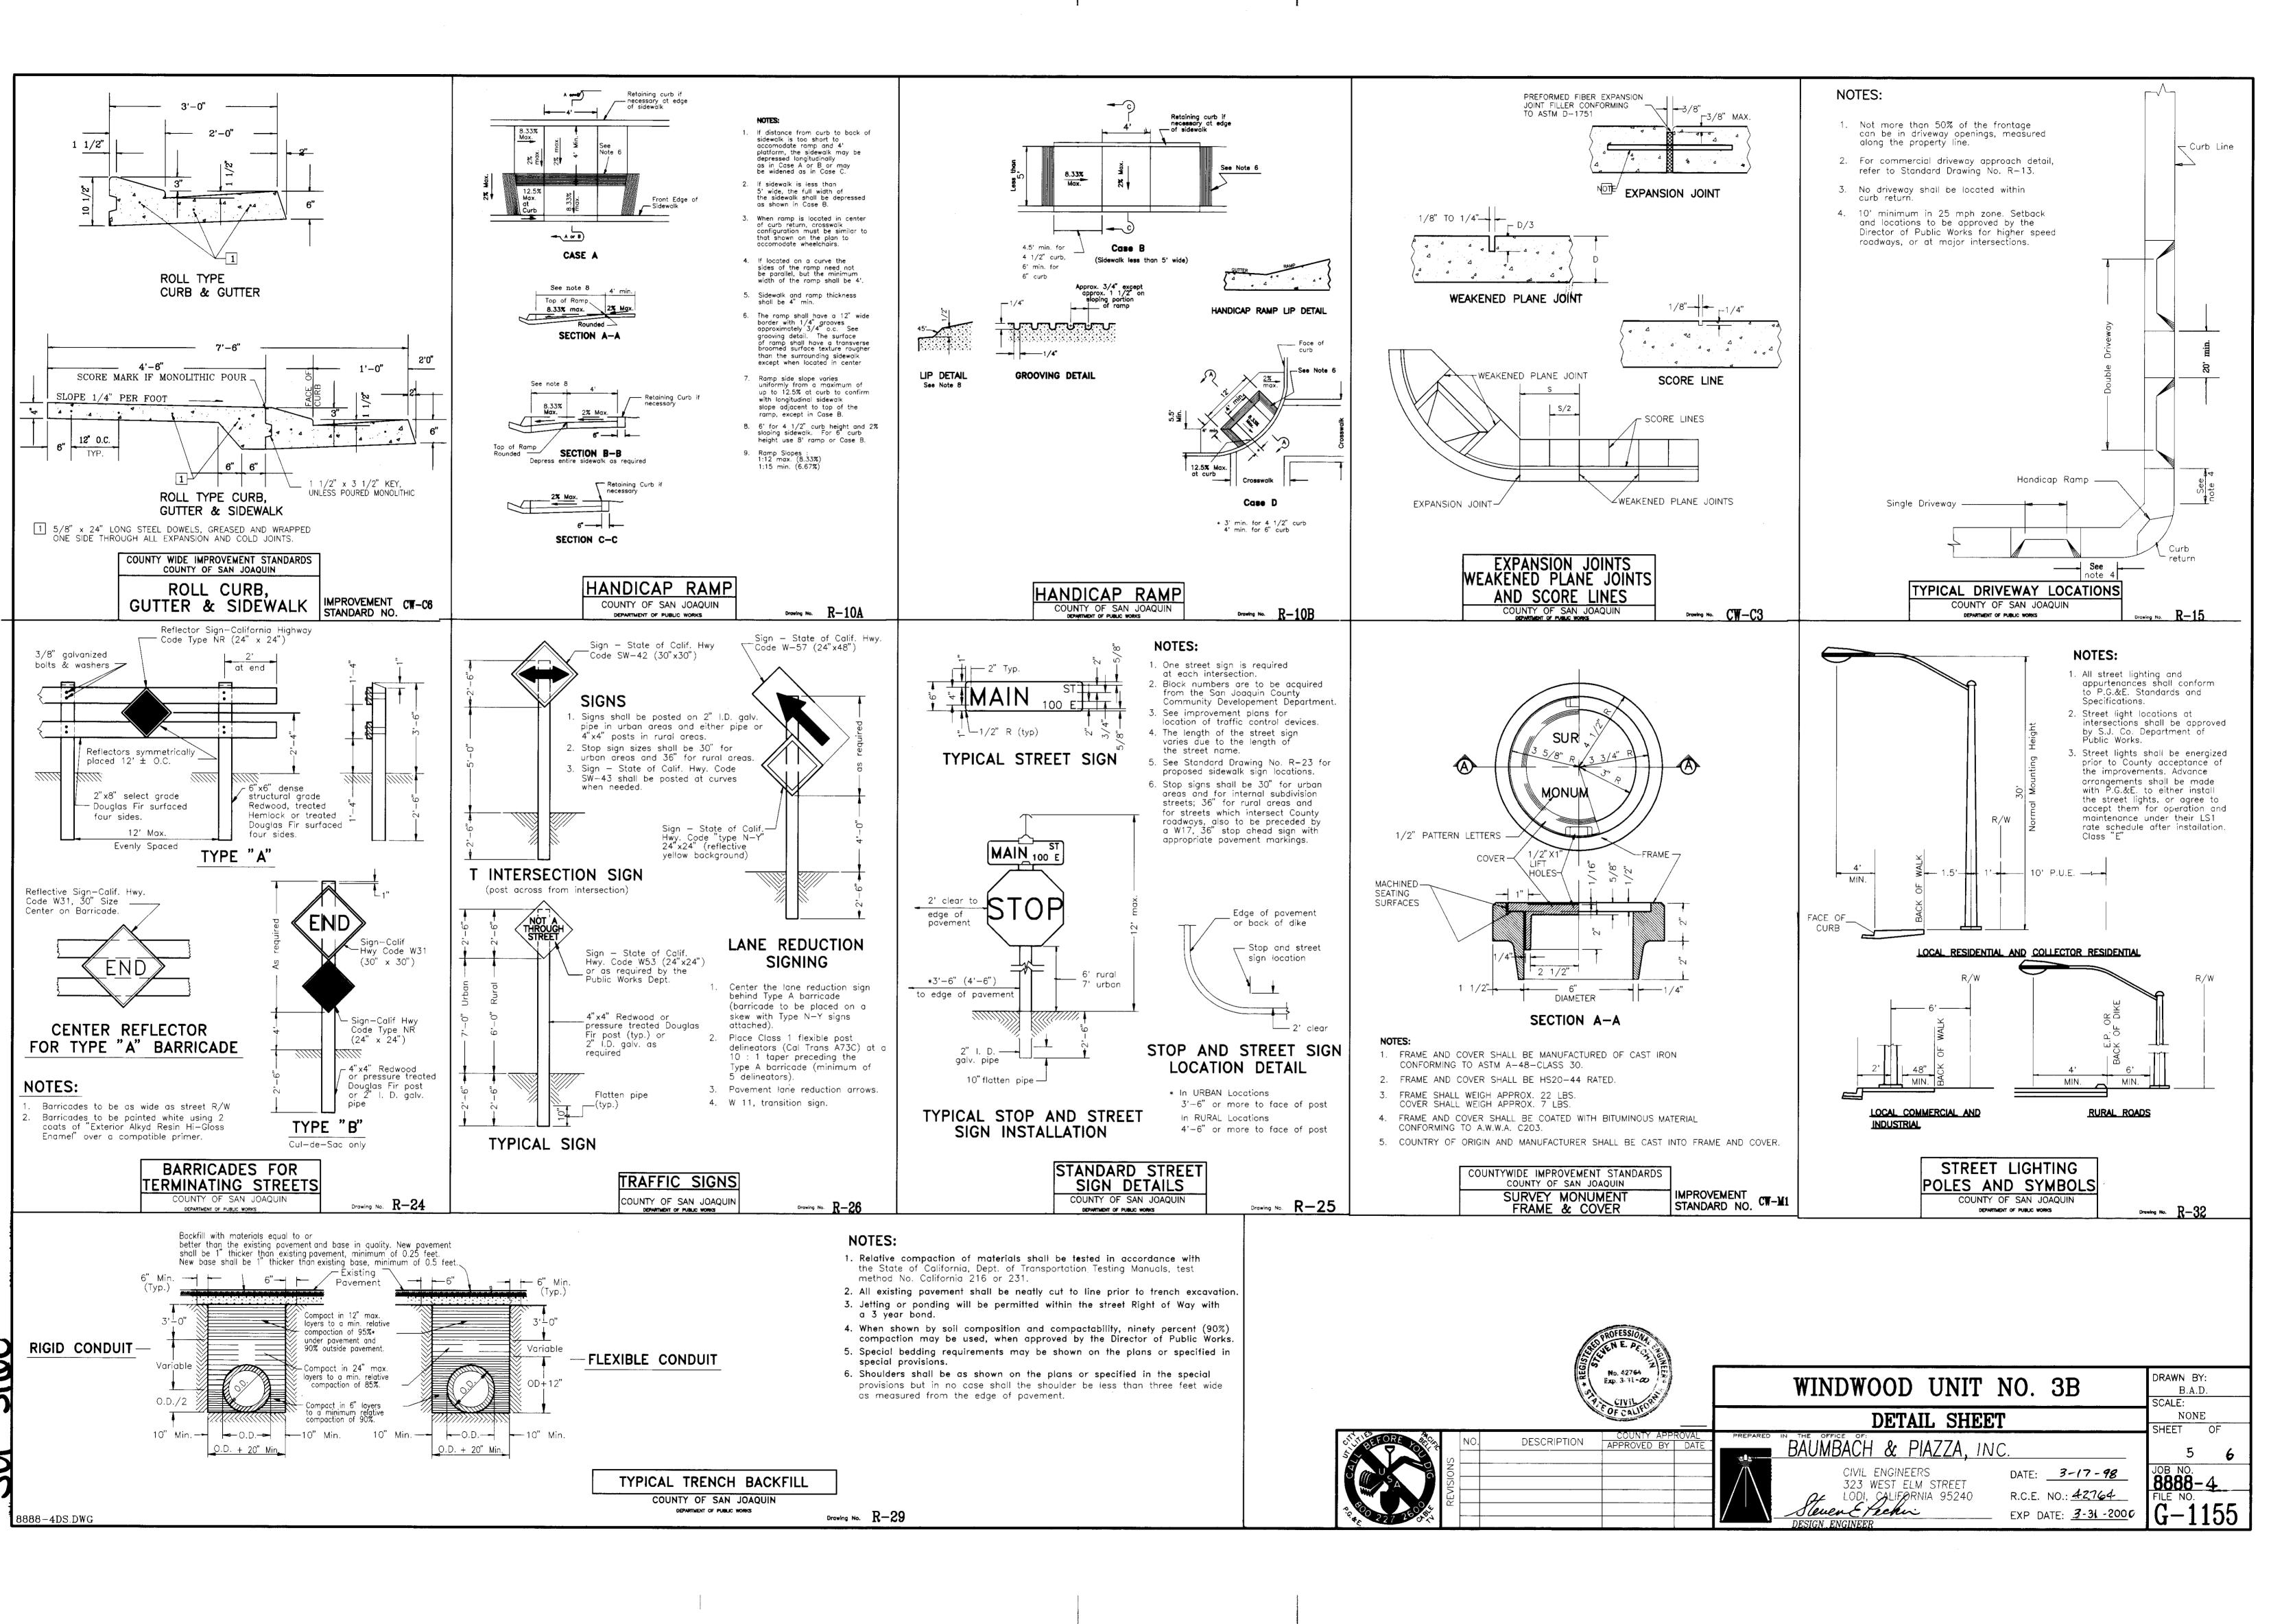

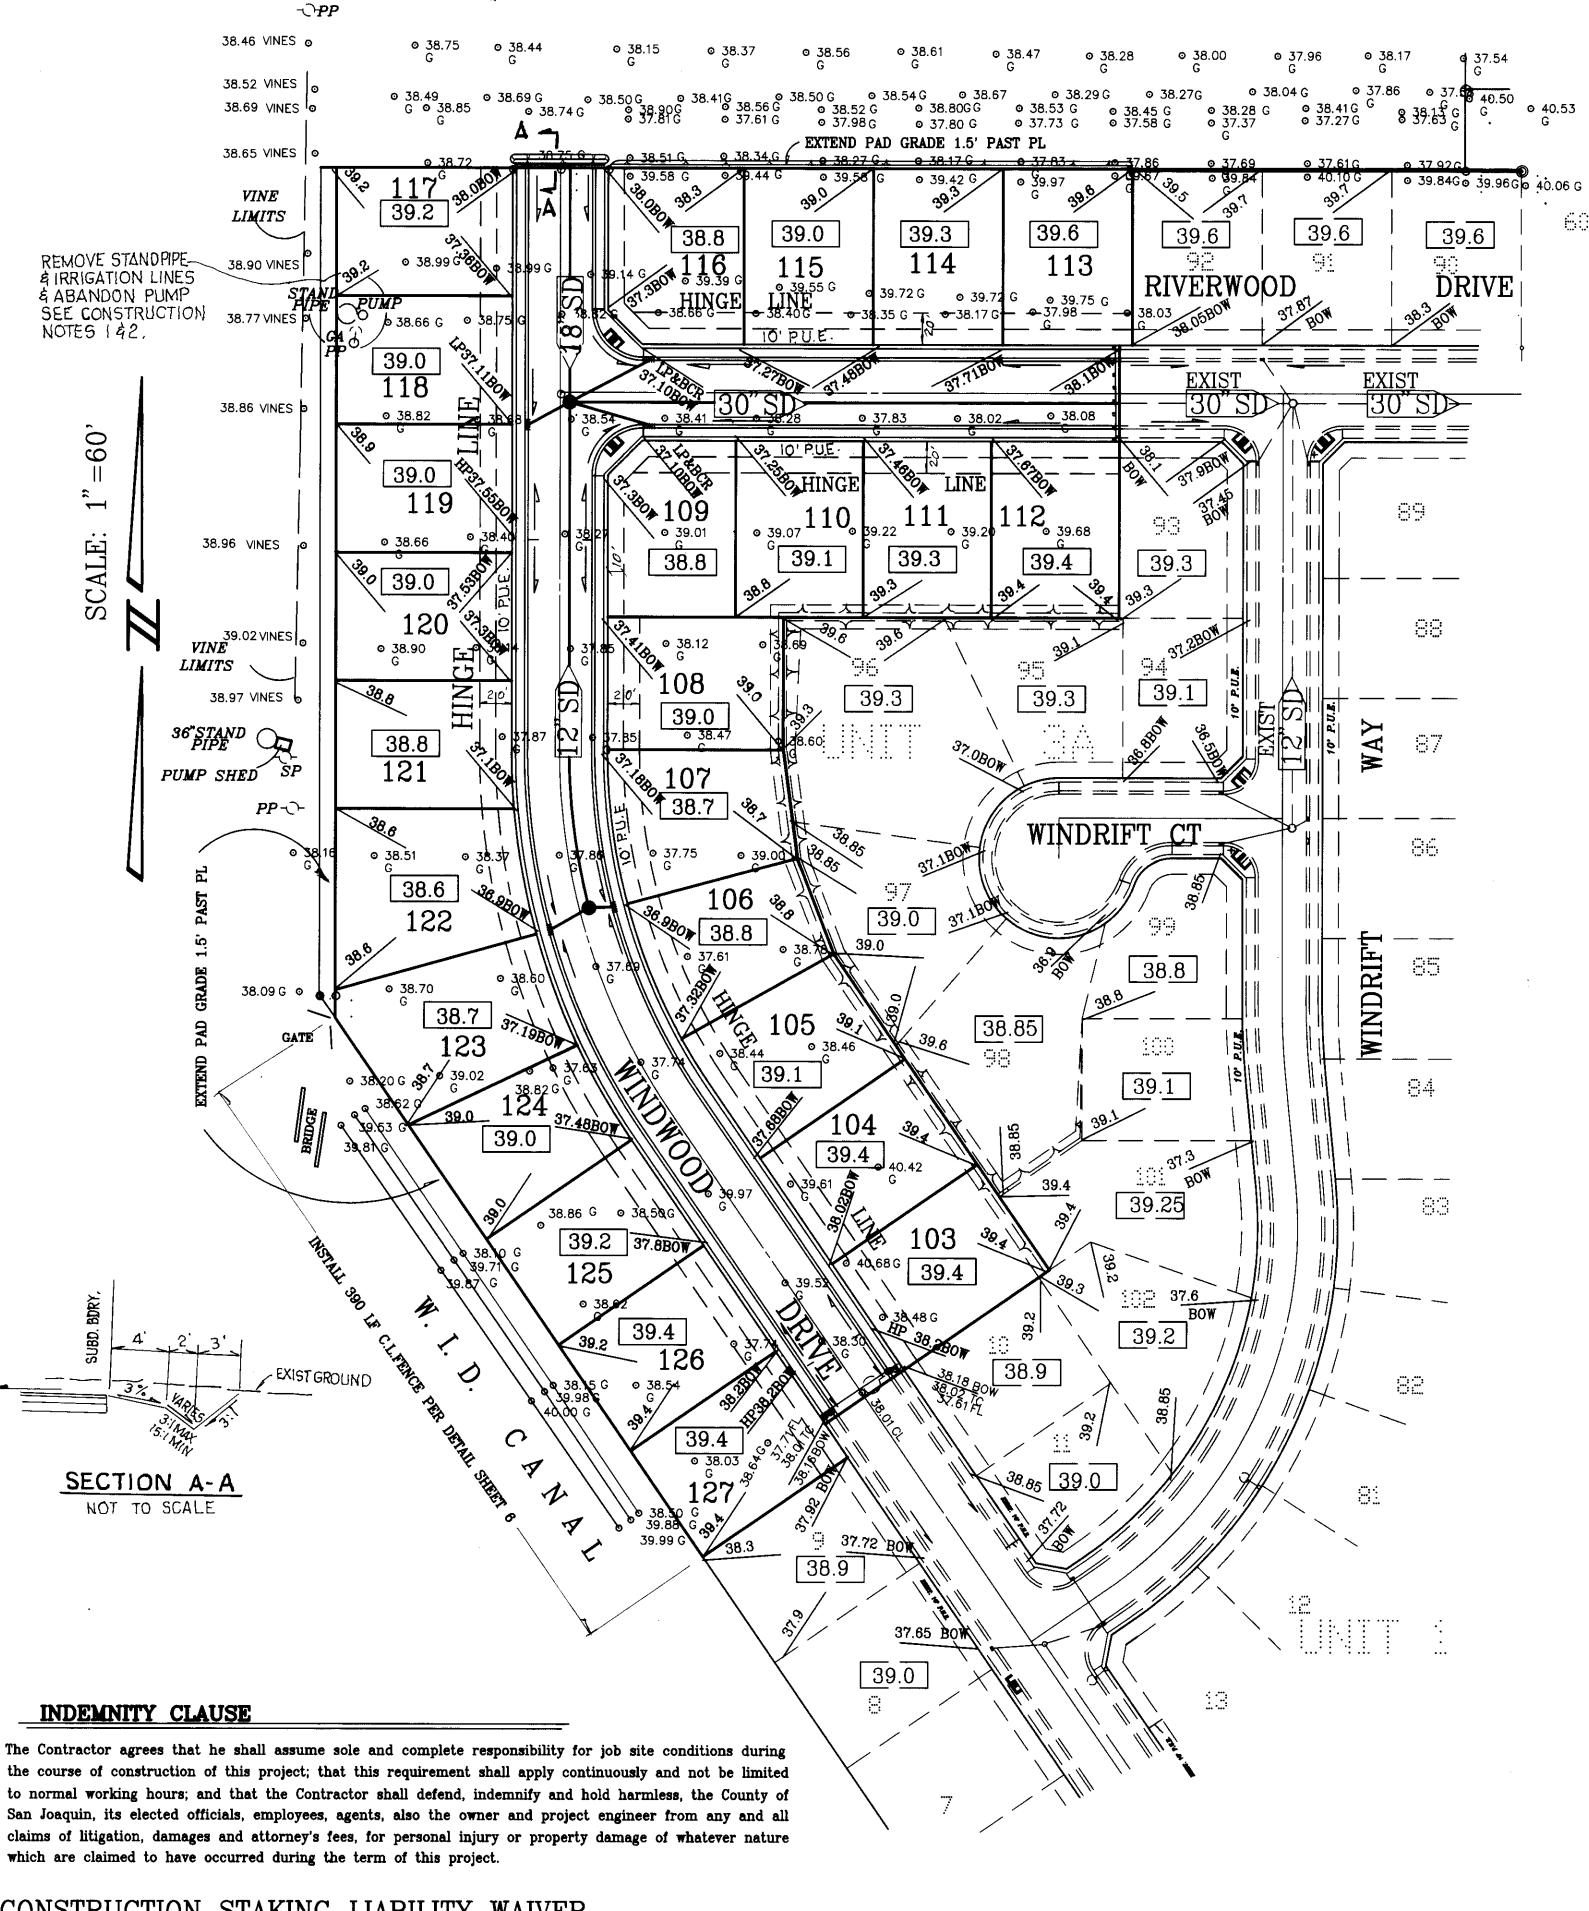

CONSTRUCTION STAKING LIABILITY WAIVER

8888-3BG.D**W**G

These Improvement Plans have been prepared with the intent that the firm of Baumbach & Piazza, Inc. will be performing the construction staking for the complete project. If, however, another engineering and/or surveying firm should be employed to use these plans for the purpose of construction staking, notice is hereby given that the firm of Baumbach & Piazza, Inc. will not assume any responsibility for errors or omissions if any, which might occur and which could have been avoided, corrected or mitigated if Baumbach & Piazza, Inc. had performed the staking work, or if Baumbach & Piazza, Inc. had been contacted prior to staking regarding any questions of ambiguity in the plans, interpretation of the plans, or engineering inconsistencies. These Improvement Plans have been prepared with the intent that the firm of Baumbach & Piazza, Inc. will contained in these plans.

As Built 9-29-98 **LEGEND**

EXISTING CONTOUR

SDMH STORM DRAIN TYPE 1 MAINTENANCE HOLE

+40.72EXISTING GROUND ELEVATION FLOW DIRECTION & SIZE OF STORM

BOW 38.10 BACK OF WALK ELEVATION

PP 🔿 POWER POLE

CURB INLET CATCH BASIN CICB

GUY ANCHOR

LP LOW POINT

SDMH () EXISTING STORM TYPE 1 MAINTENANCE HOLE

G.B. GRADE BREAK

EXISTING FLOW DIRECTION & SIZE OF STORM

TOP OF CURB

5' P.U.E. PUBLIC UTILITY EASEMENT WITH WIDTH

B.C. BEGIN CURVE E.C. END CURVE B.C.R. BEGIN CURB RETURN

TC

E.C.R. END CURB RETURN H.P. HIGH POINT CENTERLINE

> HANDICAP RAMP RIGHT OF WAY R/W

EXIST. or EX.

39.6 BUILDING PAD ELEVATION

EXISTING

39.6 EXISTING BUILDING PAD ELEVATION WINTERIZATION NOTES

It is the intent of the Owner that lot erosion and silt entering the Storm Drain System be kept to a minimum. Therefore the the Contractor shall:

New Catch Basin or Storm Drain Laterals will be sealed with sandbags or plugged until the roads are paved.

2. Prior to acceptance of the project, or the onset of the rainy season, whichever comes first, the Contactor will:

a. Plow or rip all lots (within the hinge line) to a depth of 4 to 6 inches (building pad area only).

b. Install catch basin filter screens on all CICB's. (Watersweeper or equal)

DUST CONTROL NOTES

1. Dust control is the Contractor's sole responsibility when working on-site. When the project has been released to the utility companies, the Contractor's responsibility is to water the site Tuesdays and Fridays. The above work shall be included in the bid. The Contractor shall also water the site, as an extra, when requested by the County or the Owner.

2. All motors shall be kept properly tuned and maintained

3. Earth moving activities shall cease if wind exceeds 20 MPH. 4. On-site vehicle speeds shall be limited to 15 MPH.

GRADING NOTES:

1. All earthwork, grading and other construction per these plans, shall be done in accordance with the Geotechnical Report prepared for "WINDWOOD SUBDIVISION" by Anderson and Associates, their file number S91118. dated May 8, 1991.

2. THE CONTRACTOR SHALL coordinate his work with Anderson and Associates to insure that adequate compaction tests are taken. The costs of re-tests shall be borne by the Contractor. Compaction tests to be submitted to County to verify compliance with soils report.


3. All subdivision grading shall conform to U.B.C. (1988) Chapter 29 and 70.


4. Compact all building pads to 90% RC.


CONSTRUCTION NOTES:

Remove standpipe and underground irrigation lines. Known irrigation line runs southeast from standpipe; others may exist.

2. Pump to be abandoned per County Standards. See Key Sheet, Note#33.

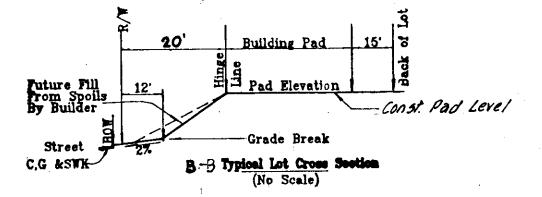

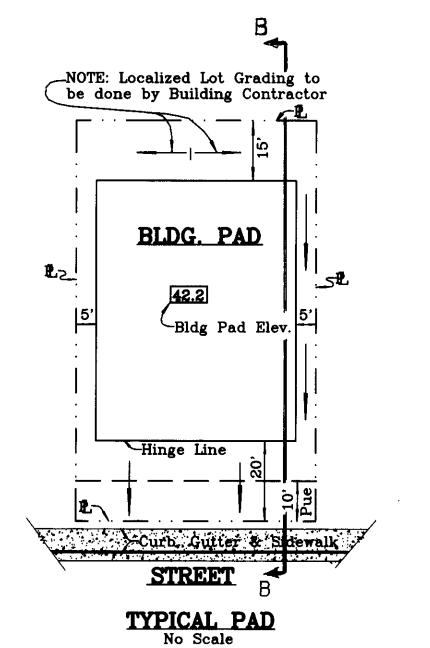


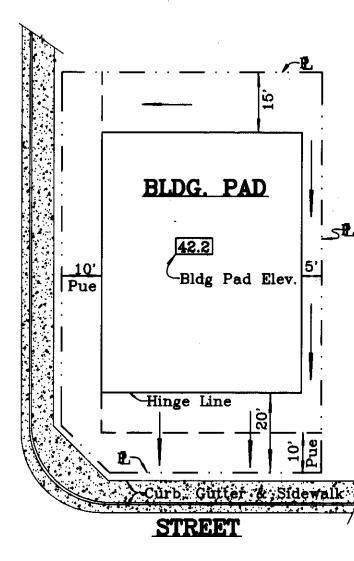



TYPICAL PAD
No Scale NOTE: Dimensions are typical, unless otherwise shown on this plan



				WINDWOOD UNIT NO. 3B	DRAWN BY: E.S. SCALE:
				GRADING PLAN	1"=60'
	NO.	DESCRIPTION	APPROVED BY DATE	PREPARED IN THE OFFICE OF: BAUMBACH & PIAZZA	SHEET (
.				CIVIL ENGINEERS 323 WEST ELM STREET DATE: 5/11 - 98	JOB NO. 8888-4
				LODI, CALIFORNIA 95240 R.C.E. NO.: 42 764 Soven Exchin DESIGN ENGINEER EXP DATE: 3/31/2000	FILE NO. G-11

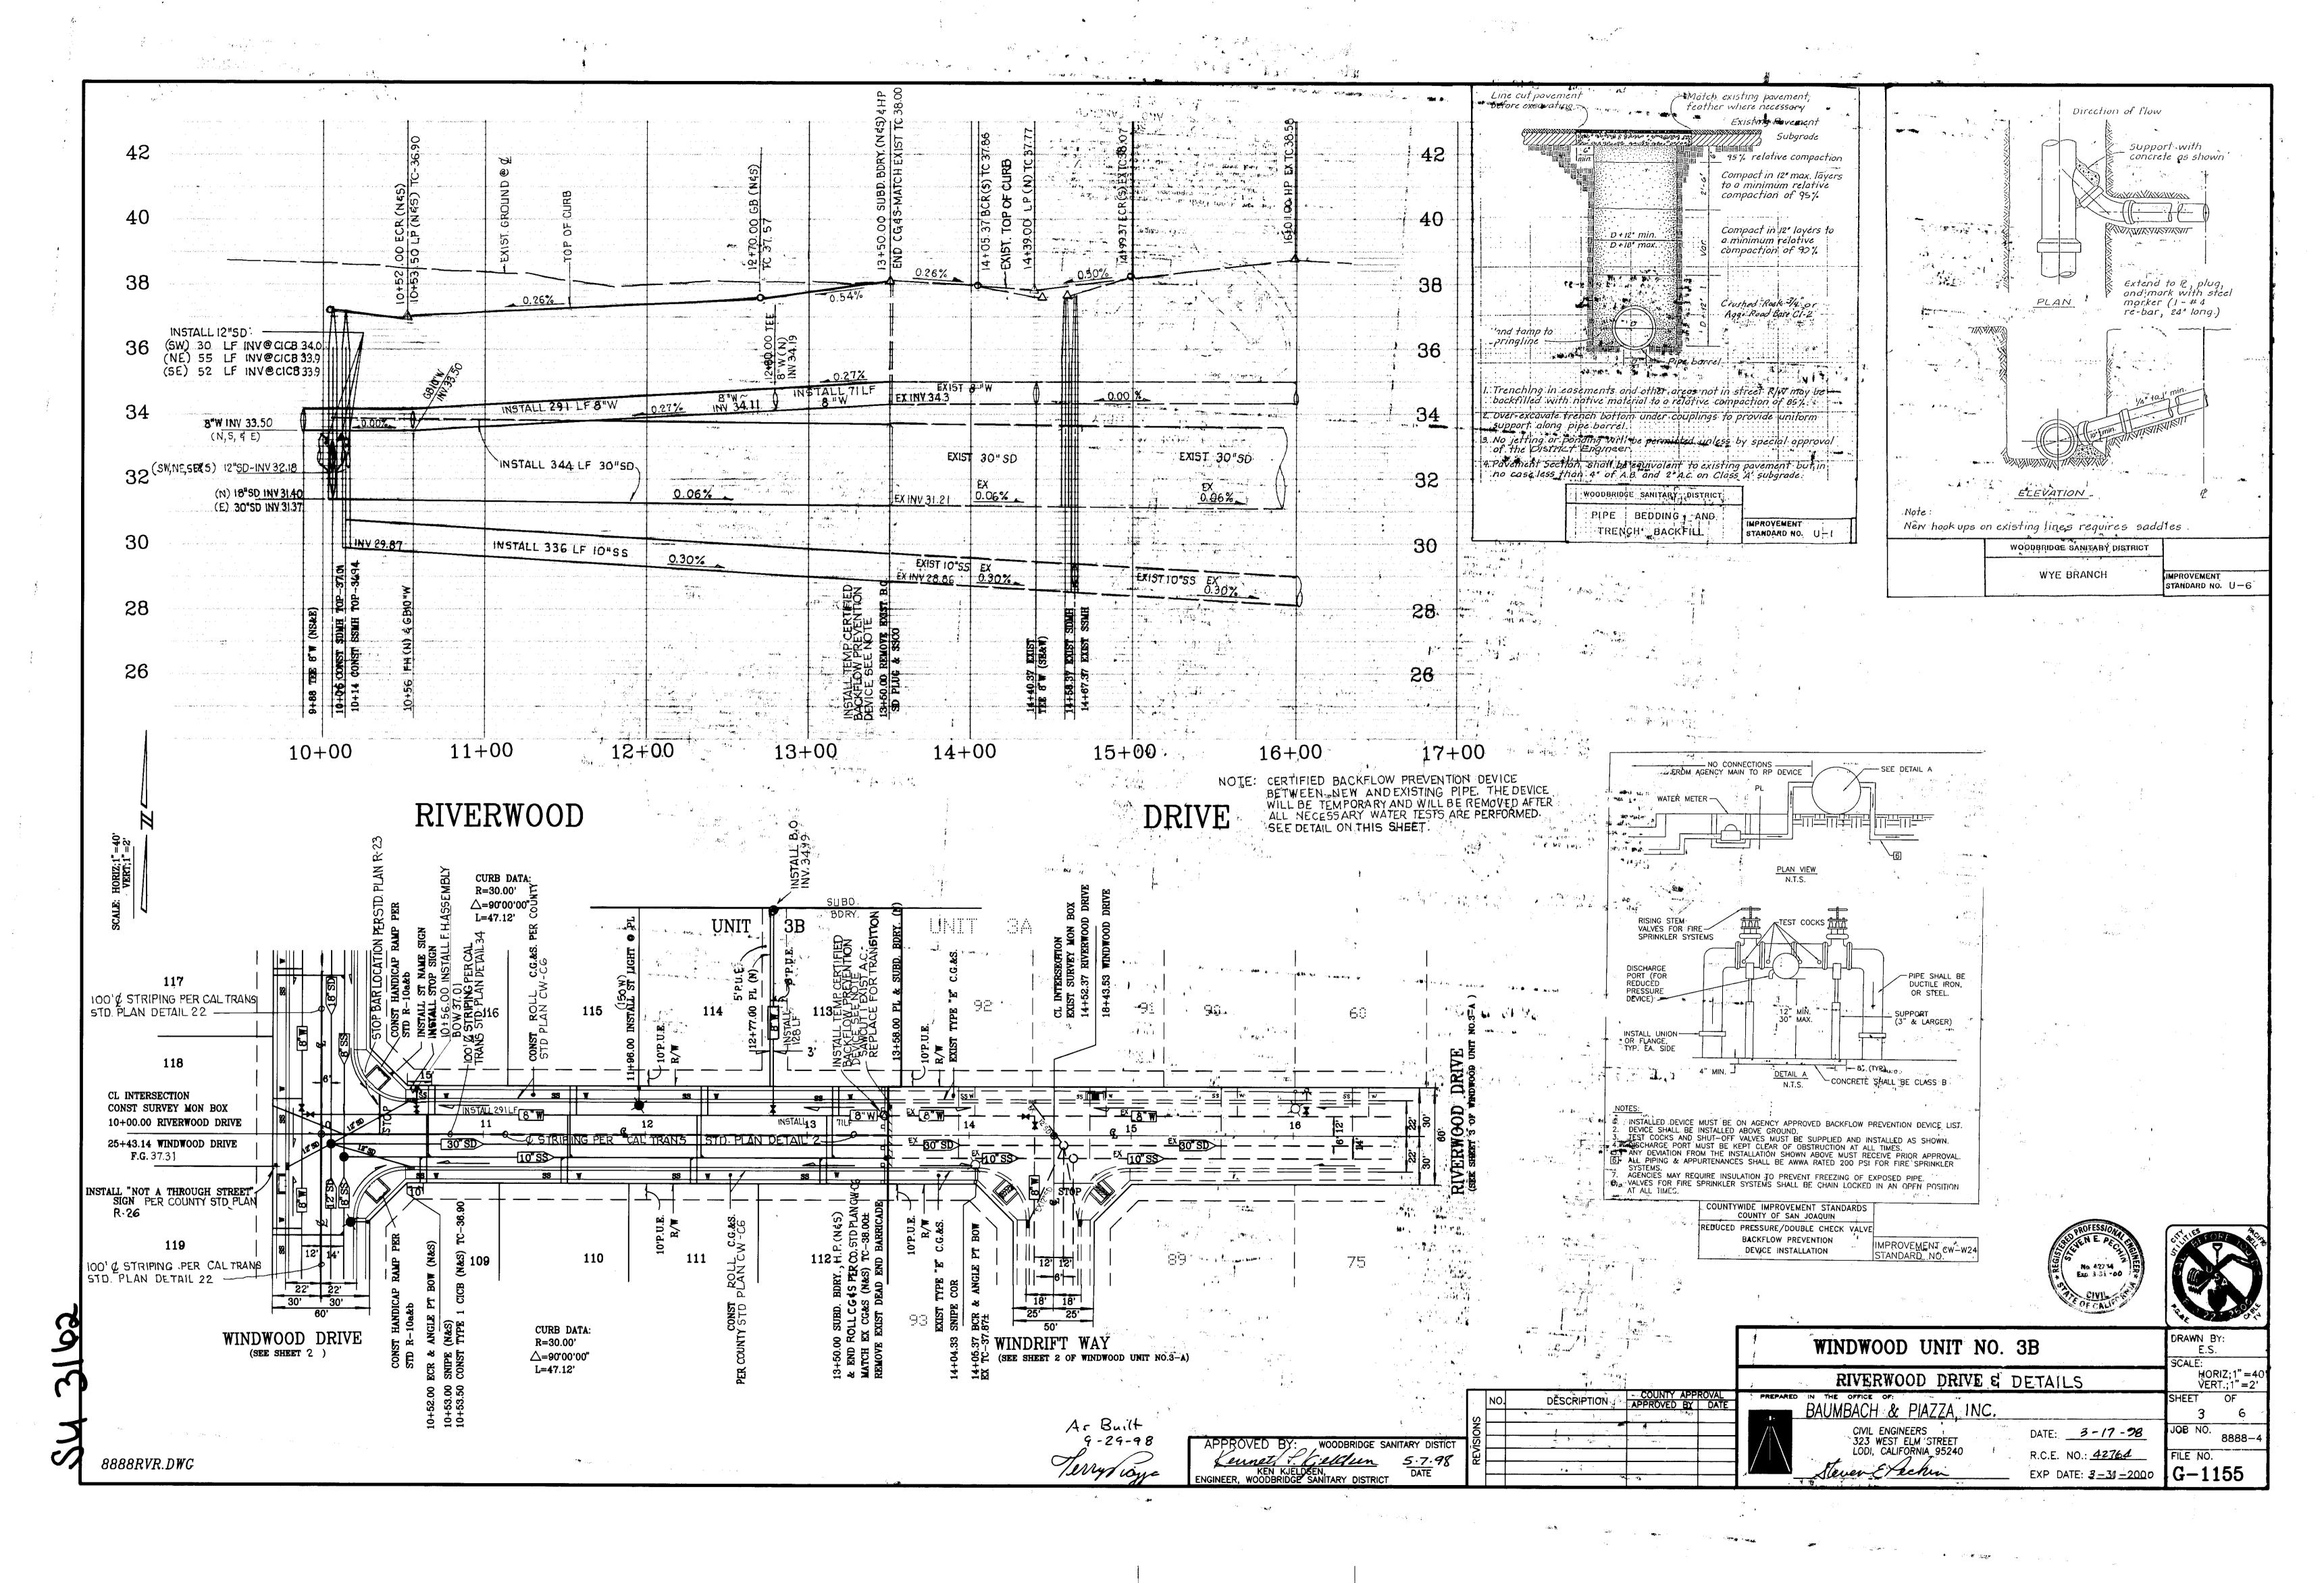

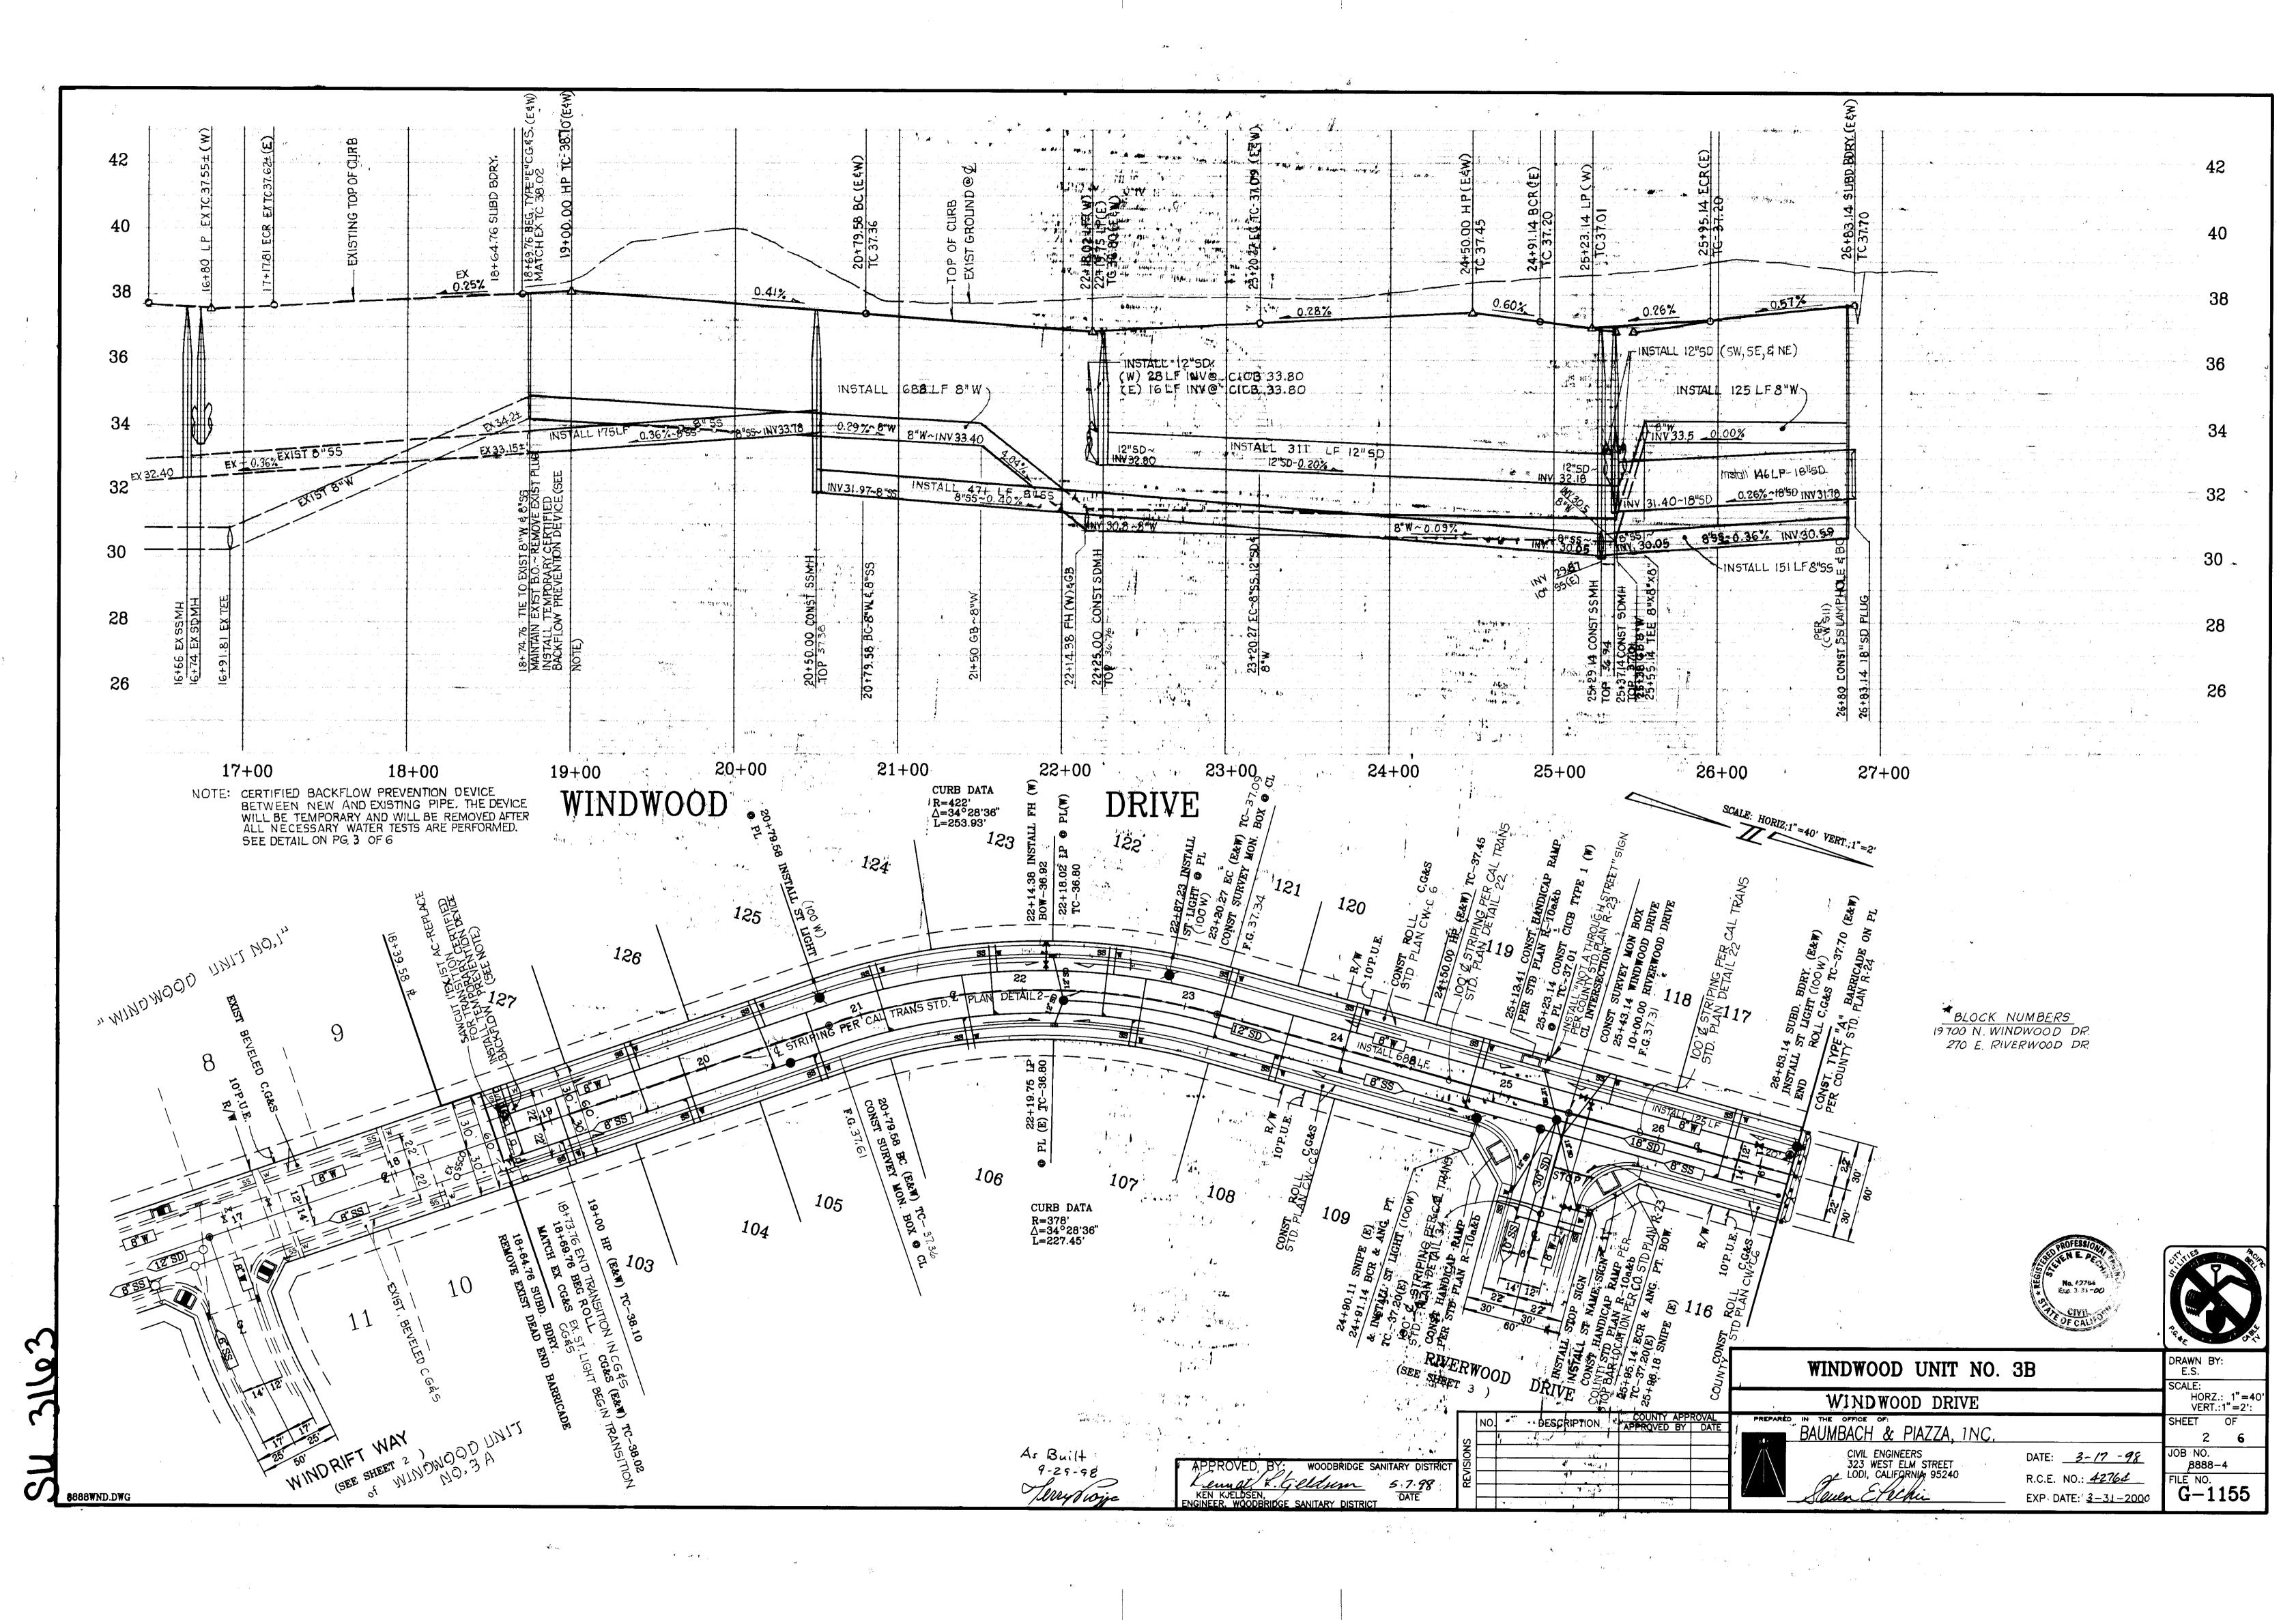

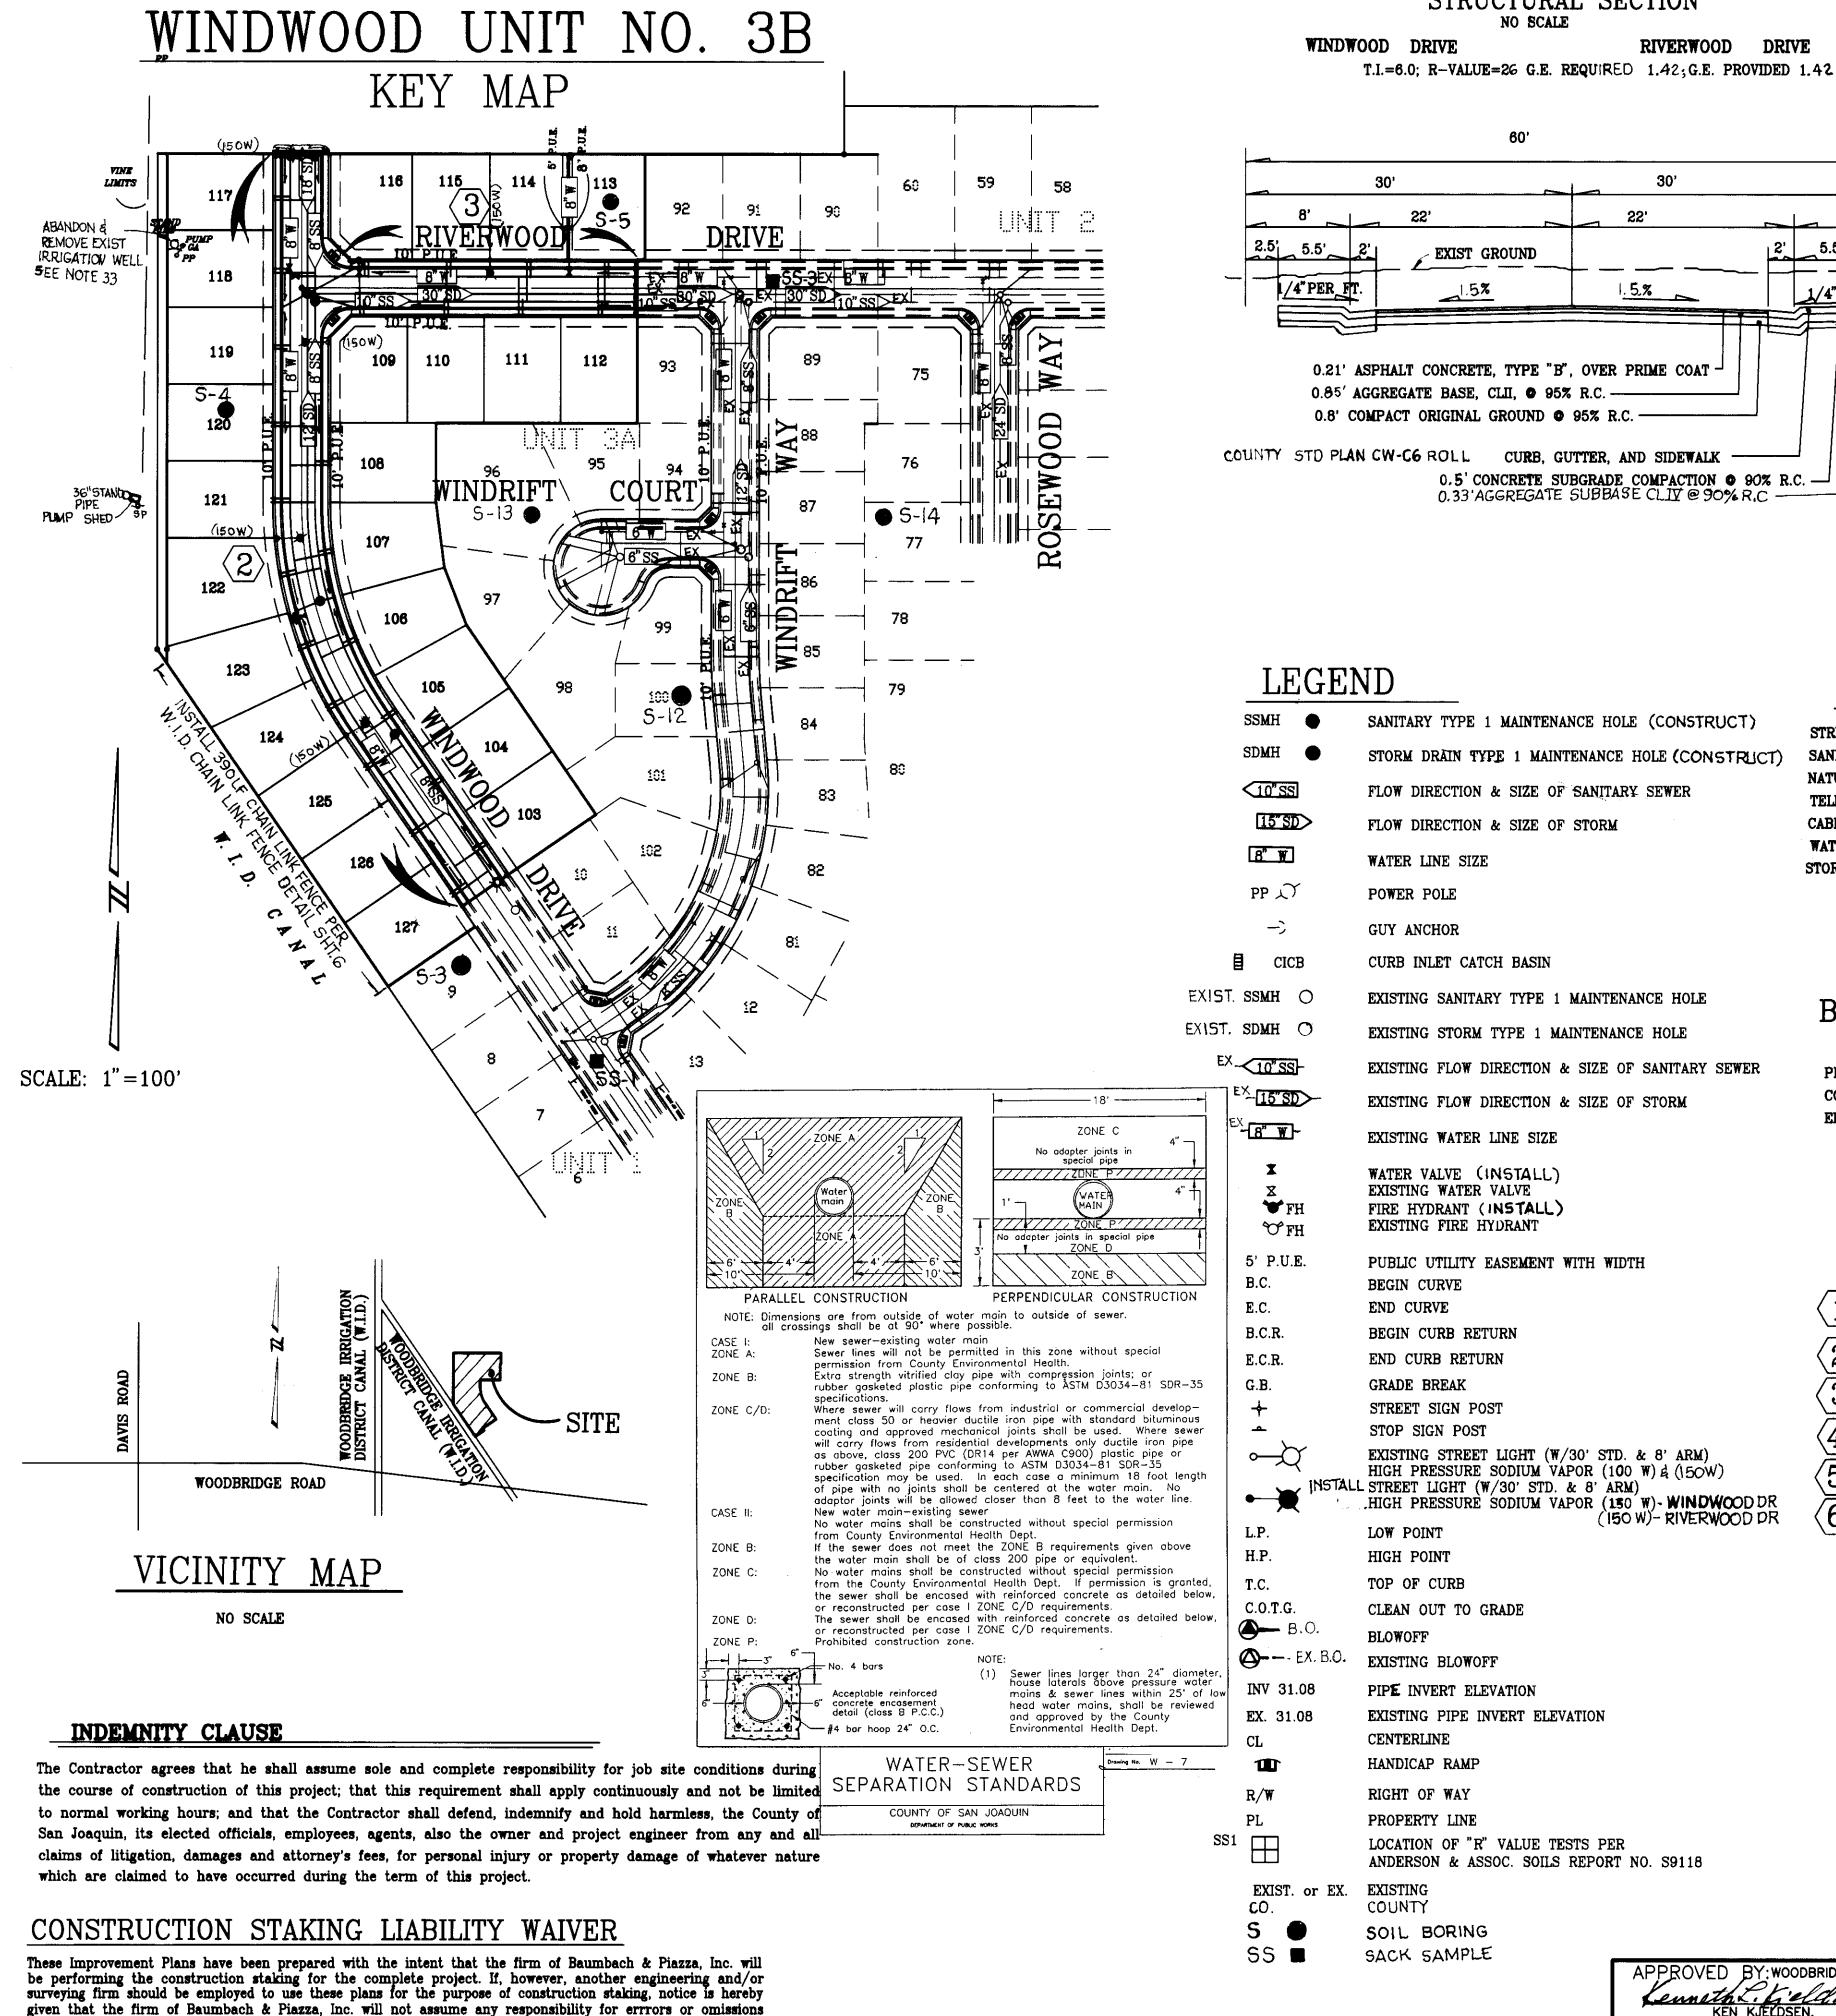

As Built

9-29-98

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RCE 19638

if any, which might occur and which could have been avoided, corrected or mitigated if Baumbach & Piazza, Inc. had performed the staking work, or if Baumbach & Piazza, Inc. had been contacted prior to staking regarding any questions of ambiguity in the plans, interpretation of the plans, or engineering inconsistencies. These Improvement Plans have been prepared with the intent that the firm of Baumbach & Piazza, Inc. will be

contained in these plans.

8888-3BK.DWG

STRUCTURAL SECTION NO SCALE

WINDWOOD DRIVE

RIVERWOOD

30' 5.5' _|2.5 EXIST GROUND L/4" PER_FT. 1.5.% 0.21' ASPHALT CONCRETE, TYPE "B", OVER PRIME COAT 0.85' AGGREGATE BASE, CLII, • 95% R.C. 0.8' COMPACT ORIGINAL GROUND • 95% R.C. — COUNTY STD PLAN CW-C6 ROLL CURB, GUTTER, AND SIDEWALK -

SANITARY TYPE 1 MAINTENANCE HOLE (CONSTRUCT)

FLOW DIRECTION & SIZE OF SANITARY SEWER

EXISTING SANITARY TYPE 1 MAINTENANCE HOLE

EXISTING FLOW DIRECTION & SIZE OF SANITARY SEWER

EXISTING STORM TYPE 1 MAINTENANCE HOLE

FLOW DIRECTION & SIZE OF STORM

WATER LINE SIZE

CURB INLET CATCH BASIN

EXISTING WATER LINE SIZE

WATER VALVE (INSTALL) EXISTING WATER VALVE

FIRE HYDRANT (INSTALL)

PUBLIC UTILITY EASEMENT WITH WIDTH

EXISTING STREET LIGHT (W/30' STD. & 8' ARM)

HIGH PRESSURE SODIUM VAPOR (100 W) & (150W)

HIGH PRESSURE SODIUM VAPOR (150 W)- WINDWOOD DR

(150 W)- RIVERWOOD DR

EXISTING FIRE HYDRANT

BEGIN CURB RETURN

END CURB RETURN

STREET SIGN POST

STOP SIGN POST

BEGIN CURVE

GRADE BREAK

LOW POINT

BLOWOFF

CENTERLINE

HANDICAP RAMP

RIGHT OF WAY

PROPERTY LINE

COUNTY

HIGH POINT

TOP OF CURB

CLEAN OUT TO GRADE

PIPE INVERT ELEVATION

EXISTING PIPE INVERT ELEVATION

LOCATION OF "R" VALUE TESTS PER

ANDERSON & ASSOC. SOILS REPORT NO. S9118

END CURVE

POWER POLE

GUY ANCHOR

STORM DRAIN TYPE 1 MAINTENANCE HOLE (CONSTRUCT)

0.5' CONCRETE SUBGRADE_COMPACTION • 90% R.C. — 0.33'AGGREGATE SUBBASE CLIV @ 90% R.C -


SS & W SERVICES

TYPICAL LOTS

NOTE:(TYP. ALL LOTS)
1. UNLESS OTHERWISE NOTED, SERVICES TO BE AT CENTER OF LOTS. 2. SERVICES MINIMUM OF 3 FEET APART ON MAIN LINE & MINIMUM OF 3 FEET FROM VALVES.

3. ALL WATER SERVICES SHALL BE UPSTREAM OF FH VALVE IN CUL-DE-SAC.

4. WATER SERVICE SHALL INCLUDE METER AND METER BOX PER PER DETAIL SHEET 6. 5. SEWER SERVICE SHALL BE STUBBED AND CAPPED AT R/W

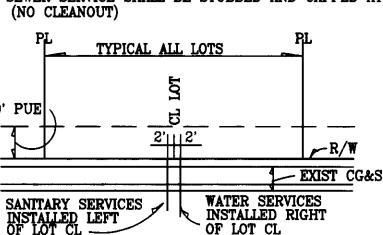

SERVICES

STREET LIGHTS WOODBRIDGE LIGHTING DISTRICT SANITARY SEWER WOODBRIDGE SANITARY DISTICT NATURAL GAS & ELECTRIC___ _ P.G.& E. PACIFIC BELL TELEPHONE _ MEDIA ONE MOKELUMNE ACRES MAINTENANCE DISTRICT STORM DRAINAGE _ MOKELUMNE ACRES MAINTENANCE DISTRICT

BENCH MARK DATUM

PER U.S.G.S. B.M. 19-8 1907-45. LOCATION: NORTHWEST CORNER OF MASONIC BUILDING IN THE TOWN OF WOODBRIDGE ELEVATION: 45.85 IS MOST CURRENT PER F.E.M.A

SHEET INDEX

KEY SHEET & NOTES

IMPROVEMENT PLAN-WINDWOOD DRIVE

IMPROVEMENT PLAN-RIVERWOOD DRIVE & DETAILS

GRADING PLAN

CONSTRUCTION DETAILS

CONSTRUCTION DETAILS

GENERAL NOTES

ALL WORK SHALL CONFORM to these plans and special provisions for this project REFER TO THE final map of this subdivision for all centerline and property line data. THE STREET LIGHT system shall be installed by P.G.& E. Company.

THE CONTRACTOR SHALL receive an approved set of plans and specifications prior to beginning construction.

BAUMBACH & PIAZZA (Engineer) shall set all survey controls and construction stakes necessary for completion of work. The Contractor shall be responsible for the preservation of all survey and construction stakes. Survey and construction stakes that are lost or destroyed, due to Contractor's negligence will be reset by the Engineer at the Contractor's expense.

THE EXISTING UNDERGROUND utilities were plotted from avaliable records. The Contractor shall be responsible for contacting all utility agencies to mark their facilities in the field before any excavation. The Contractor shall notify and coordinate all work with any agency requiring removal or relocation of their utilities. Pacific Bell, P.G.& E., Lodi Cable T.V., Woodbridge Sanitary District and Mokelumne Acres Maintenance District and U.S.A. (800) 227-2600.

HOUSE SERVICES, fire hydrant laterals and street light conduit shall be installed prior to curb and gutter construction. All underground utilities within the street area, including gas and telephone lines, shall be installed prior to paving.

ALL MANHOLES are to be set flush with the finsh grade, unless otherwise indicated.

ALL WATER LINES shall have a minimum cover of 30". 10. WATER USED in any phase of construction, such as backfill compaction, dust control testing or other work herein required, shall be included in the unit price or lump sum bid for the respective item of construction.

1. CONTRACTOR AGREES THAT he shall assume sole and complete responsibilty site conditions during the course of construction of this project, including safety for all persons and property; that this requirement shall apply continuously and not be limited to normal working hours and that Contractor shall defend, indemnity, and hold the Owner County and the Engineer harmless from any and all liability, real or alledged, in connection with the performance of work on this project, excepting for liability arising from the sole negligence of the Owner or the Engineer.

12. CONTRACTOR SHALL give Engineer a minimum of 48 hours notification prior to staking

13. SANITARY SEWER SERVICES shall be marked by the Contractor on the curb & gutter with an "S" stamped on the top of curb.

14. WATER SERVICES shall be marked by the Contractor with a "W" on the curb. Location of water markings shall be verified in the field by the Engineer.

15. LOT GRADING SHALL be completed before starting any underground construction. Refer to attached grading plan.

16. SEPARATION OF WATER and sewer mains(including crossings) and sewer laterals crossing over water mains shall meet or exceed the latest standards of the State of California Department of Health Services.

17. THE CONTRACTOR SHALL be responsible for notifying and co-ordinating all work with any agency requiring removal or relocation of utilities such as Pacific Bell, P.G.& E., etc.

18. ALL OFF-SITE WATER lines shall be pressure tested, disinfected, flushed and tested for bacteria in conformance with the San Joaquin County Health Code

Requirements prior to connecting to existing water line.

19. ALL OFF-SITE STORM drains shall be cleaned prior to final acceptance. 20. THE CONTRACTOR SHALL visit the site prior to bidding. Specifications are a

separate document 21. NEW TRAFFIC STRIPING and the restoration of any damaged existing painted legends or signs is the responsibility of the contractor and shall be included in his bid price.

WHERE THE WATER crosses SD or SS use an 18-20 length of CL 200 pipe, centered over the SS or SD if; a)the water is under the SS or SD. b)the vertical clearance is less than 1 foot. (Refer to Sewer Separation Detail)

23. NO MATERIALS RESULTING from tapping procedures may enter District sewer. 24. ALL WORK WILL be required to be inspected by the Department of Public Works. They shall be notified not less than 24 hours in advance of commencement of work.

25. IT IS AGREED that field conditions may require changes to these plans. It is further agreed that the Director of Public Works may require changes, alterations or additions to these plans, when the Director deems them to be necessary or desirable for the proper completion of the work, provided that such changes, alterations and additions shall not exceed 10% of the original estimate of the cost for the improvements without prior approval of the county.

26. FIRE HYDRANT BID shall include the following: Tee, 6 lateral, 6 valve and complete fire hydrant assembly.

THE CONTRACTOR SHALL notify S. J. Co. Utility Maintenance Division for approval prior to connecting the water line to existing water main. Backflow Prevention Device toh 28. INSTALLATION OF ALL sanitary sewer improvements shall conform to the standards of the CCT bridge Sanitary District. All such work is subject to inspection by the District Engineer. The Contractor shall notify the District Engineer 48 hours prior to the commencement of any work on the sanitary sewersystem. (209) 946-

29. PIPE TYPE and strengths allowed for underground utilities, unless otherwise specified 0268 on plans, are as follows: Storm Drain (SD)=RCP CL III or PVC (SDR35); Sanitary Sewer (SS)=PVC per ASTM D3034, SDR 35; Water (W)+PVC CL.150 or greater per AWWA Std. C-900.

30. All traffic signs and markings shall conform to the San Joaquin County Standards and Manual of Uniform Traffic Devices.

31. ANY CHANGES TO the approved Improvement Plans and Specifications must be prepared and certified by the "Civil Engineer" and shall be approved by the "Director" prior to implementation.

32. ALL MATERIALS USED as sanitary sewer system must have written approval from the District Engineer prior to imstallation.

33. Well Abandonment shall be done according to Section 6-141.0 Water Well Abandonment of the County Structural Specifications and Son Joaquin County Certificates of Abandonment shall be given to the County before rough grading. A licensed water well contractor (C-57) shall abandon wells. Abandonment permit required from Environmental Health.





SOIL BORING COUNTY OF SAN JOAQUIN
DEPARTMENT OF PUBLIC WORKS SACK SAMPLE DRAWN BY: WINDWOOD UNIT NO. 3B ES APPROVED BY: WOODBRIDGE SANITARY DISTRICT APPROVED: JUNIUM, JUNIUM RCE NO: 2/258

DIRECTOR OF PUBLIC WORKS EXP DATE: 9/20/0 KEN KJELDSEN, DATE
NGINEER, WOODBRIDGE SANITARY DISTRICT SCALE: KEY SHEET AS NOTED SHEET APPROVED BY: WOODBRIDGE IRRIGATION DISTRICT DESCRIPTION APPROVED BY: SAN JOAQUIN FIRE WARDEN BAUMBACH & PIAZZA, INC. Steve Dalton JOB NO. CIVIL ENGINEERS DATE: 3/17 - 98 323 WEST ELM STREET 8888-4 APPROVED BY: SAN JOAQUIN PUBLIC HEALTH LODI, CALIFORNIA 95240 R.C.E. NO.: 42764 FILE NO. SIGNATURE SIGNATURE G-1155 EXP DATE: 3-31-2000