ADJUST MAINTENANG FRAME AND CO		
Locations	C	∂uantity
Florida Avenue Sta. 12+54 (6' Lt) Sta. 12+73 (6' Rt) Myran Avenue	1	SDMH SSMH
Sta. 4+20 (5' Rt) Sta. 6+76 (4' Rt)	1 1	SSMH SSMH
Kenyon Street Sta. 2+49 (1' Lt) Sta. 4+95 (1' Lt)		SSMH SSMH
Sutro Avenue Sta. 24+34 (14' Lt) Sta. 24+42 (CL) Sta. 28+42 (CL) Sta. 28+53 (14' Lt)	1 1 1	SSMH SSMH SSMH SSMH
Report Avenue Sta. 32+40 (4' Rt)	1	SSMH
TOTAL	10 1	SSMH SDMH

PLANING ASPHALT C PAVEMENT	ONCRETE
Locations	Quantity
Intersection Florida Avenue & Myran Avenue	184 SY
Myran Avenue Station. 7+37 to Sta. 7+62	67 SY
Kenyon Street Station, 2+40 to Sta. 4+07	111 SY
Sutro Avenue Station. 22+90 to Sta. 23+15 Planing along Gutter	92 SY 390 SY
Report Avenue Station. 29+60 to Sta. 29+85	61 SY
TOTAL	905 SY

SHOULD	ER BAC	KING
Locations		Quantity
Florida Avenue		15 Tons
Myran Avenue		30 Tons
Kenyon Street		50 Tons
Sutro Street		25 Tons
Report Street		40 Tons
	TOTAL	160 Tons

DRIVEWAYS				
Locations	TYPE D TYPE E			
	No.	Area	No.	Area
Myran Avenue	10	110 SY	1	53 SY
Kenyon Street	14	145 SY	6	73 SY
Sutro Avenue	11	142 SY	1	25 SY
Report Avenue	13	139 SY	5	159 SY
TOTAL	48	536 SY	13	310 SY

ASPHALT CONCRETE	(TYPE B)
Locations	Quantity
Intersection Florida Avenue & Myran Avenue	47 Tons
Myran Avenue	173 Tons
Kenyon Street	276 Tons
Sutro Avenue	280 Tons
Report Avenue	172 Tons
Driveways	141 Tons
(TRENCH)	214 Tons
TOTAL	1,303 Tons

ASPHALT	CONCRETE (LEVELING)	(TYP	Е В)
Locations		Qua	ntity
Myran Avenue Kenyon Street Sutro Avenue Report Avenue		107 105	Tons Tons Tons Tons
	TOTAL -	361	Tons

PAVEMENT	REINFORCING FABRIC
Locations	Quantity
Myran Avenue	1,276 SY
Kenyon Street	1,913 SY
Sutro Avenue	1,670 SY
Report Avenue	1,273 SY
	TOTAL 6,132 SY

18" STORM DRAIN INLET CATCH BASIN		
Locations	Quantity	
Myran Avenue X Kenyon Avenue Kenyon Street X Sutro Avenue Kenyon Street Report Avenue X Kenyon Avenue Report Avenue	5 EACH 1 EACH	
TOTAL	12 EACH	


24" DIAME CONCRETE		
Locations		Quantity
Florida Avenue Myran Avenue Kenyon Avenue		14 LF 438 LF 491 LF
	TOTAL	943 LF

18" DIAMETER CONCRETE PIP	· · — · · — · · — — —
Locations	Quantity
Kenyon Street	360 LF

12" DIAMETER CONCRETE PIPE	
Locations	Quantity
Sutro Avenue	17 LF
Sutro Avenue	158 LF
Report Avenue	494 LF
TOTA	.L 669 LF
1012	.

STORM DRAIN MAINTENANCE HOLE		
Locations	Quantity	
Florida Avenue X Myran Avenue Myran Avenue X Kenyon Avenue		
Kenyon Street X Sutro Avenue Sutro Avenue	2 EACH 1 EACH	
Report Avenue X Kenyon Avenue Report Avenue	1 EACH	
TOTAL	7 EACH	

	SANITA LATERA		
Locations		Qu	iantity
Myran Avenue		3	EACH
Kenyon Street		12	EACH
Sutro Avenue		2	EACH
Report Avenue		9	EACH
	-		
	TOTAL	26	EACH

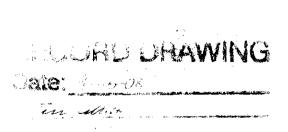


DRAWN BY		DATE	PROJECT	ENGINEER	DATE	CHECKED	DATE	APPROVAL RECOMMENDED	DATE
Enrique Silva		09/06	Chang	Car	10/5/06	Jeny Violett	10/6/06	Monuel Stario	10/12/9
FILE NAME	DR	AWER	SHEET NO.			ACAD		REVISIONS	DATE
				1					

COUNTY OF SAN JOAQUIN


GIANONE PARK AREA STORM DRAINAGE IMPROVEMENTS PHASE 1—C SHEET NO. SHEETS


(Federal Aid Project No. SJC-06-03)


8 8 (Federal Aid Project No. SJC-06-03)

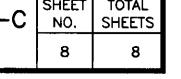

NO SCALE SUMMARY OF QUANTITIES

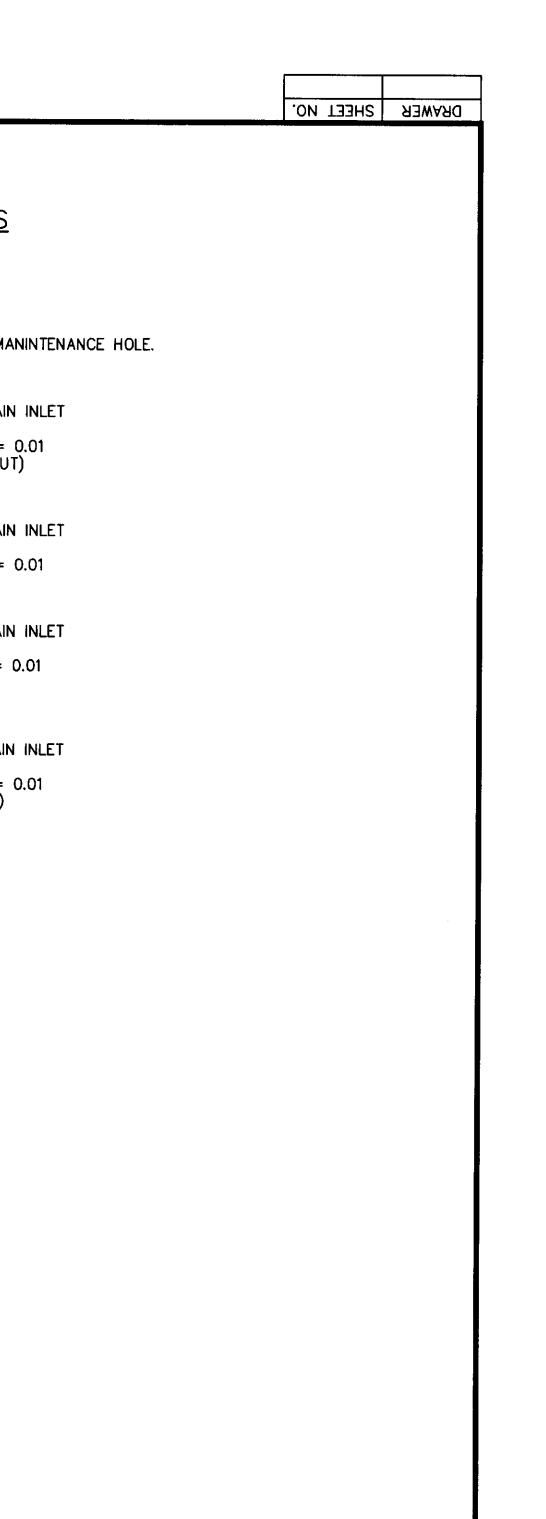

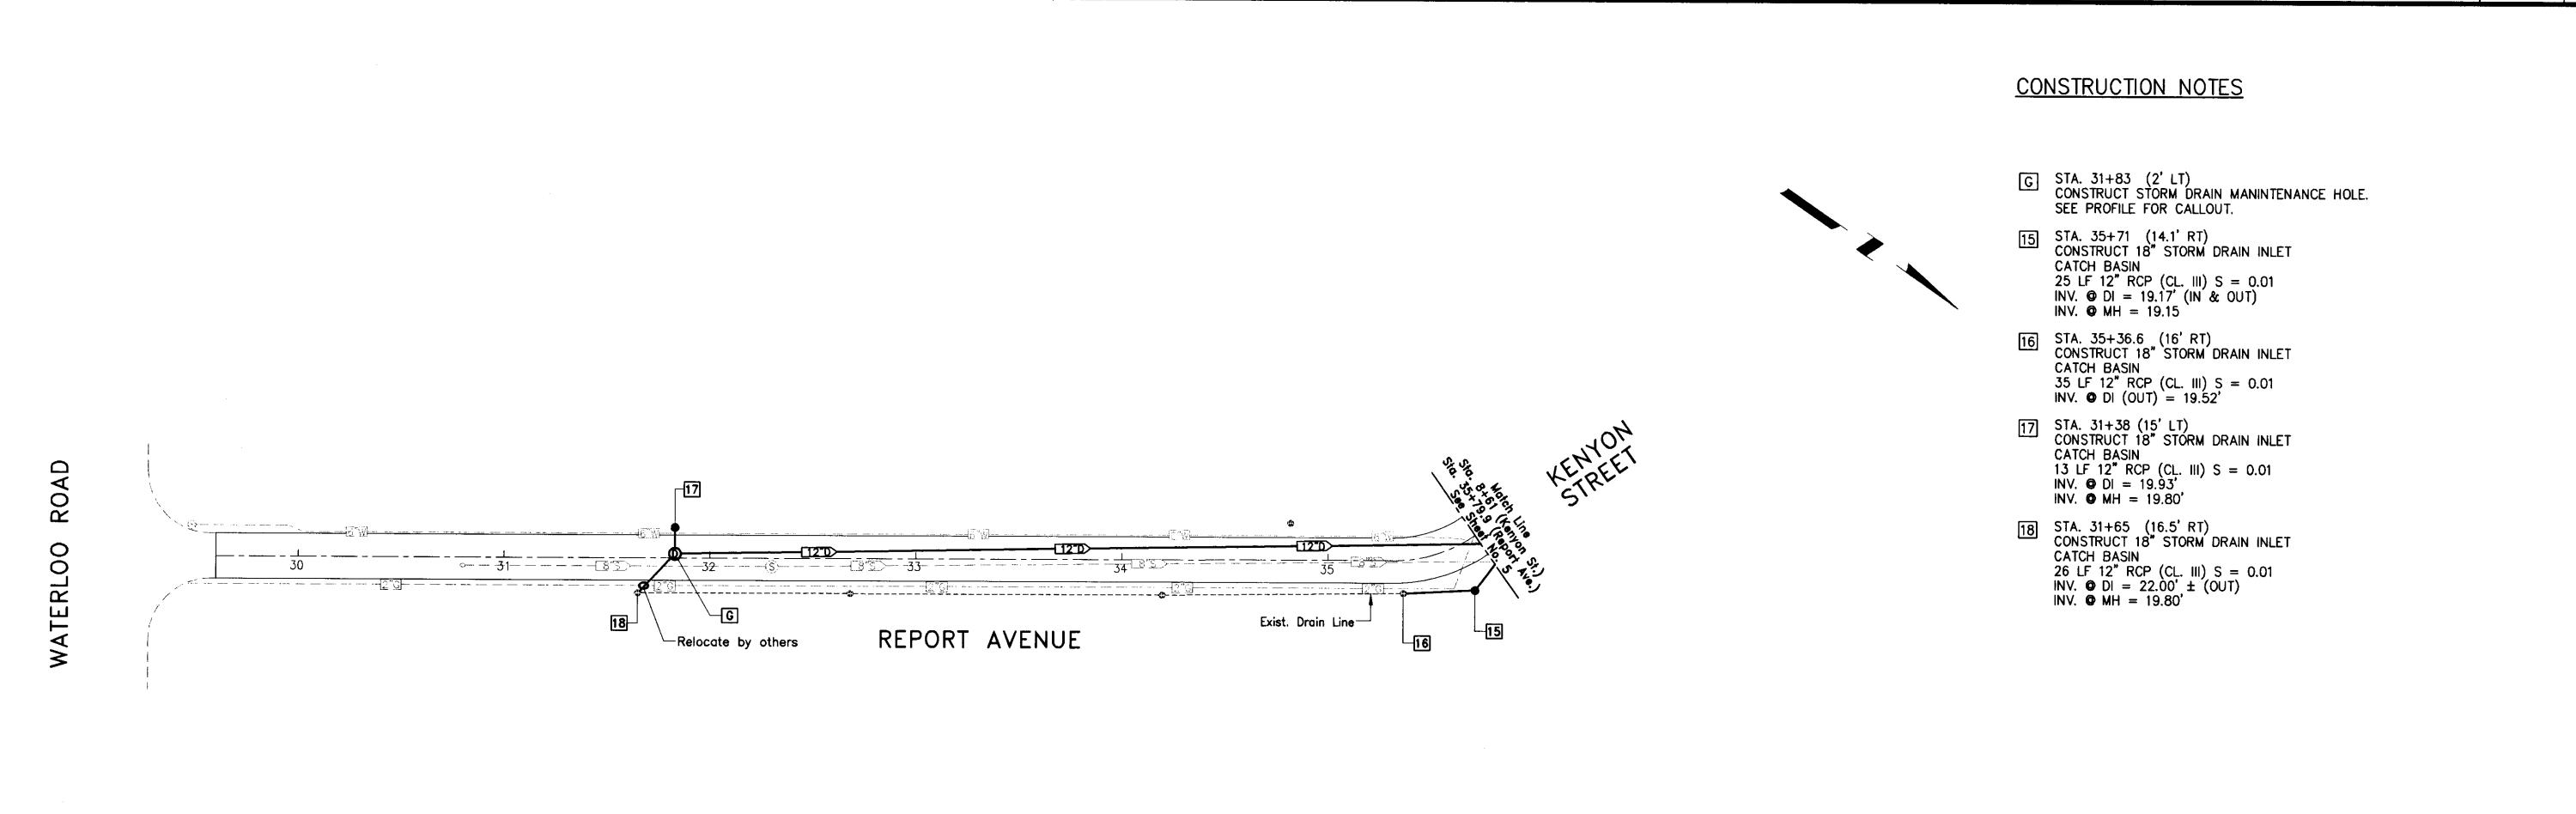

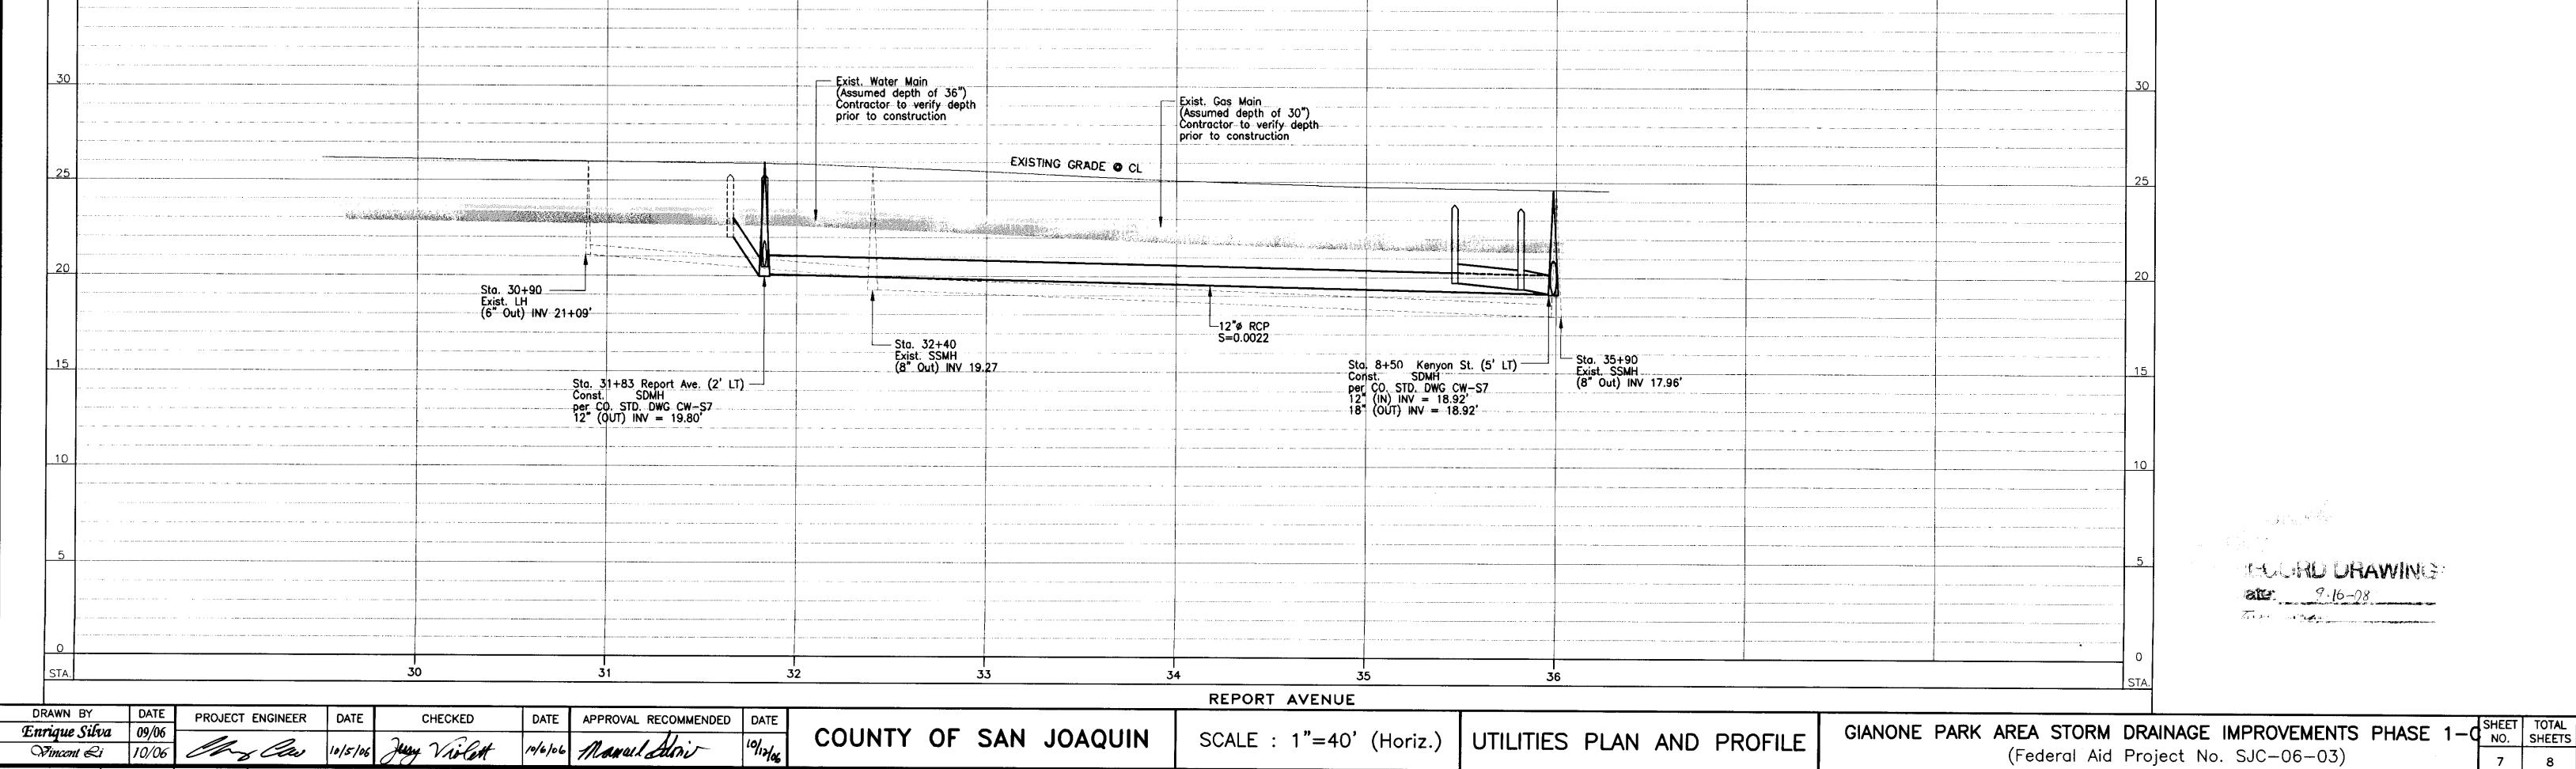

DRAWER SHEET NO.

E:\Projects\2007\CC Gianone 1C 75377\Plans\XGianone 1c Utilities.dwg

REVISIONS

FILE NAME

DRAWER SHEET NO.


CONSTRUCTION NOTES


- H STA. 28+54 (5' LT)
 CONSTRUCT STORM DRAIN MANINTENANCE HOLE.
 SEE PROFILE FOR CALLOUT.
- 20 STA. 28+34 (22' RT) EXISTING 18" STORM DRAIN INLET CATCH BASIN

 27 LF 12" RCP (CL. III) S = 0.01

 INV. @ DI = 23.00' ± (OUT)

 INV. @ MH = 20.73'
- STA. 28+54.5 (16' RT)
 EXISTING 18" STORM DRAIN
 INLET CATCH BASIN 23 LF 12" RCP (CL. III) S = 0.01 INV. © DI = 23.00' ± (OUT) INV. © MH = 19.55'

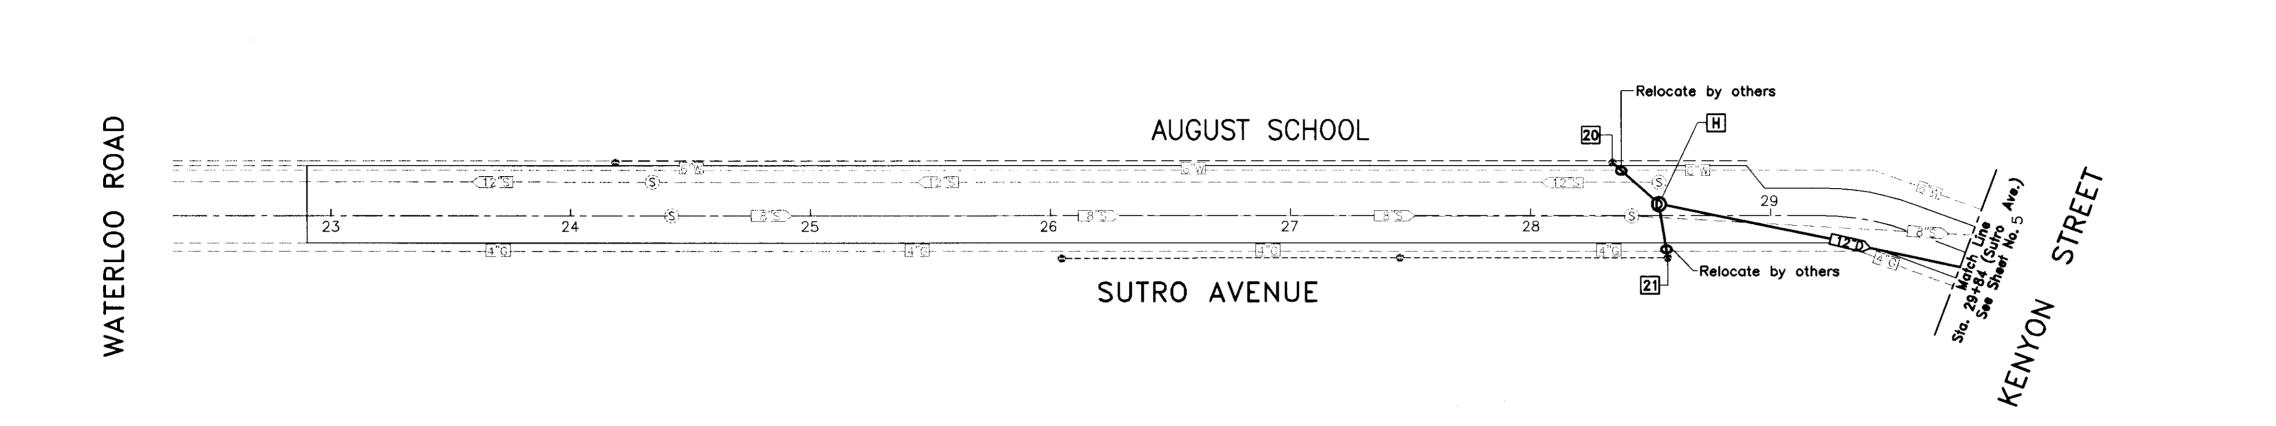


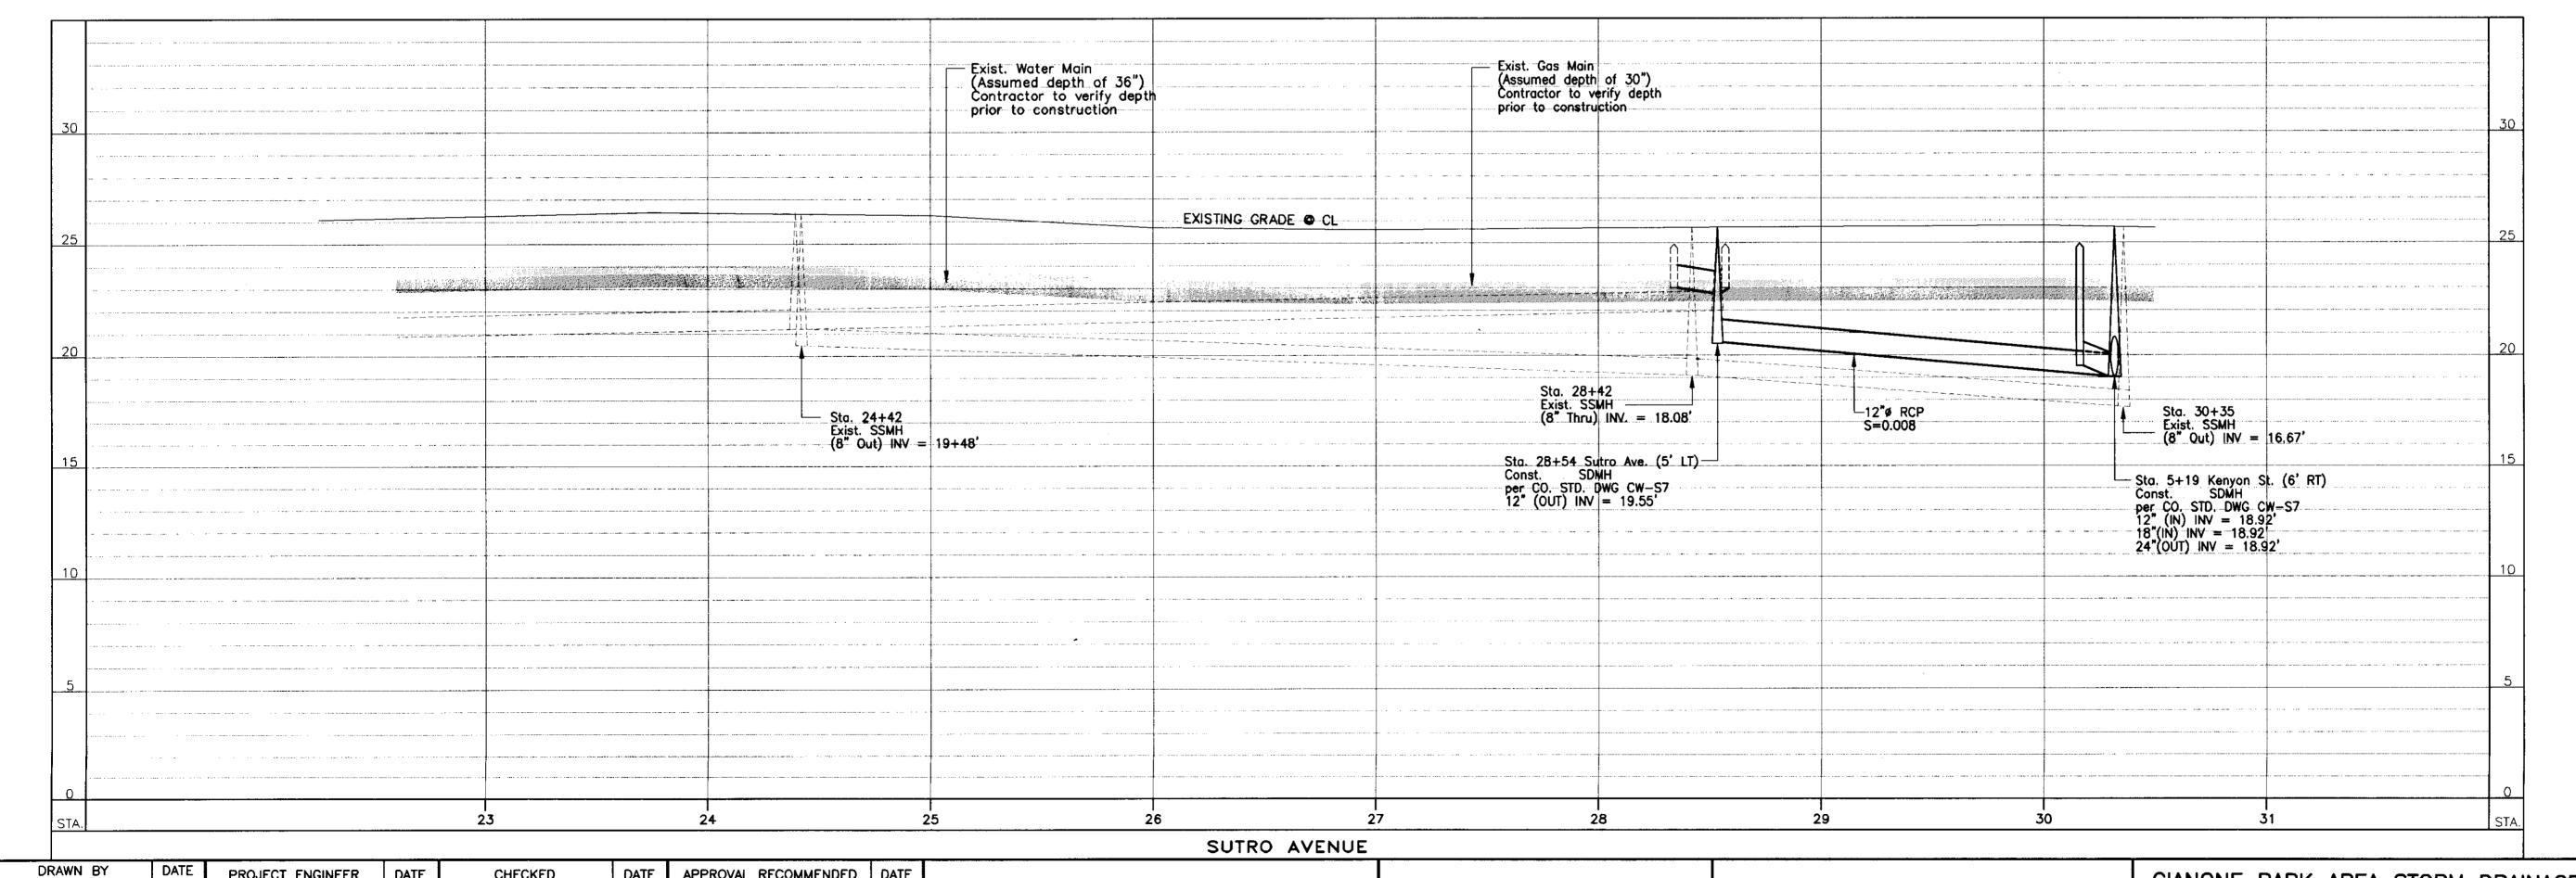

DATE APPROVAL RECOMMENDED DATE PROJECT ENGINEER CHECKED Enrique Silva Vincent Li DRAWER SHEET NO. REVISIONS E:\Projects\2007\CC Gianone 1C 75377\Plans\XGianone 1c Utilities.dwg


COUNTY OF SAN JOAQUIN SCALE : 1"=40' (Horiz.) UTILITIES PLAN AND PROFILE

SHEET TOTAL NO. SHEETS GIANONE PARK AREA STORM DRAINAGE IMPROVEMENTS PHASE 1-C (Federal Aid Project No. SJC-06-03)

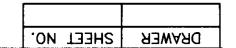

CONSTRUCTION NOTES

- E STA. 5+19 (6' RT) KENYON ST.
 CONSTRUCT STORM DRAIN MAINTENANCE HOLE. SEE PROFILE FOR CALLOUT.
- F STA. 8+50 (5' LT) KENYON ST.
 CONSTRUCT STORM DRAIN MAINTENANCE HOLE. SEE PROFILE FOR CALLOUT.
- 9 STA. 5+19 (22' RT) KENYON ST. CONSTRUCT 18" STORM DRAIN INLET CATCH BASIN 12 LF 12" RCP (CL. III) S = 0.01 INV. • DI = 18.31'INV. \bigcirc MH = 18.19'
- STA. 5+75 (22' LT) KENYON ST. CONSTRUCT 18" STORM DRAIN INLET CATCH BASIN 35 LF 12" RCP (CL. III) S = 0.01INV. 9 DI = 18.66' (OUT)
- 11 STA. 5+40 (22' LT) KENYON ST. CONSTRUCT 18" STORM DRAIN INLET CATCH BASIN 27 LF 12" RCP (CL. III) S = 0.01 INV. \bigcirc DI = 18.36' (IN & OUT) INV. • MH = 18.19'`
- STA. 4+96 (22' LT) KENYON ST. CONSTRUCT 18" STORM DRAIN INLET CATCH BASIN 28 LF 12" RCP (CL. III) S = 0.01 INV. • DI = 18.37' (IN & OUT) INV. \bigcirc MH = 18.19
- 13 STA. 4+71 (22' LT) KENYON ST. CONSTRUCT 18" STORM DRAIN INLET CATCH BASIN 25 LF 12" RCP (CL. III) S = 0.01 INV. Q DI = 18.62' (OÚT)
- STA. 8+34 (19' LT) KENYON ST. CONSTRUCT 18" STORM DRAIN INLET CATCH BASIN 29 LF 12" RCP (CL. III) S = 0.01 INV. © DI = 19.21' (OUT) INV. © MH = 18.92'

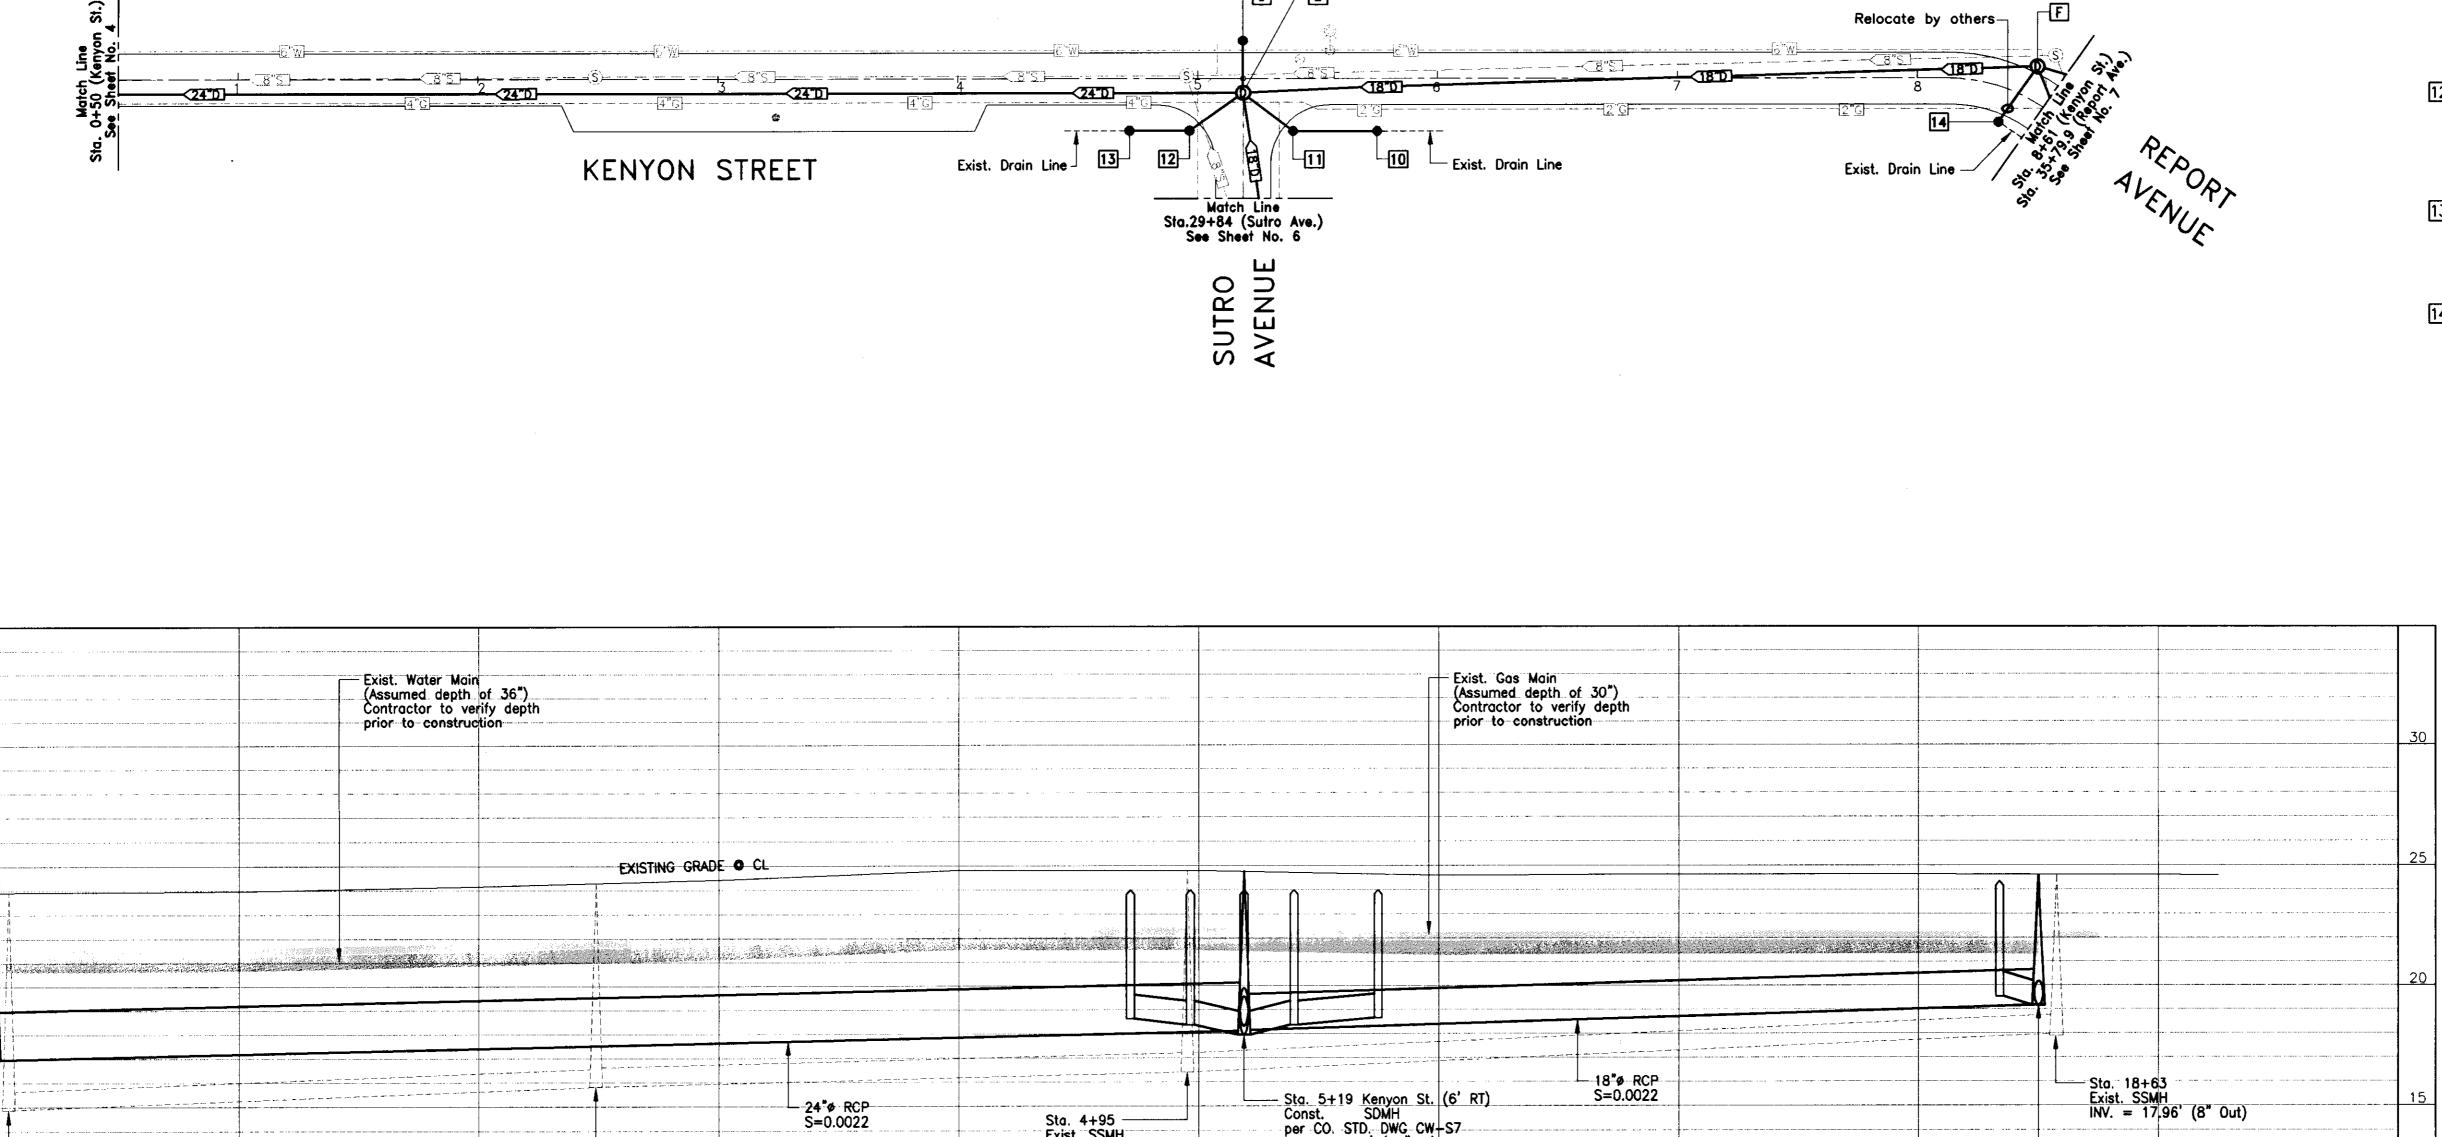

- Sta. 5+19 Kenyon St. (6' RT)
Const. SDMH
per CO. STD. DWG CW-S7
INV = 18.19' (12" IN)
INV = 18.19' (18" IN)
INV = 18.19' (24"OUT) Sta. 4+95 Exist. SSMH INV. = 16.67' (8" Thru) — Sta. 2+49 Exist. SSMH INV. = 15.81" (8" Thru) Sta. 8+50 Kenyon St. (5' LT)
Const. SDMH
per CO. STD. DWG CW-S7
INV = 18.92' (12" IN)
INV = 18.92' (18" OUT) — Sta. 6+70.3 Myran Ave. (2' LT)
Const. SDMH
per CO. STD. DWG CW-S7
INV = 17.05' (24" IN)
INV = 17.05' (24" OUT) JAWING and the KENYON STREET DATE APPROVAL RECOMMENDED DATE CHECKED SCALE : 1"=40' (Horiz.)


PROJECT ENGINEER DATE Enrique Silva 10/6/06 Manual Dolais Vincent Ri DRAWER SHEET NO. ACAD REVISIONS DATE FILE NAME E:\Projects\2007\CC Gianone 1C 75377\Plans\XGianone 1c Utilities.dwg


— Sta. 0+04 Exist. SSMH INV. = 14.86' (8" Out)

COUNTY OF SAN JOAQUIN

UTILITIES PLAN AND PROFILE


GIANONE PARK AREA STORM DRAINAGE IMPROVEMENTS PHASE 1-C SHEET TOTAL SHEETS (Federal Aid Project No. SJC-06-03)

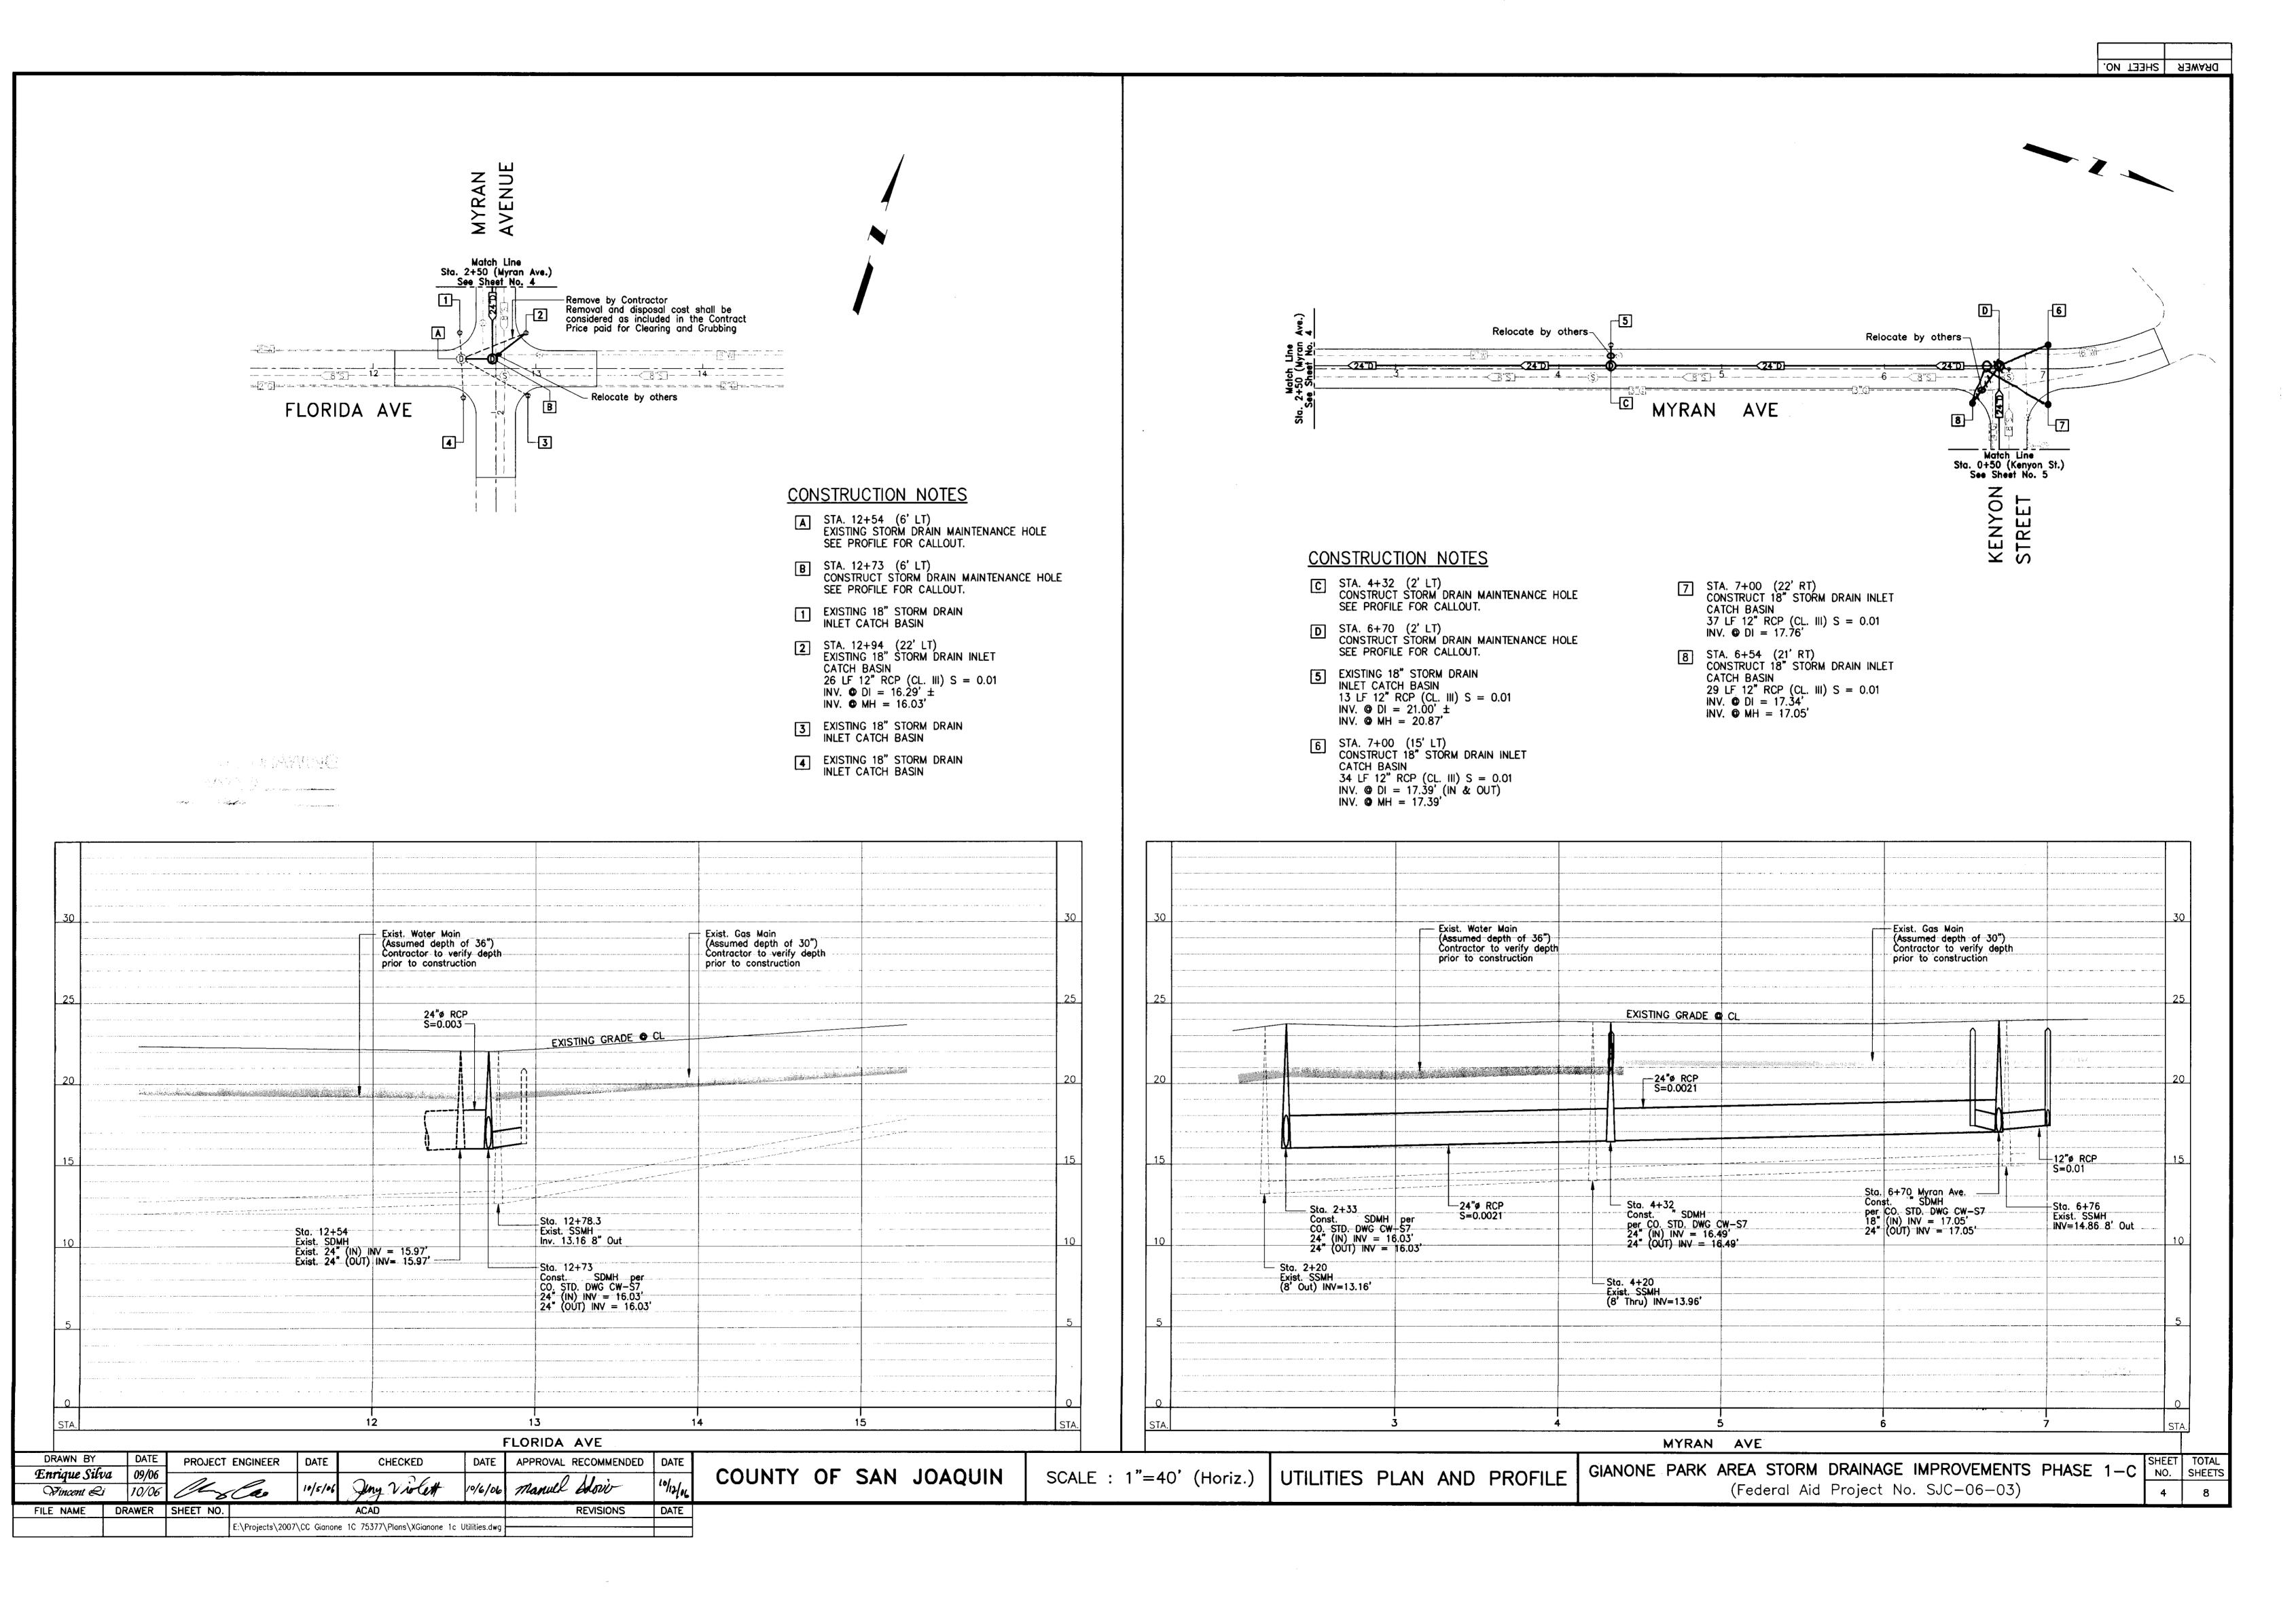

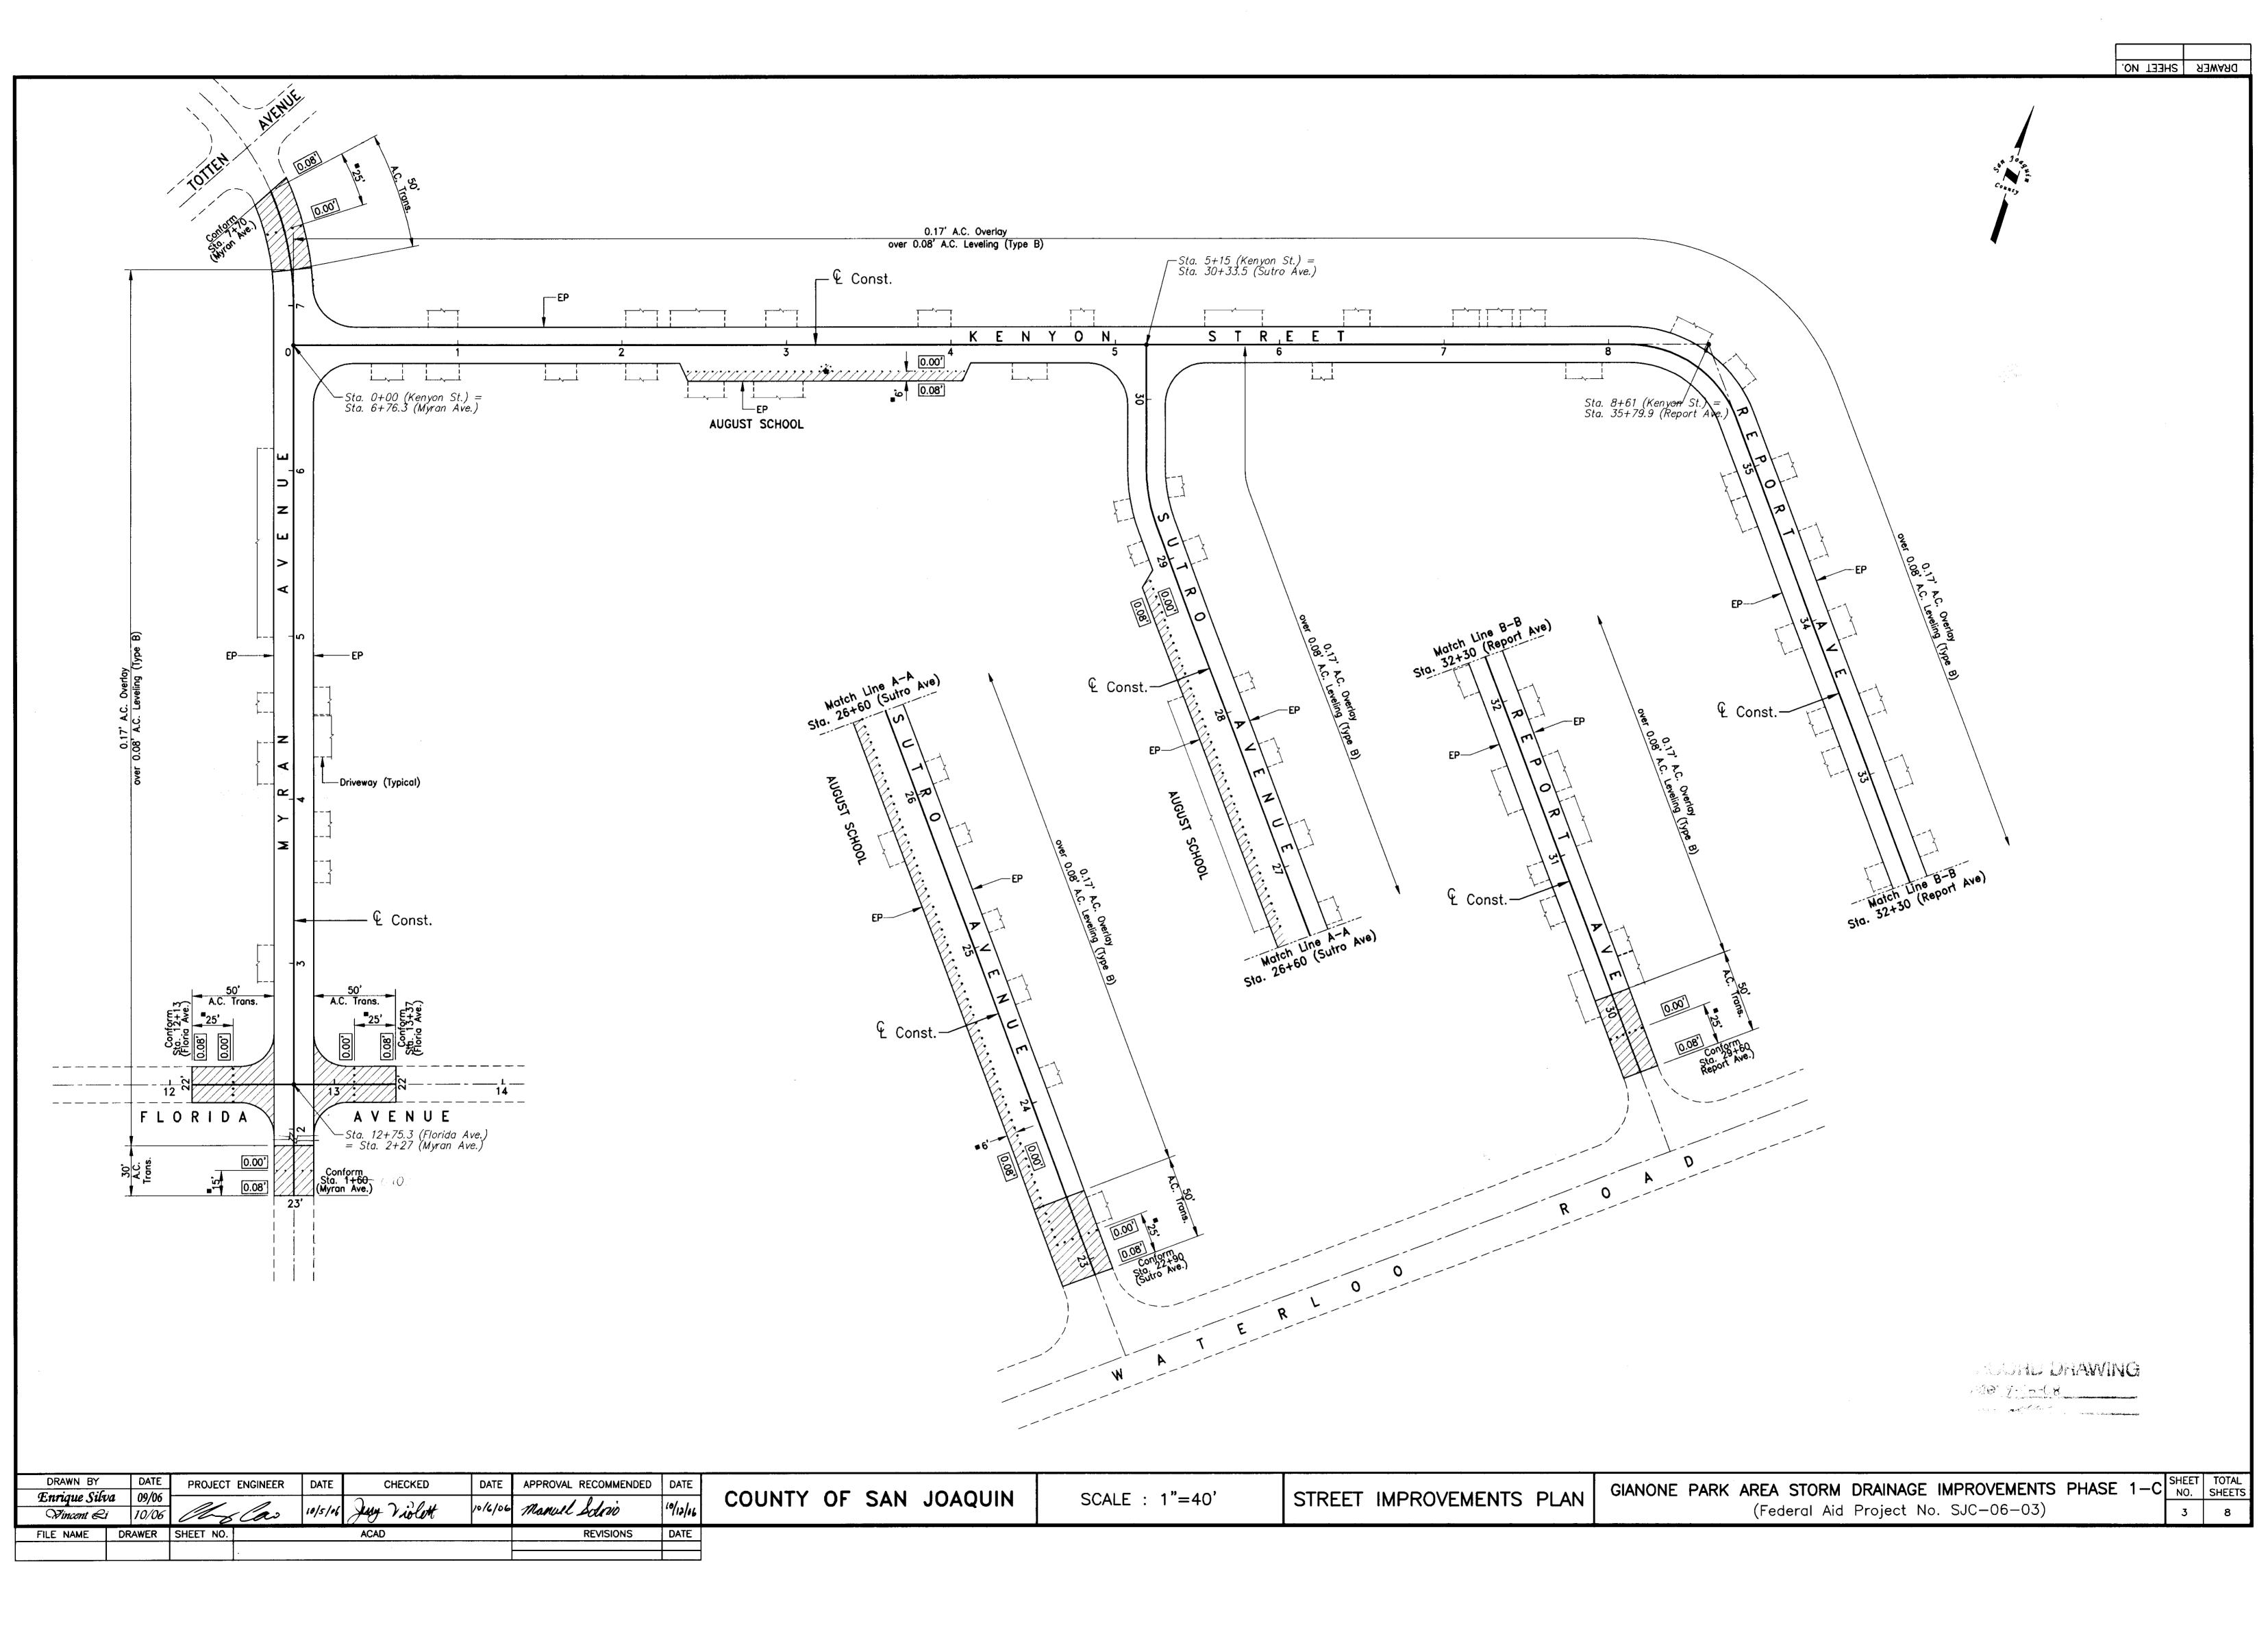

TYPICAL SECTION

Myran Avenue-STA. 1+60 to 7+70Kenyon Street-STA. 0+00 to 2+40 Kenyon Street-STA. 4+08 to 8+61 Sutro Avenue-STA, 28+95 to 30+33 Report Avenue-STA, 29+60 to 35+79

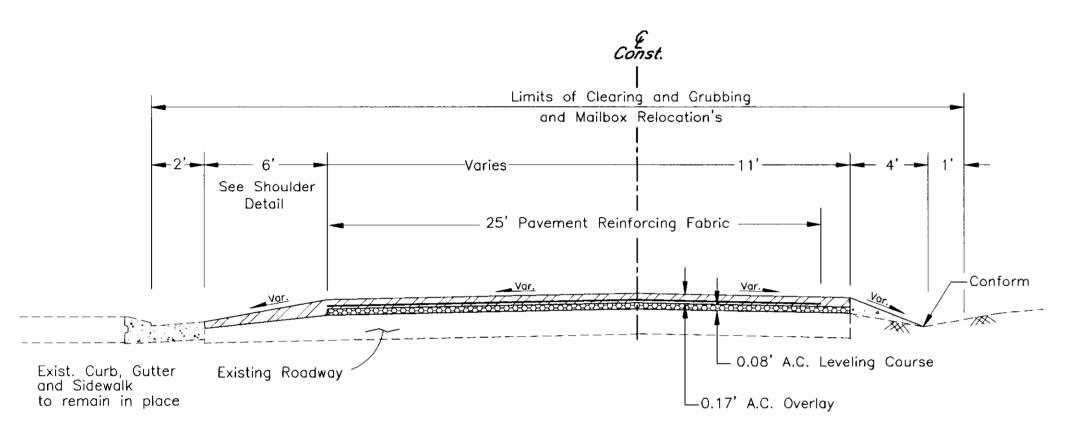


TYPICAL SECTION

Sutro Avenue-STA 22+90 TO 28+95 Kenyon Street-STA. 2+40 TO 4+07

Exist. Curb, Gutter


to remain in place

and Sidewalk

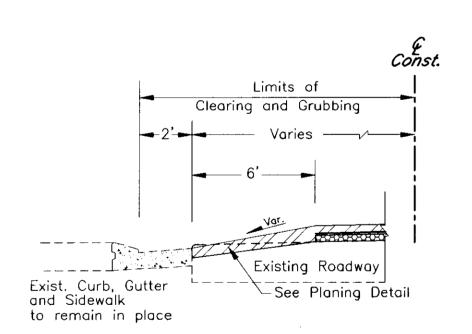

SHOULDER DETAIL

Sutro Avenue Sta. 23+15 to Sta. 28+95 (Lt.) Kenyon Street Sta. 2+40 to Sta. 4+07 (Rt.)

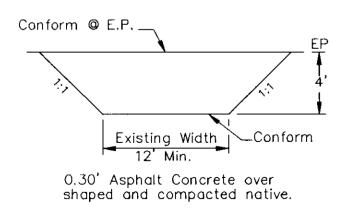


TYPE D

Pavement adjacent to Gutter Lip to a depth of 0.08 below the Gutter Lip. Conform @ E.P.

LONGITUDINAL PLANING DETAIL

Note: Contractor is to plane all Asphalt Concrete

Existing Width 12' Min. Variable depth Asphalt Concrete over existing paved driveway. R= Conform with existing radii TYPE E

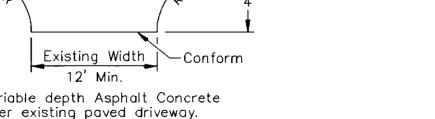

Limits of

-Varies


Existing Roadway

-Grading plane

Clearing and Grubbing

Const.

THE MANNEY 7-16-68 minutes Tur altin

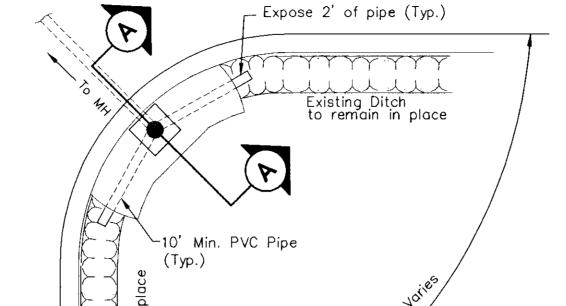

6" Thick Concrete Ditch Lining Existing Ground Structure Backfill 10 GA.x10 GA. 4"x4". Welded Wire Fabric Set at Flowline 12" Dia. PVC Pipe (Class 200) 12" RCP (Class III)

MODIFIED 18" STORM DRAIN INLET

SECTION A-A

Note: The Contract unit price paid for Storm Drainage Inlet shall include full compensation for furnishing all labor, materials, tools, equipment, and incidentals for doing all the work as shown in this detail. SDI grate to be set 0.10' below new E.P.

21. EXISTING TOPOGRAPHIC INFORMATION SHOWN MAY DIFFER FROM ACTUAL CONDITIONS DUE

TO ONGOING CONSTRUCTION IN THE AREA.

PLAN

- 22. CONTRACTOR SHALL PROVIDE DUST CONTROL MEASURES AT ALL TIMES DURING CONSTRUCTION AS PER SECTION 10 OF THE STANDARD SPECIFICATIONS OF THE STATE OF CALIFORNIA AND PER SAN JOAQUIN COUNTY DEPARTMENT OF PUBLIC WORKS
- 23. ANY CHANGES TO THE APPROVED IMPROVEMENT PLANS AND SPECIFICATIONS MUST BE PREPARED AND CERTIFIED BY THE "CIVIL ENGINEER", AND SHALL BE SUBMITTED TO THE DIRECTOR OF PUBLIC WORKS FOR APPROVAL PRIOR TO IMPLEMENTATION.
- 24. EXISTING DRAINAGE FACILITIES SHALL BE MAINTAINED DURING PERIODS OF INCLEMENT WEATHER AND RESTORED TO THEIR ORIGINAL CONDITIONS UPON COMPLETION OF THE
- 25. ALL TRAFFIC DELINEATION (SIGNS, STRIPING, RAISED PAVEMENT MARKERS) SHALL BE RESTORED TO THEIR ORIGINAL CONDITION UPON COMPLETION OF THE WORK.
- 26. THE CONTRACTOR SHALL NOTIFY THE SAN JOAQUIN COUNTY DEPARTMENT OF PUBLIC WORKS 24 HOURS IN ADVANCE OF PERFORMING ANY WORK REQUIRED IN THE PLANS. PHONE: (209)468-3022.
- 27. CONTRACTOR SHALL PREPARE A STORM WATER POLLUTION PREVENTION PLAN (SWPPP) FOR APPROVAL BY SAN JOAQUIN COUNTY DEPARTMENT OF PUBLIC WORKS PRIOR TO THE START OF CONSTRUCTION.
- 28. ALL EXISTING TREES, SHRUBS, FENCES, WALKWAYS, DRIVEWAY PIPES, AND OTHER FRONTAGE IMPROVEMENTS SHALL REMAIN IN PLACE UNLESS OTHERWISE SHOWN ON THE PLANS OR AS DIRECTED BY THE ENGINEER. ALL REMOVAL AND DISPOSAL COST SHALL BE CONSIDERED AS INCLUDED IN CLEARING AND GRUBBING.

GENERAL NOTES

- 1. ALL NEW IMPROVEMENTS SHALL BE IN ACCORDANCE WITH THE REQUIREMENTS OF THESE PLANS AND SPECIFICATIONS, AND THE LATEST EDITION OF SAN JOAQUIN COUNTY STANDARD SPECIFICATIONS AND PLANS AND THE JULY 2002 STATE OF CALIFORNIA DEPARTMENT OF TRANSPORTATION STANDARD PLANS AND SPECIFICATIONS.
- 2. THE INTENT IS THAT THESE PLANS REQUIRE ALL LABOR AND MATERIALS (EXCEPT AS SPECIFIED IN THE SPECIFICATIONS) NECESSARY AND PROPER FOR THE WORK CONTEMPLATED AND THAT THE WORK BE COMPLETED IN ACCORDANCE WITH THEIR TRUE INTENT AND PURPOSE. THE CONTRACTOR SHALL NOTIFY THE ENGINEER IMMEDIATELY REGARDING ANY DISCREPANCIES AND AMBIGUITIES WHICH MAY EXIST IN THE PLANS OR SPECIFICATIONS. IF THE PLANS DESCRIBE PORTIONS OF THE WORK IN GENERAL TERMS BUT NOT IN COMPLETE DETAIL, IT IS UNDERSTOOD THAT ONLY THE BEST GENERAL PRACTICES TO PREVAIL AND THAT ONLY MATERIALS AND WORKMANSHIP OF THE FIRST QUALITY ARE TO BE USED.
- 3. THE TYPES, LOCATION, SIZES, AND/OR DEPTHS OF EXISTING UNDERGROUND UTILITIES AS SHOWN ON THESE PLANS WERE OBTAINED BY THE DESIGN ENGINEER FROM "OUTSIDE SOURCES" BELIEVED TO BE RELIABLE. HOWEVER, THE CONTRACTOR IS CAUTIONED THAT ONLY ACTUAL EXCAVATION WILL REVEAL THE TYPES, EXTENT, SIZES, LOCATION, AND DEPTHS OF SUCH UNDERGROUND UTILITIES.
- 4. THE CONTRACTOR SHALL BE RESPONSIBLE FOR VERIFYING THE LOCATION OF ALL EXISTING UNDERGROUND UTILITIES AND SHALL CONTACT THE RESPECTIVE UTILITY COMPANIES PRIOR TO COMMENCEMENT OF WORK. HE/SHE SHALL BE RESPONSIBLE FOR THE LOCATION AND PRESERVATION OF ALL SUCH FACILITIES IN THE AREA OF CONSTRUCTION, AND SHALL NOTIFY UTILITY COMPANIES FORTY-EIGHT (48) HOURS IN ADVANCE OF ANY CONSTRUCTION (UNDERGROUND SERVICE ALERT 1-800-642-2444).
- CONSTRUCTION SAFETY ORDERS (TITLE 8 CALIFORNIA ADMINISTRATION CODE SECTION 1540), ISSUED BY THE OCCUPATIONAL SAFETY AND HEALTH STANDARDS BOARD PURSUANT TO THE CALIFORNIA OCCUPATIONAL SAFETY AND HEALTH ACT OF 1973, AS AMENDED. WHICH STATES: PRIOR TO OPENING AN EXCAVATION, EFFORT SHALL BE MADE TO DETERMINE WHETHER UNDERGROUND INSTALLATION; I.E., SEWER, WATER, FUEL, ELECTRIC LINES, ETC., WILL BE ENCOUNTERED AND, IF SO, WHERE SUCH UNDERGROUND INSTALLATIONS ARE LOCATED. WHEN THE EXCAVATION APPROACHES THE APPROXIMATE LOCATION OF SUCH AN INSTALLATION. THE EXACT LOCATION SHALL BE DETERMINED BY CAREFUL PROBING OR

5. THE CONTRACTOR'S ATTENTION IS DIRECTED TO SECTION 1540 (A)(1) OF THE


48 HOURS PRIOR TO THE START OF ACTUAL EXCAVATION. 6. THE CONTRACTOR SHALL PROVIDE SHORING, BRACING, SLOPING OR PROVISIONS TO PROTECT WORKERS FOR ALL AREAS TO BE EXCAVATED TO A DEPTH OF FIVE FEET OR MORE. SAID PROTECTION TO BE DONE IN ACCORDANCE WITH THE REQUIREMENTS OF

HAND DIGGING; AND WHEN IT IS UNCOVERED, ADEQUATE PROTECTION SHALL BE PROVIDED FOR THE EXISTING INSTALLATION. ALL KNOWN OWNERS OF UNDERGROUND FACILITIES IN THE AREA CONCERNED SHALL BE ADVISED OF PROPOSED WORK AT LEAST

7. CONTRACTOR SHALL BE RESPONSIBLE FOR COORDINATION OF THE REMOVAL AND /OR RELOCATION OF ALL EXISTING UTILITIES WITH RESPECTIVE UTILITY COMPANIES.

LOCAL, STATE, AND FEDERAL REGULATIONS (CAL-OSHA, OSHA).

- 8. FINAL PAVEMENT WORK SHALL NOT OCCUR WITHIN THE ROAD RIGHT-OF-WAY PRIOR TO COMPLETION OF UTILITY RELOCATION WITHOUT SPECIFIC APPROVAL OF THE SAN JOAQUIN COUNTY PUBLIC WORKS DEPARTMENT. ALL TRENCHES AND CROSS TRENCHES WITHIN EXISTING STREETS SHALL BE BACK FILLED AND PAVED WITH TEMPORARY PAVING THE SAME DAY THE PAVEMENT CUT IS MADE OR COVERED WITH STEEL PLATES AS DIRECTED BY SAN JOAQUIN COUNTY PUBLIC WORKS DEPARTMENT.
- 9. ASBESTOS CEMENT MATERIALS SHALL NOT BE USED IN THE CONSTRUCTION OF ANY FACILITIES WITHIN THIS PROJECT.
- 10. THE CONTRACTOR SHALL EXPOSE ALL EXISTING SEWER, STORM DRAINS, AND CLEARANCES OF KNOWN CROSSINGS WITH OTHER UTILITIES BEFORE INSTALLING NEW PIPELINES. IF THE CONTRACTOR DETERMINES THE EXISTING INVERTS ARE NOT IN CONFORMANCE WITH THE PLANS, HE SHALL NOTIFY THE ENGINEER BEFORE PERFORMING ANY WORK. THE CONTRACTOR SHALL BE RESPONSIBLE FOR ANY FIELD CHANGES MADE WITHOUT WRITTEN AUTHORIZATION FROM THE OWNER REPRESENTATIVE.
- 11. THE CONTRACTOR SHALL BE RESPONSIBLE FOR ANY DAMAGE TO THE SITE AND SURROUNDING AREAS RESULTING FROM THE CONTRACTOR'S OPERATIONS PRIOR TO ACCEPTANCE OF THE CONTRACTOR'S WORK.
- 12. DURING CONSTRUCTION, THE CONTRACTOR SHALL MAINTAIN THE INTEGRITY OF EXISTING FACILITIES. THE CONTRACTOR IS RESPONSIBLE TO REPAIR, AT THE CONTRACTOR'S EXPENSE, TO THE SATISFACTION OF SAN JOAQUIN COUNTY, ANY FACILITIES DAMAGED DURING CONSTRUCTION.

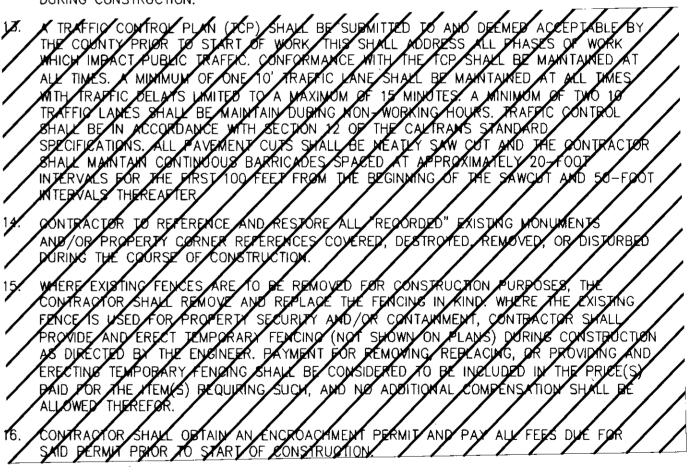

- ALL WORK IN COUNTY RIGHT-OF-WAY SHALL BE SUBJECT TO THE APPROVAL AND ACCEPTANCE OF THE SAN JOAQUIN COUNTY PUBLIC WORKS DEPARTMENT.
- 18. CONTRACTOR AGREES TO ASSUME SOLE AND COMPLETE RESPONSIBILITY FOR JOB SITE CONDITIONS DURING THE COURSE OF CONSTRUCTION OF THIS PROJECT, INCLUDING SAFETY OF ALL PERSONS AND PROPERTY. THIS REQUIREMENT SHALL APPLY CONTINUOUSLY AND SHALL NOT BE LIMITED TO NORMAL WORKING HOURS. THE CONTRACTOR SHALL DEFEND, INDEMNIFY AND HOLD HARMLESS THE COUNTY OF SAN JOAQUIN, ITS ELECTED OFFICIALS, OFFICERS, EMPLOYEES, AND AGENTS FROM ANY AND ALL CLAIMS, COSTS OF LITIGATION, DAMAGES, AND ATTORNEY'S FEE, FOR PERSONAL INJURY OR PROPERTY DAMAGE OF WHATEVER NATURE WHICH ARE CLAIMED TO HAVE OCCURRED DURING THE TERM OF THIS
- 19. THE CONTRACTOR SHALL PROVIDE AND MAINTAIN TEMPORARY SIGNS FOR ALL REGULATORY TRAFFIC SIGNS REMOVED DURING THE CONSTRUCTION, AS APPROVED BY THE ENGINEER.
- 20. CONTRACTOR SHALL CLEAN ALL EXISTING FRONTAGE DRAINAGE PIPES. COMPENSATION SHALL BE CONSIDERED AS INCLUDED IN LUMP SUM PRICE PAID FOR CLEANING EXISTING DRAINAGE FACILITY.

DRIVEWAY DETAIL

DRAWN BY DATE DATE CHECKED DATE APPROVAL RECOMMENDED | DATE PROJECT ENGINEER Enrique Silva 09/06 10/6/06 Manuel Stris FILE NAME DRAWER SHEET NO. ACAD DATE REVISIONS

COUNTY OF SAN JOAQUIN

NO SCALE

TYPICAL SECTION & DETAILS

GIANONE PARK AREA STORM DRAINAGE IMPROVEMENTS PHASE 1-C (Federal Aid Project No. SJC-06-03)

COUNTY OF SAN JOAQUIN DEPARTMENT OF PUBLIC WORKS

STOCKTON, CALIFORNIA

PROJECT PLANS FOR

GIANONE PARK AREA STORM DRAINAGE IMPROVEMENTS PHASE 1-C

FEDERAL AID PROJECT No. SJC-06-03


INDEX OF SHEETS

SHEET TITLE (TO BE SUPLEMENTED BY STANDARD PLANS DATED JULY 2002)

COVER SHEET TYPICAL SECTIONS & DETAILS STREET IMPROVEMENTS PLAN UTILITIES PLAN AND PROFILE -FLORIDA AVENUE AND MYRAN AVENUE UTILITIES PLAN AND PROFILE - KENYON STREET UTILITIES PLAN AND PROFILE - SUTRO AVENUE UTILITIES PLAN AND PROFILE - REPORT AVENUE SUMMARY OF QUANTITIES LEGEND

DECODIDIO

	DESCRIPTION
0.08	DEPTH OF ASPHALT CONCRETE PAVEMENT PLANING
	VARIABLE DEPTH ASPHALT CONCRETE OVERLAY
	LIMITS OF ASPHALT CONCRETE PAVEMENT PLANING
12" D	NEW STORM DRAIN LINE
8" S	EXISTING SEWER LINE
(S)	EXISTING MAINTENANCE HOLE SEWER
	NEW MAINTENANCE HOLE STORM
(EXISTING STORM DRAIN INLET TO BE CLEANED BY CONTRACTOR
(<u>D</u>)	EXISTING MAINTENANCE HOLE STORM
	NEW MODIFIED 18" STORM DRAIN INLET
- [6 <u>"</u> W]	EXISTING WATER MAIN
•	EXISTING WATER VALVE
•	EXISTING FIRE HYDRANT
	EXISTING GAS SERVICE

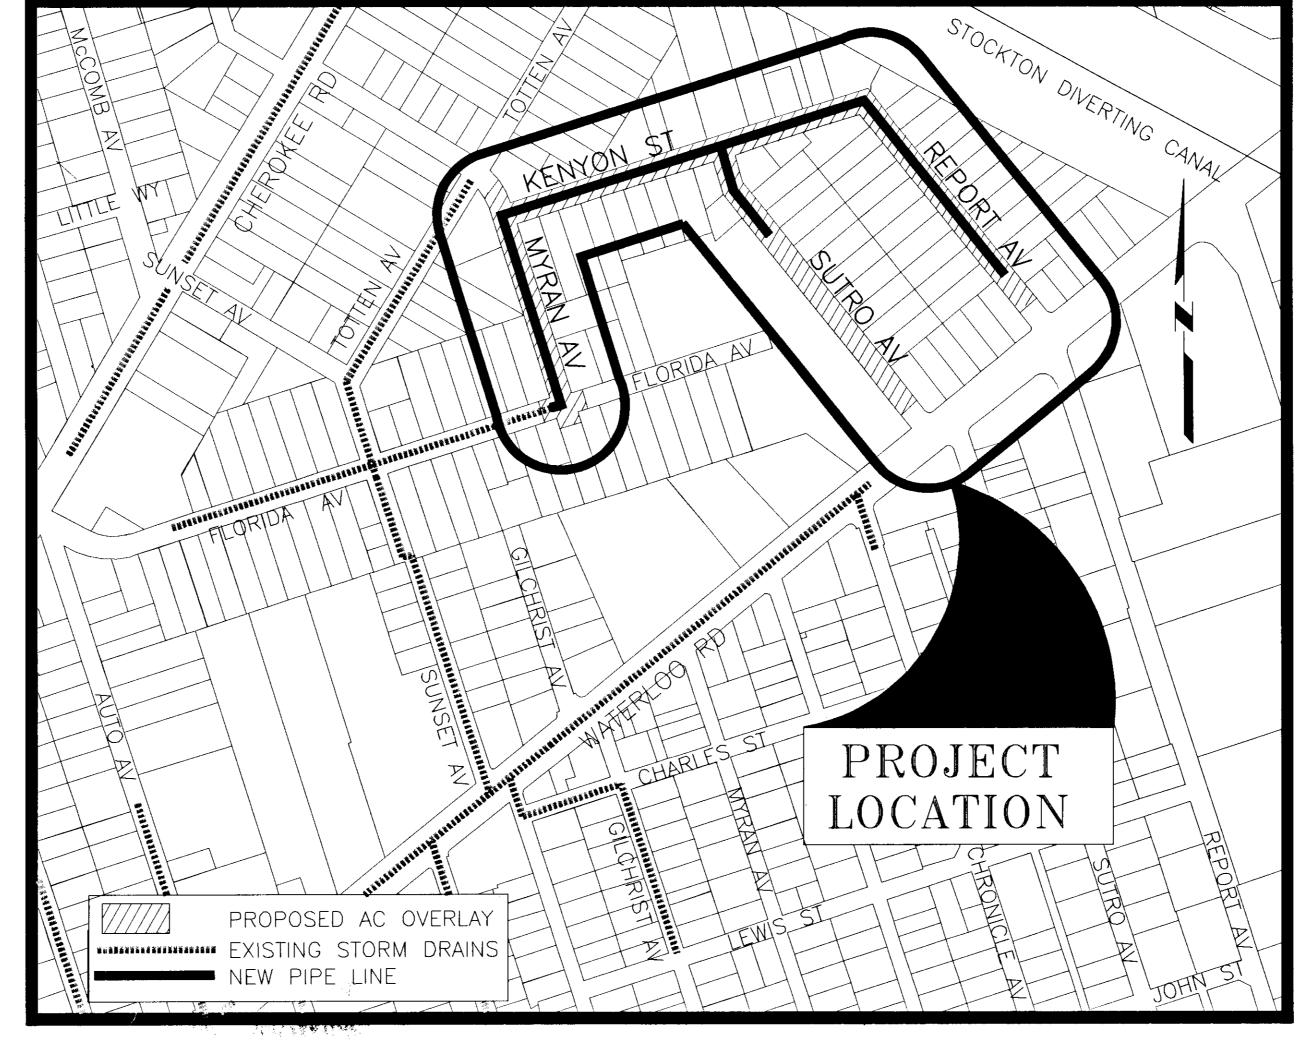

PROJECT LOCATION MAP


The Contractor shall possess a Class A or a Class C-34 licence at the time this contract is awarded.

NOT TO SCALE

MANU JAMAN 9-16-08 Tim will.

COUNTY OF SAN JOAQUIN

THOMAS RYAN FLINN R.C.E. C23341 DIRECTOR OF PUBLIC WORKS

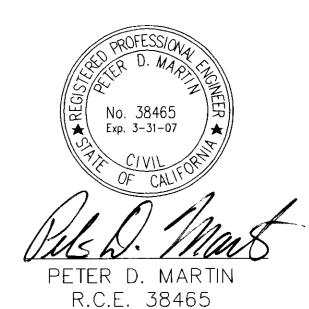

D-18, CW-S7, CW-D14 R-29, CW-R36, CW-M7, W-7, CW-S10


APPLICABLE STANDARD PLANS

CALTRANS STANDARD PLANS

A73C, A10A, A10B, T13, A62A

UTILITY	CONTACT	PHONE NUMBER
SEWER	CITY OF STOCKTON	(209) 937-8779
WATER	BRETT DAHLEN	(209) 464-0994
	JOHN E. VIRGILIO	(408) 367-8360
CABLE	LARRY BYRD	(209) 477-1747 x 243
PG&E ELECTRIC	RON COLLINS	(209) 942-1628
PG&E GAS	PAUL MAUPIN	(209) 942-1541
TELEPHONE	BILL BROMANN	(209) 474-4119



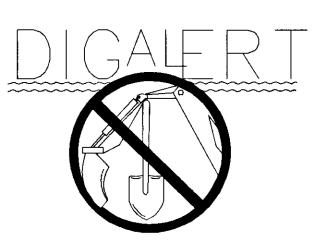

PROJECT ENGINEER APPROVAL RECOMMENDED CHECKED DATE 10/5/06 Juny Violet 10/6/06 Manuel solais 10/12/06

EXISTING UTILITIES TO BE RELOCATED BY OTHERS

SHEET NO. 1 of 8