


NOTES

- 1. BALES SHALL BE PLACED TIGHTLY ABUTTED TOSETHER IN A TRENCH EXCAVATED A MINIMUM OF 4 INCHES BELOW THE INLET. BALES SHALL BE PLACED SO THAT BINDINGS ARE HORIZONTAL
- 2. EACH BALE SHALL BE ANCHORED BY A MINIMUM OF TWO 2" x 2" STAKES OR TWO #4 J-BARS DRIVEN THROUGH THE BALES AND INTO THE GROUND A MINIMUM DEPTH OF 18". TOPS OF STAKES OR J-BARS SHALL BE COUNTERSUNK A MINIMUM OF 1" BELOW THE TOP OF THE BALE.
- 3. OUTER PERIMETER OF THE BALES SHALL BE BACK FILLED AND COMPACTED TO A DEPTH OF APPROXIMATELY 4 INCHES WITH EXCAVATED MATERIAL
- 4. CONTRACTOR SHALL INSPECT BALES WEEKLY AND AFTER EACH RAINFALL TO DETERMINE IF REPAIR OR SEDIMENT REMOVAL IS REQUIRED. SEDIMENT SHALL BE REMOVED WHEN IT HAS BUILT UP TO A DEPTH OF APPROXIMATELY 6". BALES SHALL BE REPLACED WHEN THEY HAVE BEEN DAMAGED, COLLAPSED OR DECOMPOSED.

STRAW BALE

INLET FILTER NO SCALE

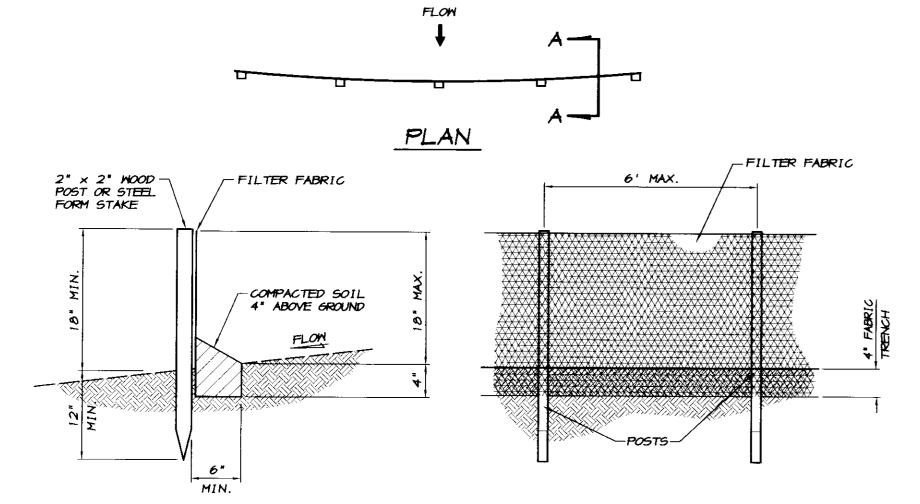

SECTION A-A


FRONT VIEW

NOTES


- 1. FILTER BARRIER SHALL BE CONSTRUCTED LONG ENOUGH TO EXTEND ACROSS THE EXPECTED FLOW PATH AND AS APPROVED BY THE ADMINISTRATOR.
- 2. FILTER FABRIC SHALL BE PROPYLENE, NYLON, POLYESTER OR ETHYLENE YARN WITH A MINIMUM TENSILE STRENGTH OF 50 LBS. PER LINEAR FOOT AT 20 PERCENT MAXIMUM ELONGATION AND CONTAINING ULTRAVIOLET INHIBITORS. FILTER FABRIC SHALL RETAIN A MINIMUM OF 85% OF THE SOIL, BY WEIGHT, BASED ON SIEVE ANALYSIS, BUT IS NOT FINER THAN AN EQUIVALENT OPENING
- 3. SUPPORT POSTS SHALL BE A MINIMUM 30 INCHES LONG 2" x 2" WOOD POSTS OR STEEL FORM STAKES DRIVEN A MINIMUM OF 12 INCHES INTO THE GROUND. POSTS SHALL BE SPACED A MAXIMUM 6 FEET APART.
- 4. A 4 INCH FABRIC TRENCH SHALL BE EXCAVATED ALONG THE UPHILL SIDE OF FILTER BARRIER POSTS. THE BOTTOM EDGE OF THE FABRIC SHALL EXTEND TO AND ACROSS THE BOTTOM OF THE TRENCH. THE TRENCH SHALL BE BACK FILLED TO 4 INCHES ABOVE GROUND AND COMPACTED TO BURY AND SECURE THE BOTTOM OF THE FILTER FABRIC.
- 5. CONTRACTOR SHALL MAKE INSPECTIONS WEEKLY DURING THE WET SEASON, MONTHLY DURING THE DRY SEASON AND IMMEDIATELY AFTER EACH RAINFALL TO DETERMINE IF REPAIRS AND SEDIMENT REMOVAL IS REQUIRED. SEDIMENT SHALL BE REMOVED BEFORE IT HAS REACHED ONE THIRD THE HEIGHT OF

SILT FENCE


FILTER BARRIER NO SCALE

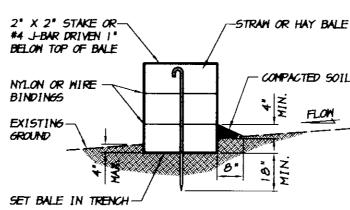

SECTION A-A

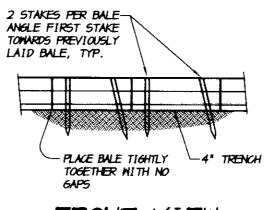

FRONT VIEW

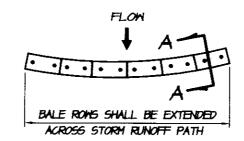


STRAW BALE ALIGNMENT

- PLACE BALES IN 4 INCH DEEP TRENCH ALONG THE CONTOUR OF THE SLOPE IN THE SHAPE OF AN ARC WITH THE ENDS UPHILL OF THE ARC'S CENTER. BALES SHALL BE PLACED SO THAT BINDINGS ARE HORIZONTAL
- 2. BALES SHALL BE ANCHORED BY TWO 2"X 2" STAKES OR #4 J-BAR DRIVEN THROUGH THE BALE AND IN TO THE GROUND A MINIMUM DEPTH OF 18 INCHES. STAKES OR J-BARS SHALL BE DRIVEN I INCH OR MORE BELOW THE TOP OF THE BALE. THE FIRST STAKE OR J-BAR IN EACH BALE SHALL BE DRIVEN AT AN ANGLE TOWARDS THE PREVIOUSLY LAID BALE TO FORCE THE BALES TIGHTLY ABUTTED TOGETHER.
- AFTER BALES ARE STAKED IN PLACE, EXCAVATED SOIL SHALL BE BACKFILLED AGAINST THE UPHILL SIDE TO A MINIMUM HEIGHT OF 4 INCHES.
- CONTRACTOR SHALL INSPECT BALES WEEKLY AND AFTER EACH RAINFALL. REPAIRS SHALL BE MADE AS NECESSARY AND SEDIMENT SHALL BE REMOVED WHEN IT HAS ACCUMULATED TO A DEPTH OF 6 INCHES. BALES SHALL BE REPLACED WHEN THEY HAVE BEEN DAMAGED, COLLAPSED OR DECOMPOSED.

SILT FENCE


STRAW BALE BARRIER NO SCALE

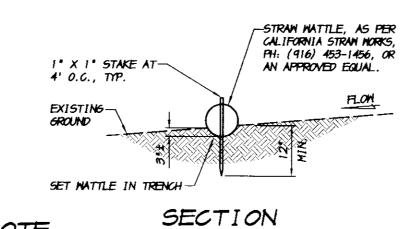


NOTE

 CONTRACTOR SHALL INSPECT WATTLES WEEKLY AND AFTER EACH RAINFALL, REPAIRS SHALL BE MADE AS NECESSARY AND SEDIMENT SHALL BE REMOVED WHEN IT HAS ACCUMULATED TO A DEPTH OF 4 INCHES, WATTLES SHALL BE REPLACED WHEN THEY HAVE BEEN DAMAGED, COLLAPSED OR DECOMPOSED.

STRAW WATTLE DETAIL NO SCALE

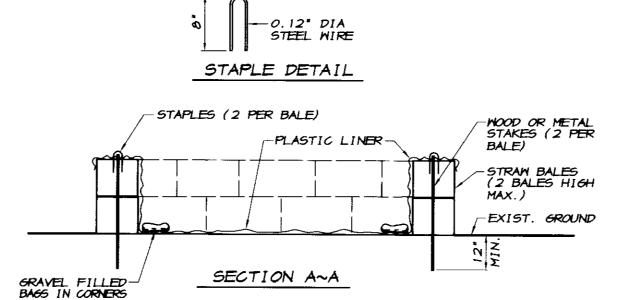


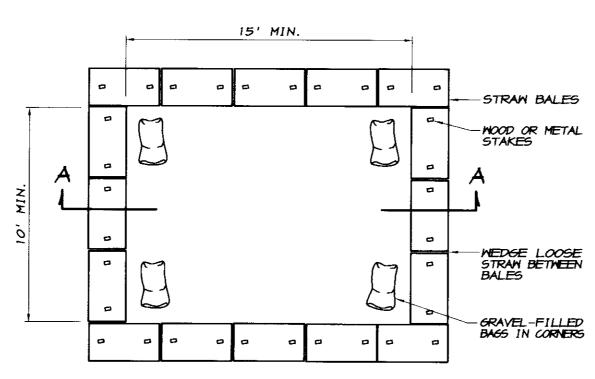


PLAN

CONCRETE WASHOUT DETAIL NO SCALE


PLACEMENT AT OPEN THROAT DROP INLETS PLACEMENT AT STD. DROP INLETS AND PARKING LOTS

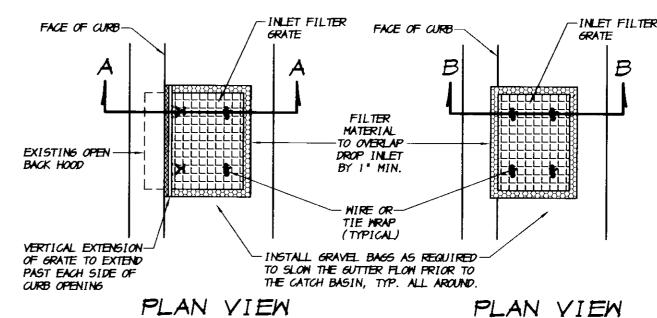

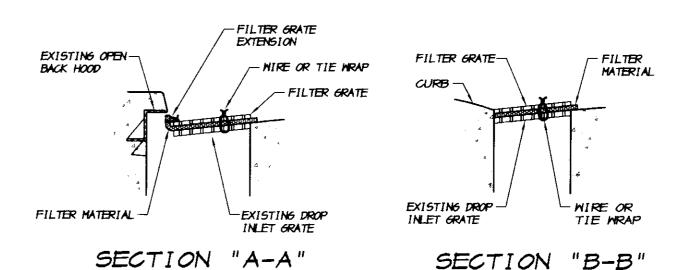


NOTES

- 1. THE MAXIMUM DRAINAGE AREA PER FILTER SHALL BE NO MORE THAN 2 ACRES
- 2. THE FILTER PAD SHALL BE I INCH THICK CLEANABLE POLYESTER FIBER AND ACRYLIC LATEX RESIN OR APPROVED EQUAL. THE FILTER PAD SHALL OVERLAP DROP INLET ON ALL SIDES BY A MINIMUM OF 1 INCH.
- 3. THE FILTER GRATE SHALL BE MADE OF EXPANDED METAL OF REBAR AND BE OF SUFFICIENT STRENGTH TO PREVENT BENDING WHEN DRIVEN OVER, GRATE MATERIAL SHALL NOT EXCEED 0.5" THICK. THE GRATE SHALL HAVE A MINIMUM 60 % OPEN AREA. GRATES USED AT TYPE B AND E INLETS SHALL HAVE A VERTICAL EXTENSION TO COVER THE CURB OPENING. THE FILTER GRATE SHALL BE THE SAME SIZE AS THE DROP INLET GRATE.
- 4. THE FILTER PAD AND GRATE SHALL BE SECURELY ATTACHED TO THE DROP INLET BY WIRE OR TIE-WRAPS.
- 5. INLET FILTERS SHALL BE INSPECTED WEEKLY AND AFTER EACH RAINFALL. REPAIRS AND SEDIMENT AND DEBRIS REMOVAL SHALL BE MADE AS NECESSARY.

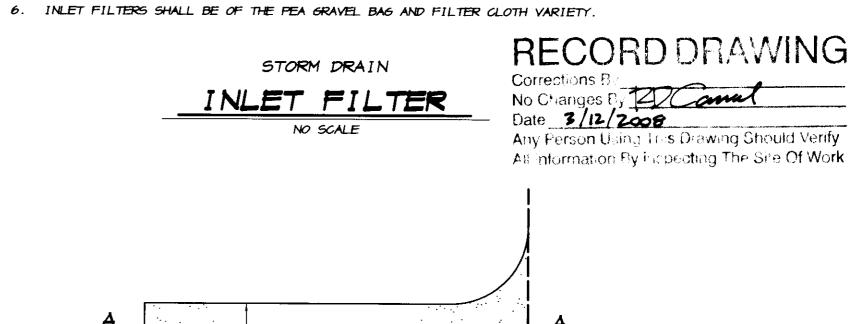

DIRECTION

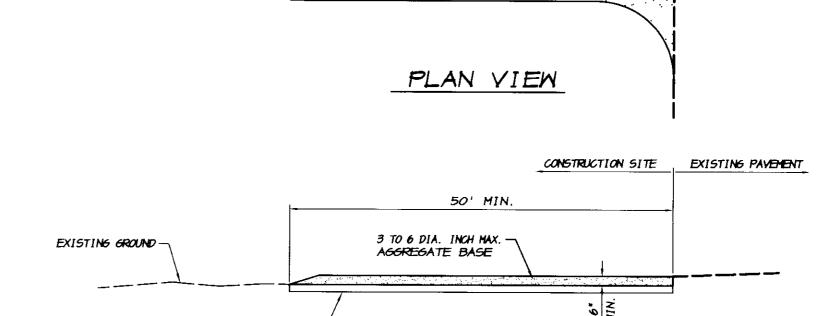

SECTION A-A

NOTES

GEOTEXTILE HATERIAL


- STABILIZED CONSTRUCTION SITE ACCESS SHALL BE CONSTRUCTED OF 3" TO 6" MAX. AGGREGATE BASE MATERIAL CONFORMING TO CITY OR COUNTY STANDARDS. MATERIAL SHALL BE PLACED TO A MINIMUM THICKNESS OF 12". THE METHOD OF PLACING, SPREADING AND COMPACTING AGGREGATE BASE MATERIAL SHALL CONFORM TO SECTION 26 OF THE STATE SPECIFICATIONS
- LENGTH OF ENTRANCE SHALL BE A MINIMUM OF 50 FEET. WIDTH SHALL BE A MIN. OF 15 FEET OR GREATER IF NECESSARY TO COVER ALL VEHICULAR INGRESS AND EGRESS. PROVIDE AMPLE
- 3. THE ENTRANCE SHALL BE KEPT IN 600D CONDITION BY OCCASIONAL TOP DRESSING WITH AGGREGATE
- ACCESSES SHALL BE INSPECTED WEEKLY DURING PERIODS OF HEAVY USAGE, MONTHLY DURING NORMAL USAGE, AND AFTER EACH RAINFALL, WITH MAINTENANCE PROVIDED AS NECESSARY. PERIODIC TOP DRESSING SHALL BE DONE AS NEEDED.

STABILIZED CONSTRUCTION

SITE ACCESS NO SCALE




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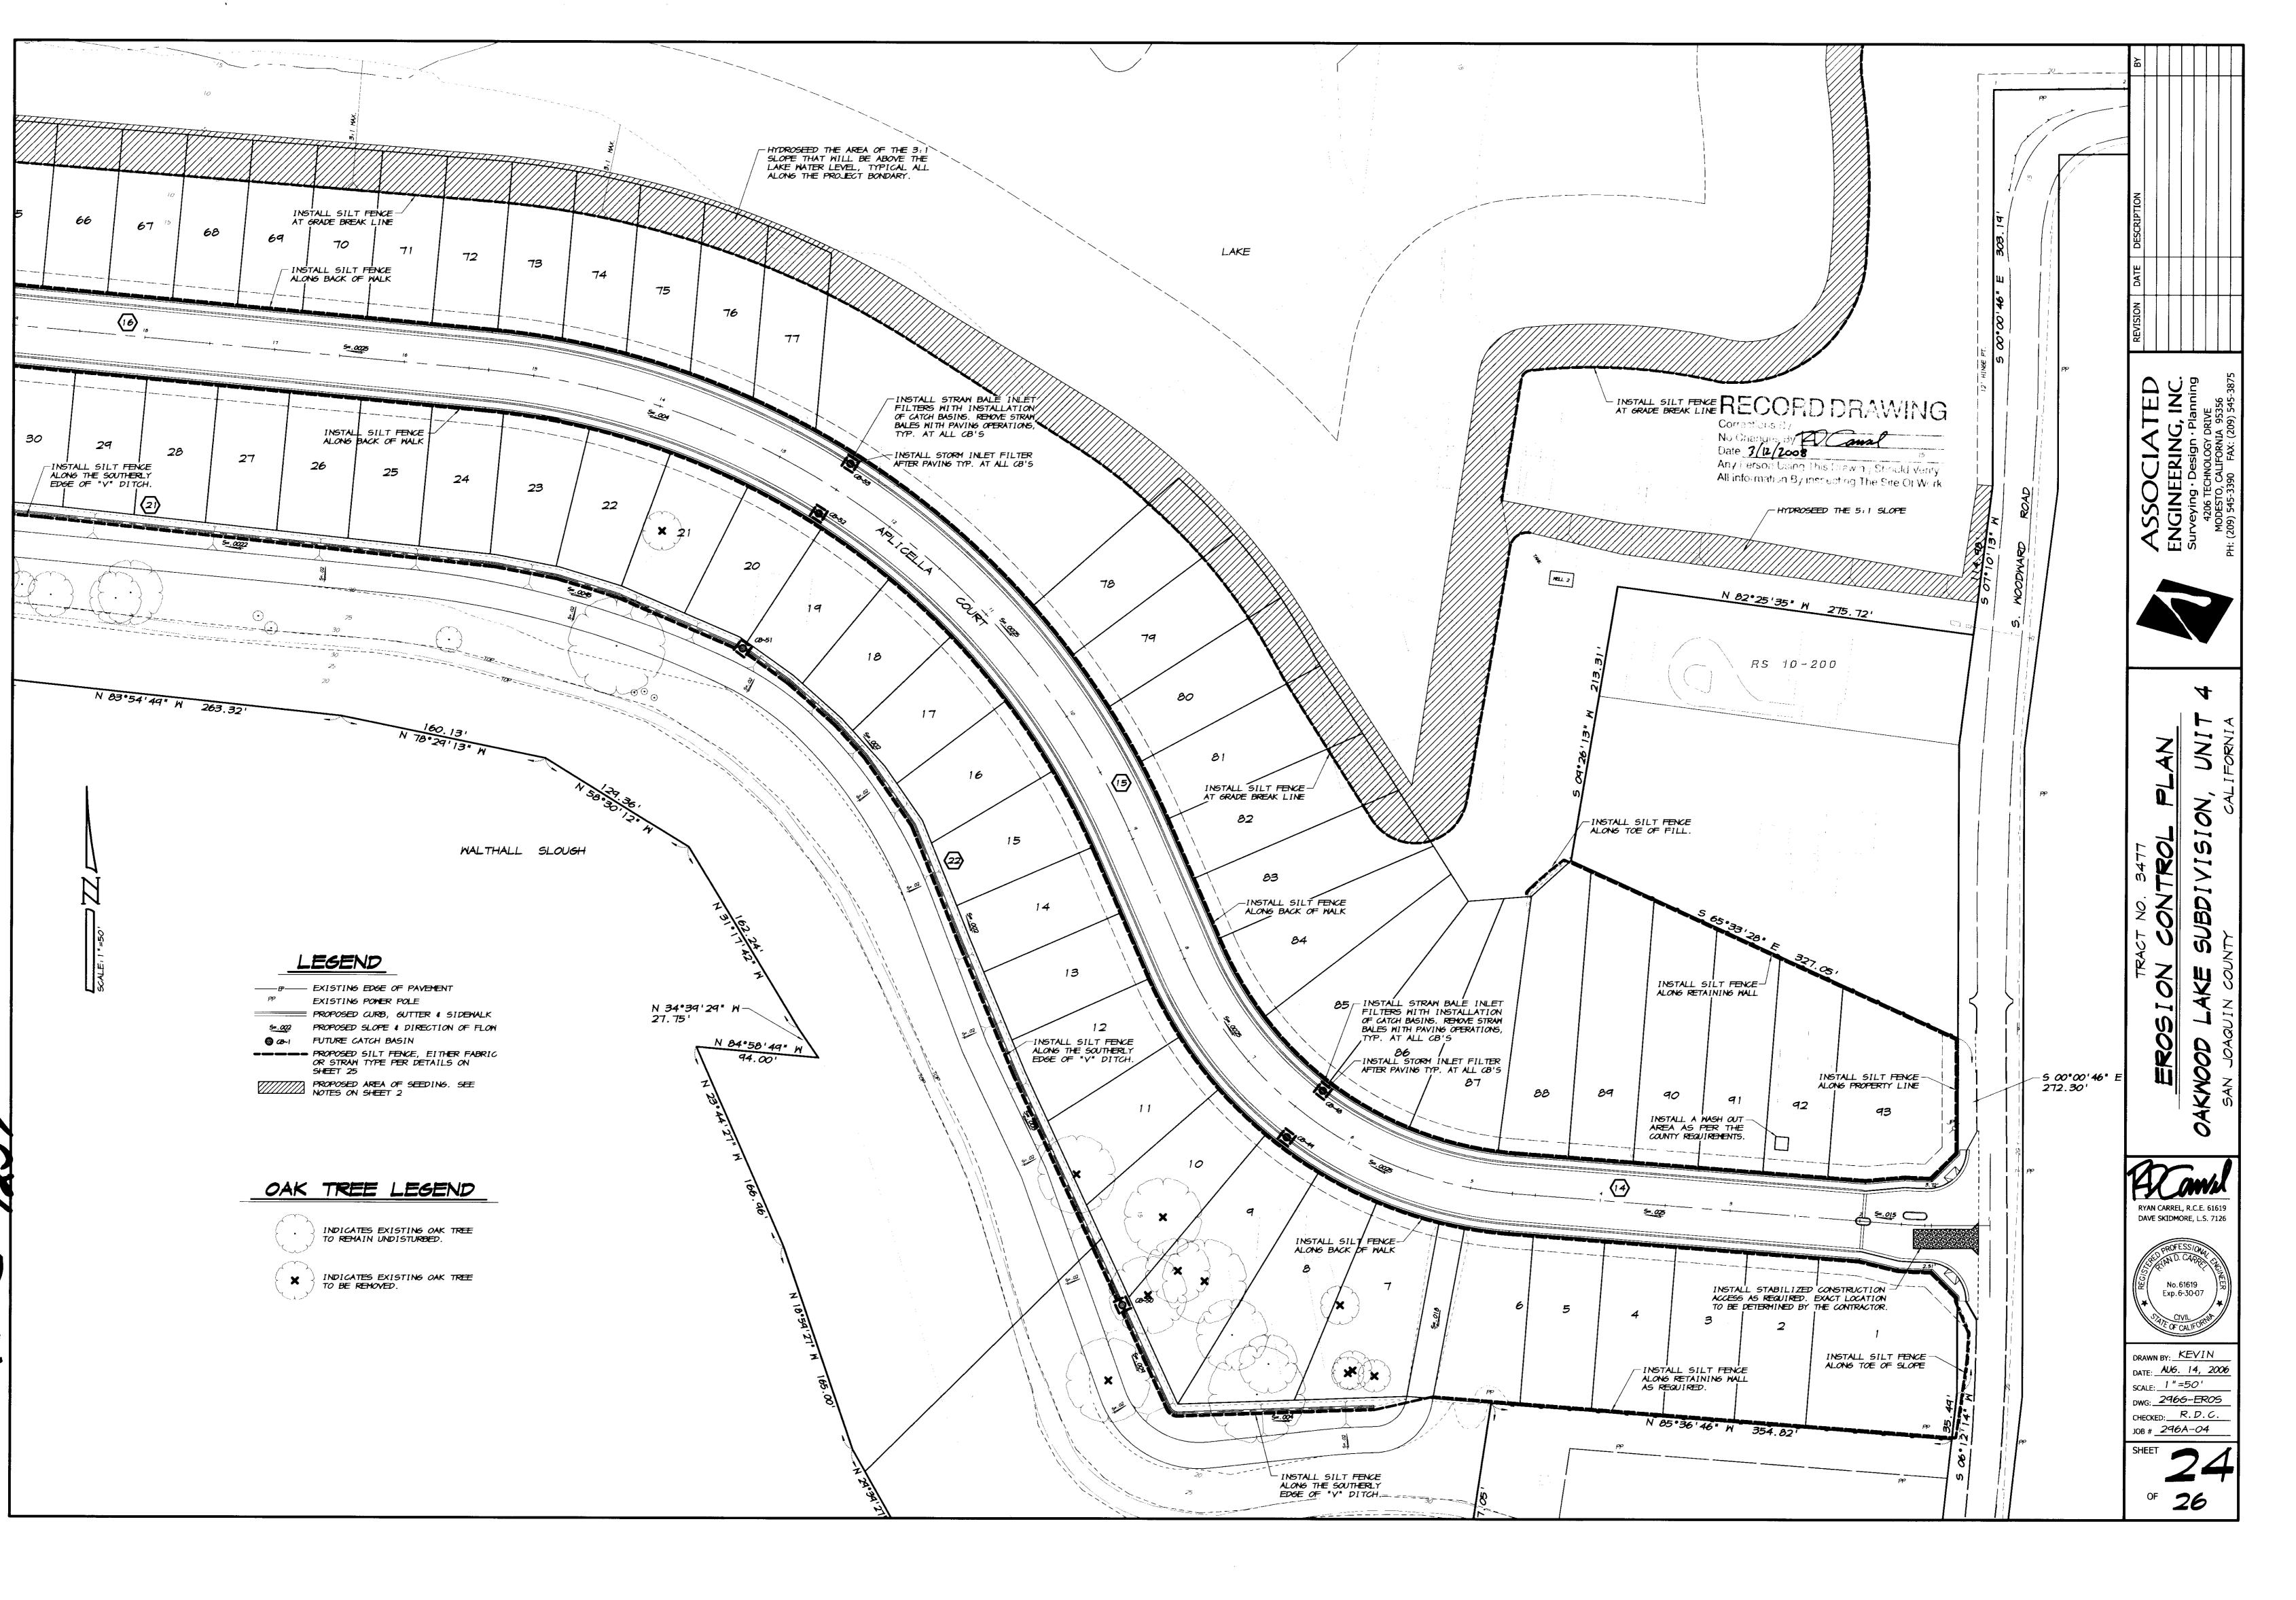


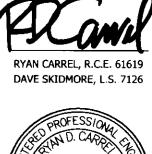


DRAWN BY: KEVIN DATE: AUG. 14, 2006 SCALE: 1 "=50' DWG: 2966-EROS CHECKED: R.D.C. JOB # <u>296A-04</u>

SHEET



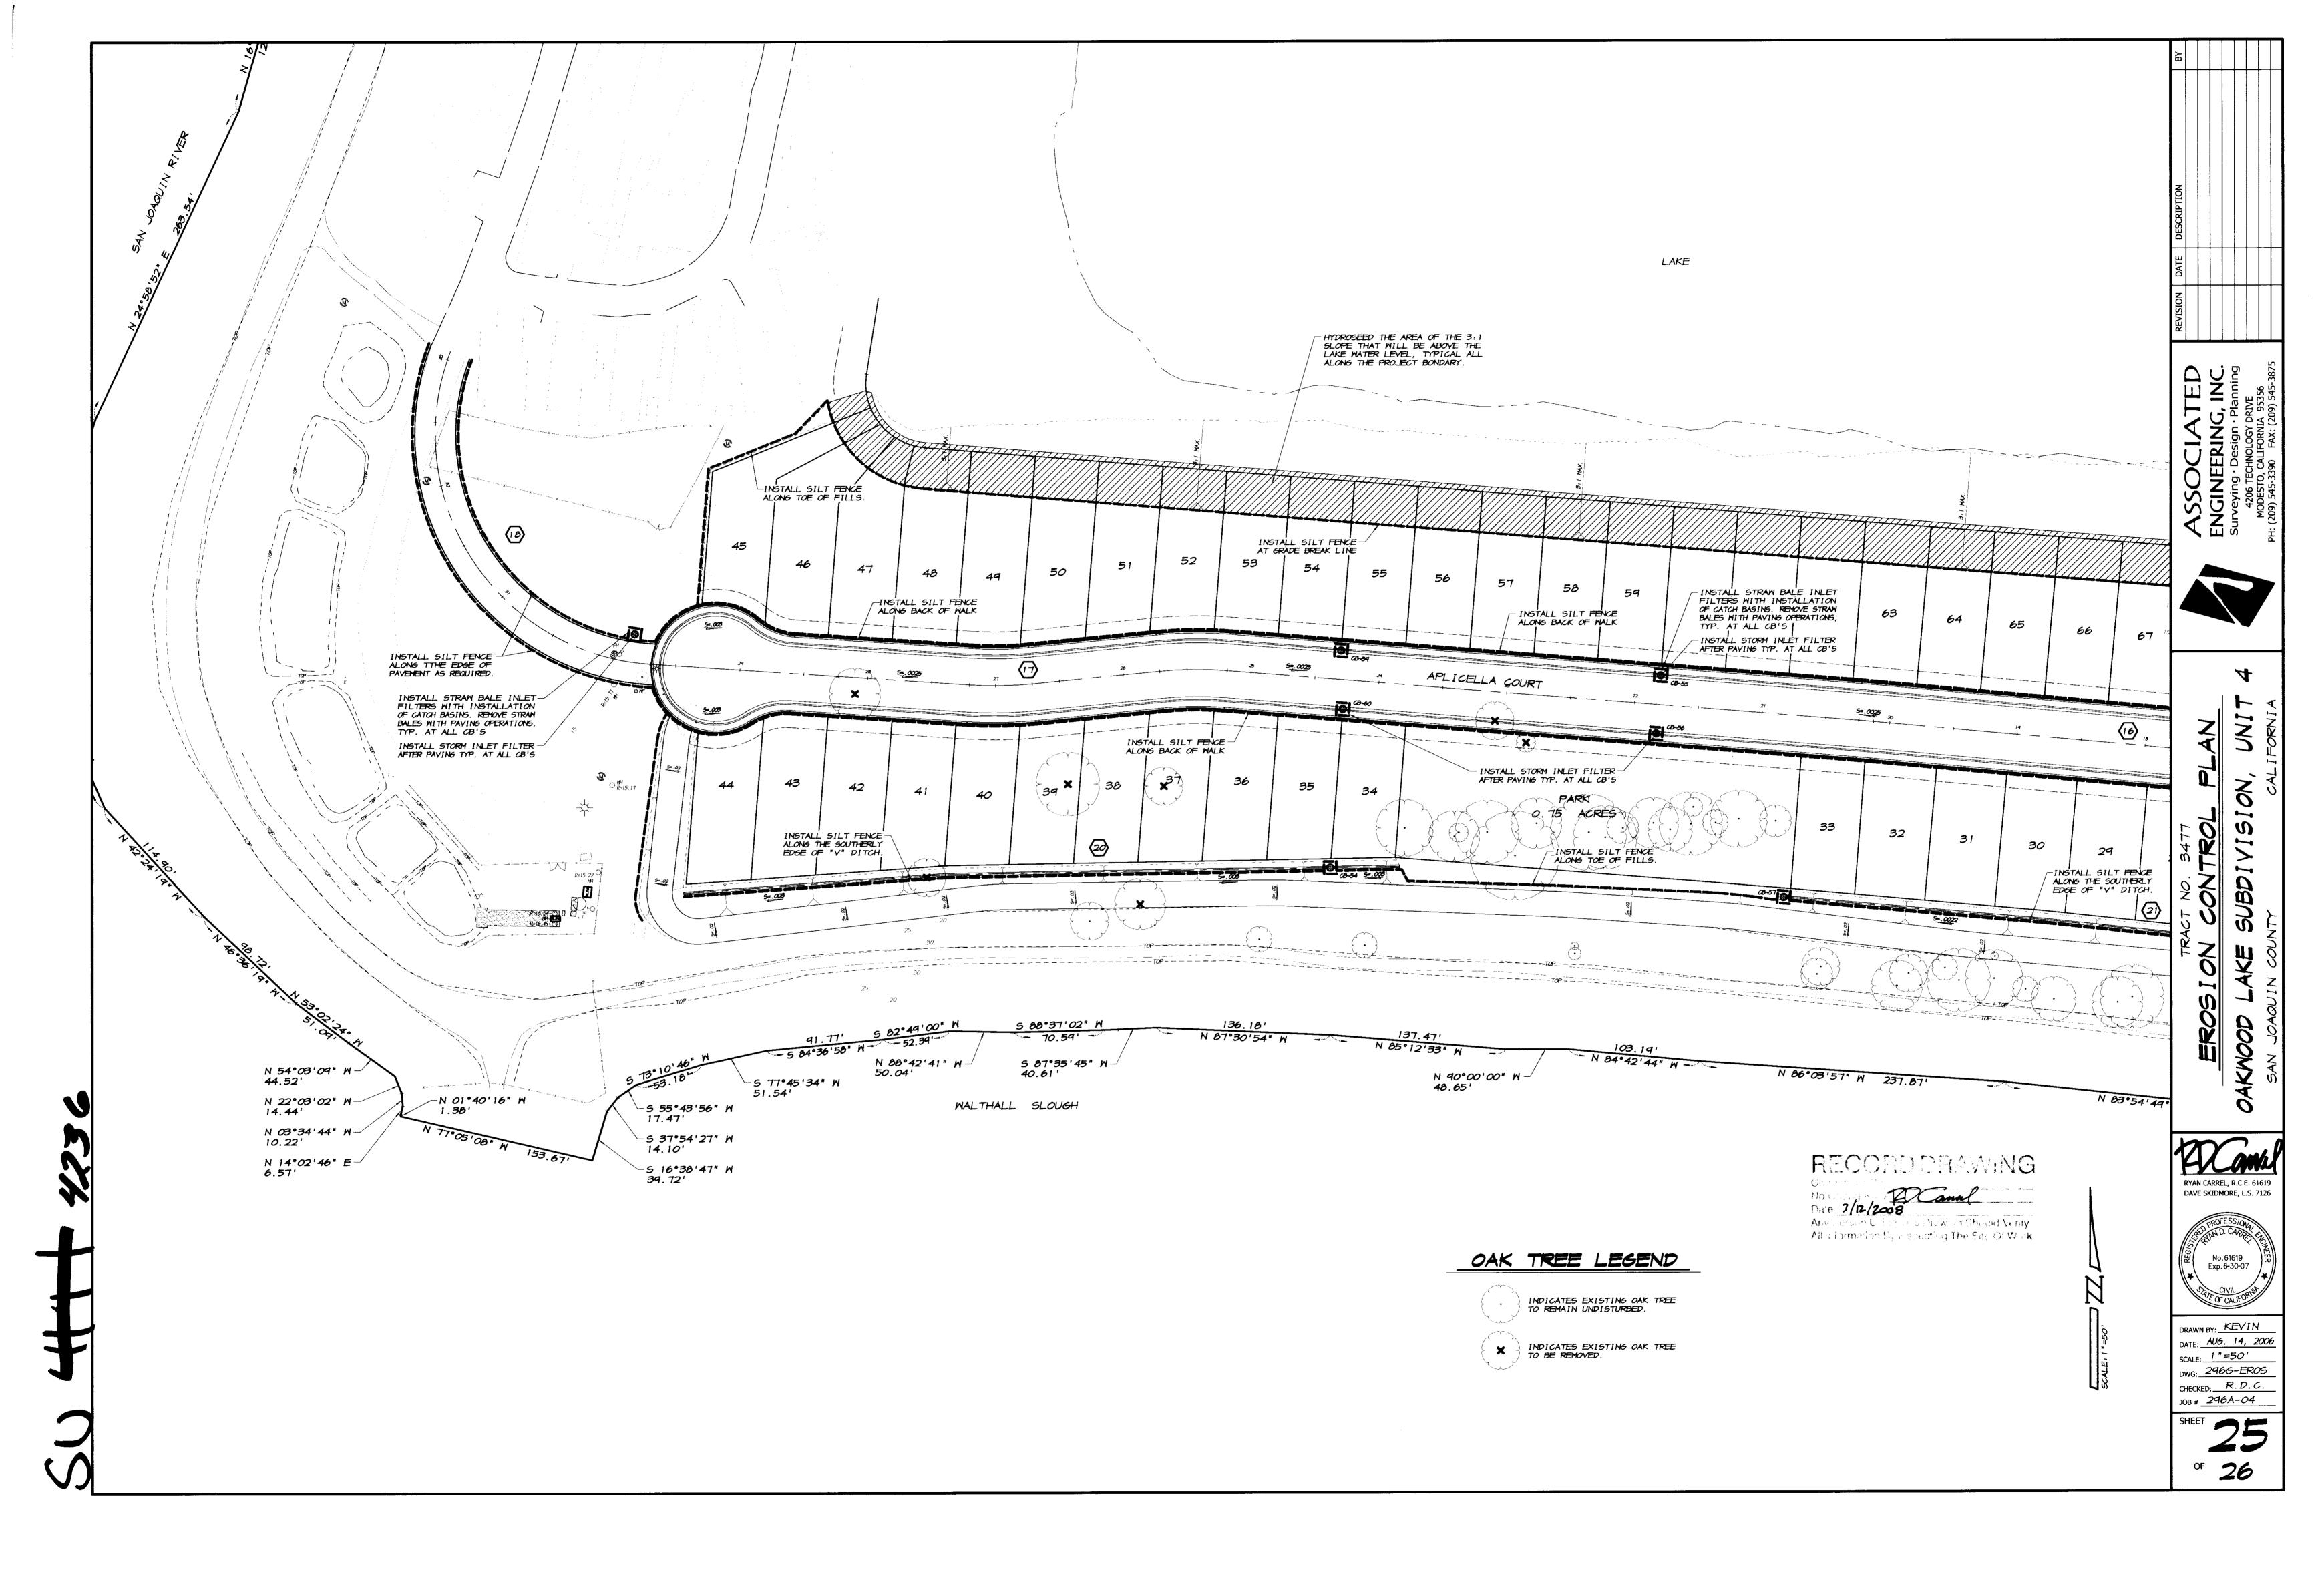

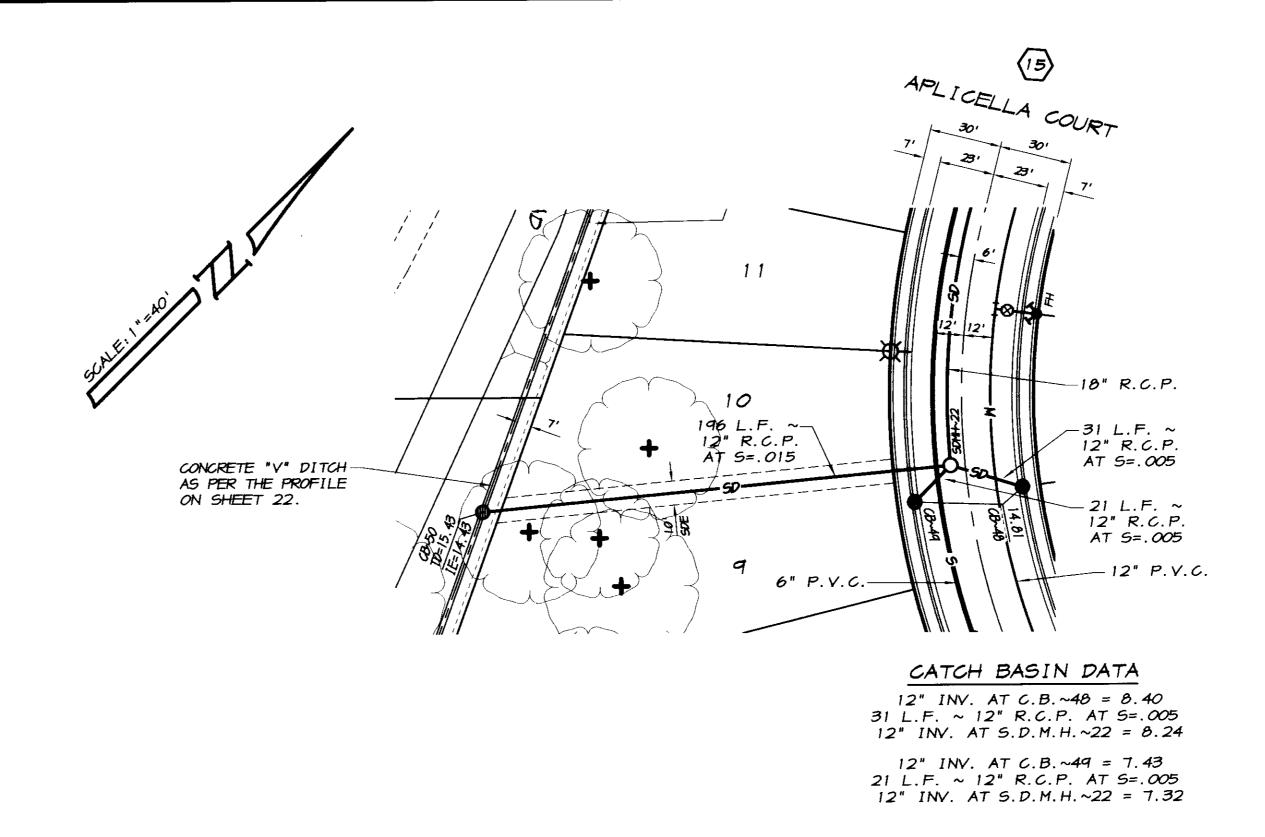

STORM DRAIN CONNECTION SCALE: 1"=40'

2. EXISTING GROUND 20 20 - PROPOSED GRADE -18 18 16 16 C.B. # 50 I.E.=14.43 14 5.D.M.H. **# 22** RIM=14.8 12 10

RECORD DRAWING

Concerted Stov

No Changes By Cauch

Date 3/12/208

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RYAN CARREL, R.C.E. 61619 DAVE SKIDMORE, L.S. 7126




DRAWN BY: J. S. H.

DATE: AUG. 14, 2006

SCALE: NOTED

DWG: 2966-VDPP CHECKED: KW
JOB # 2966-04

SCALE : HORIZONTAL : 1"=40' VERTICAL : 1"=4'

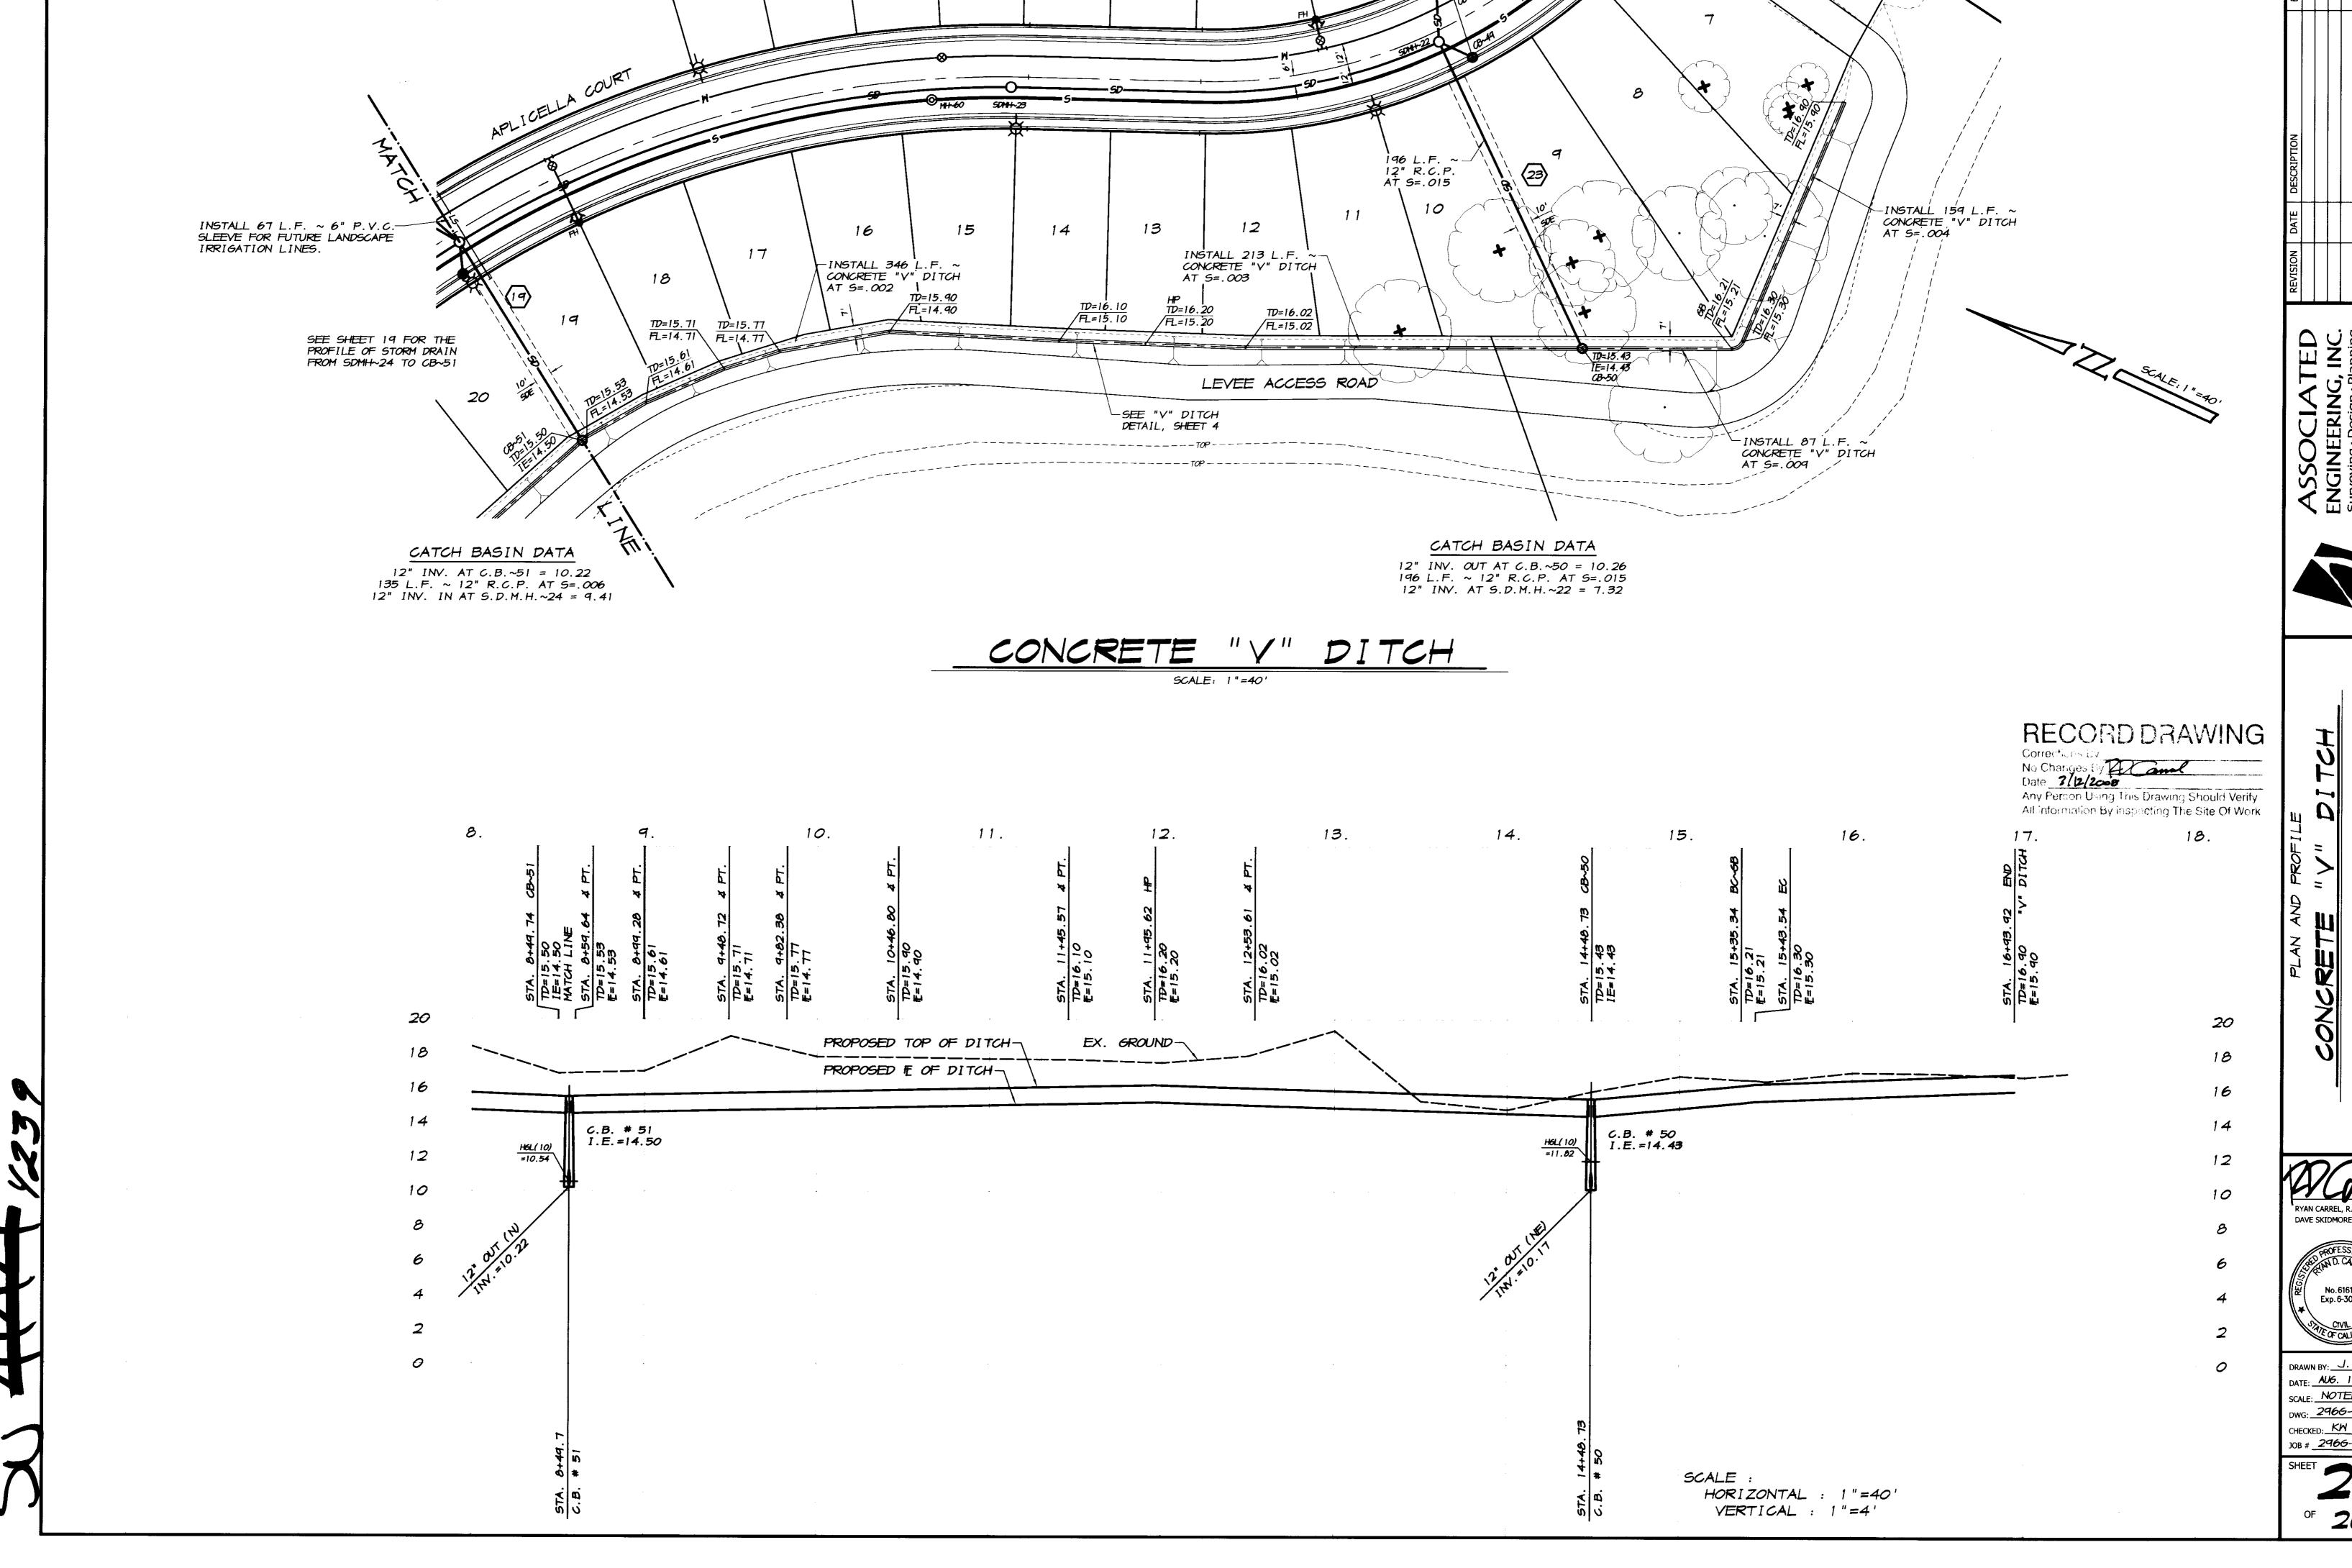






RYAN CARREL, R.C.E. 61619 DAVE SKIDMORE, L.S. 7126





DRAWN BY: J. S. H. DATE: AUG. 14, 2006 SCALE: NOTED DWG: 2966-VDPP CHECKED: KW JOB # 2966-04

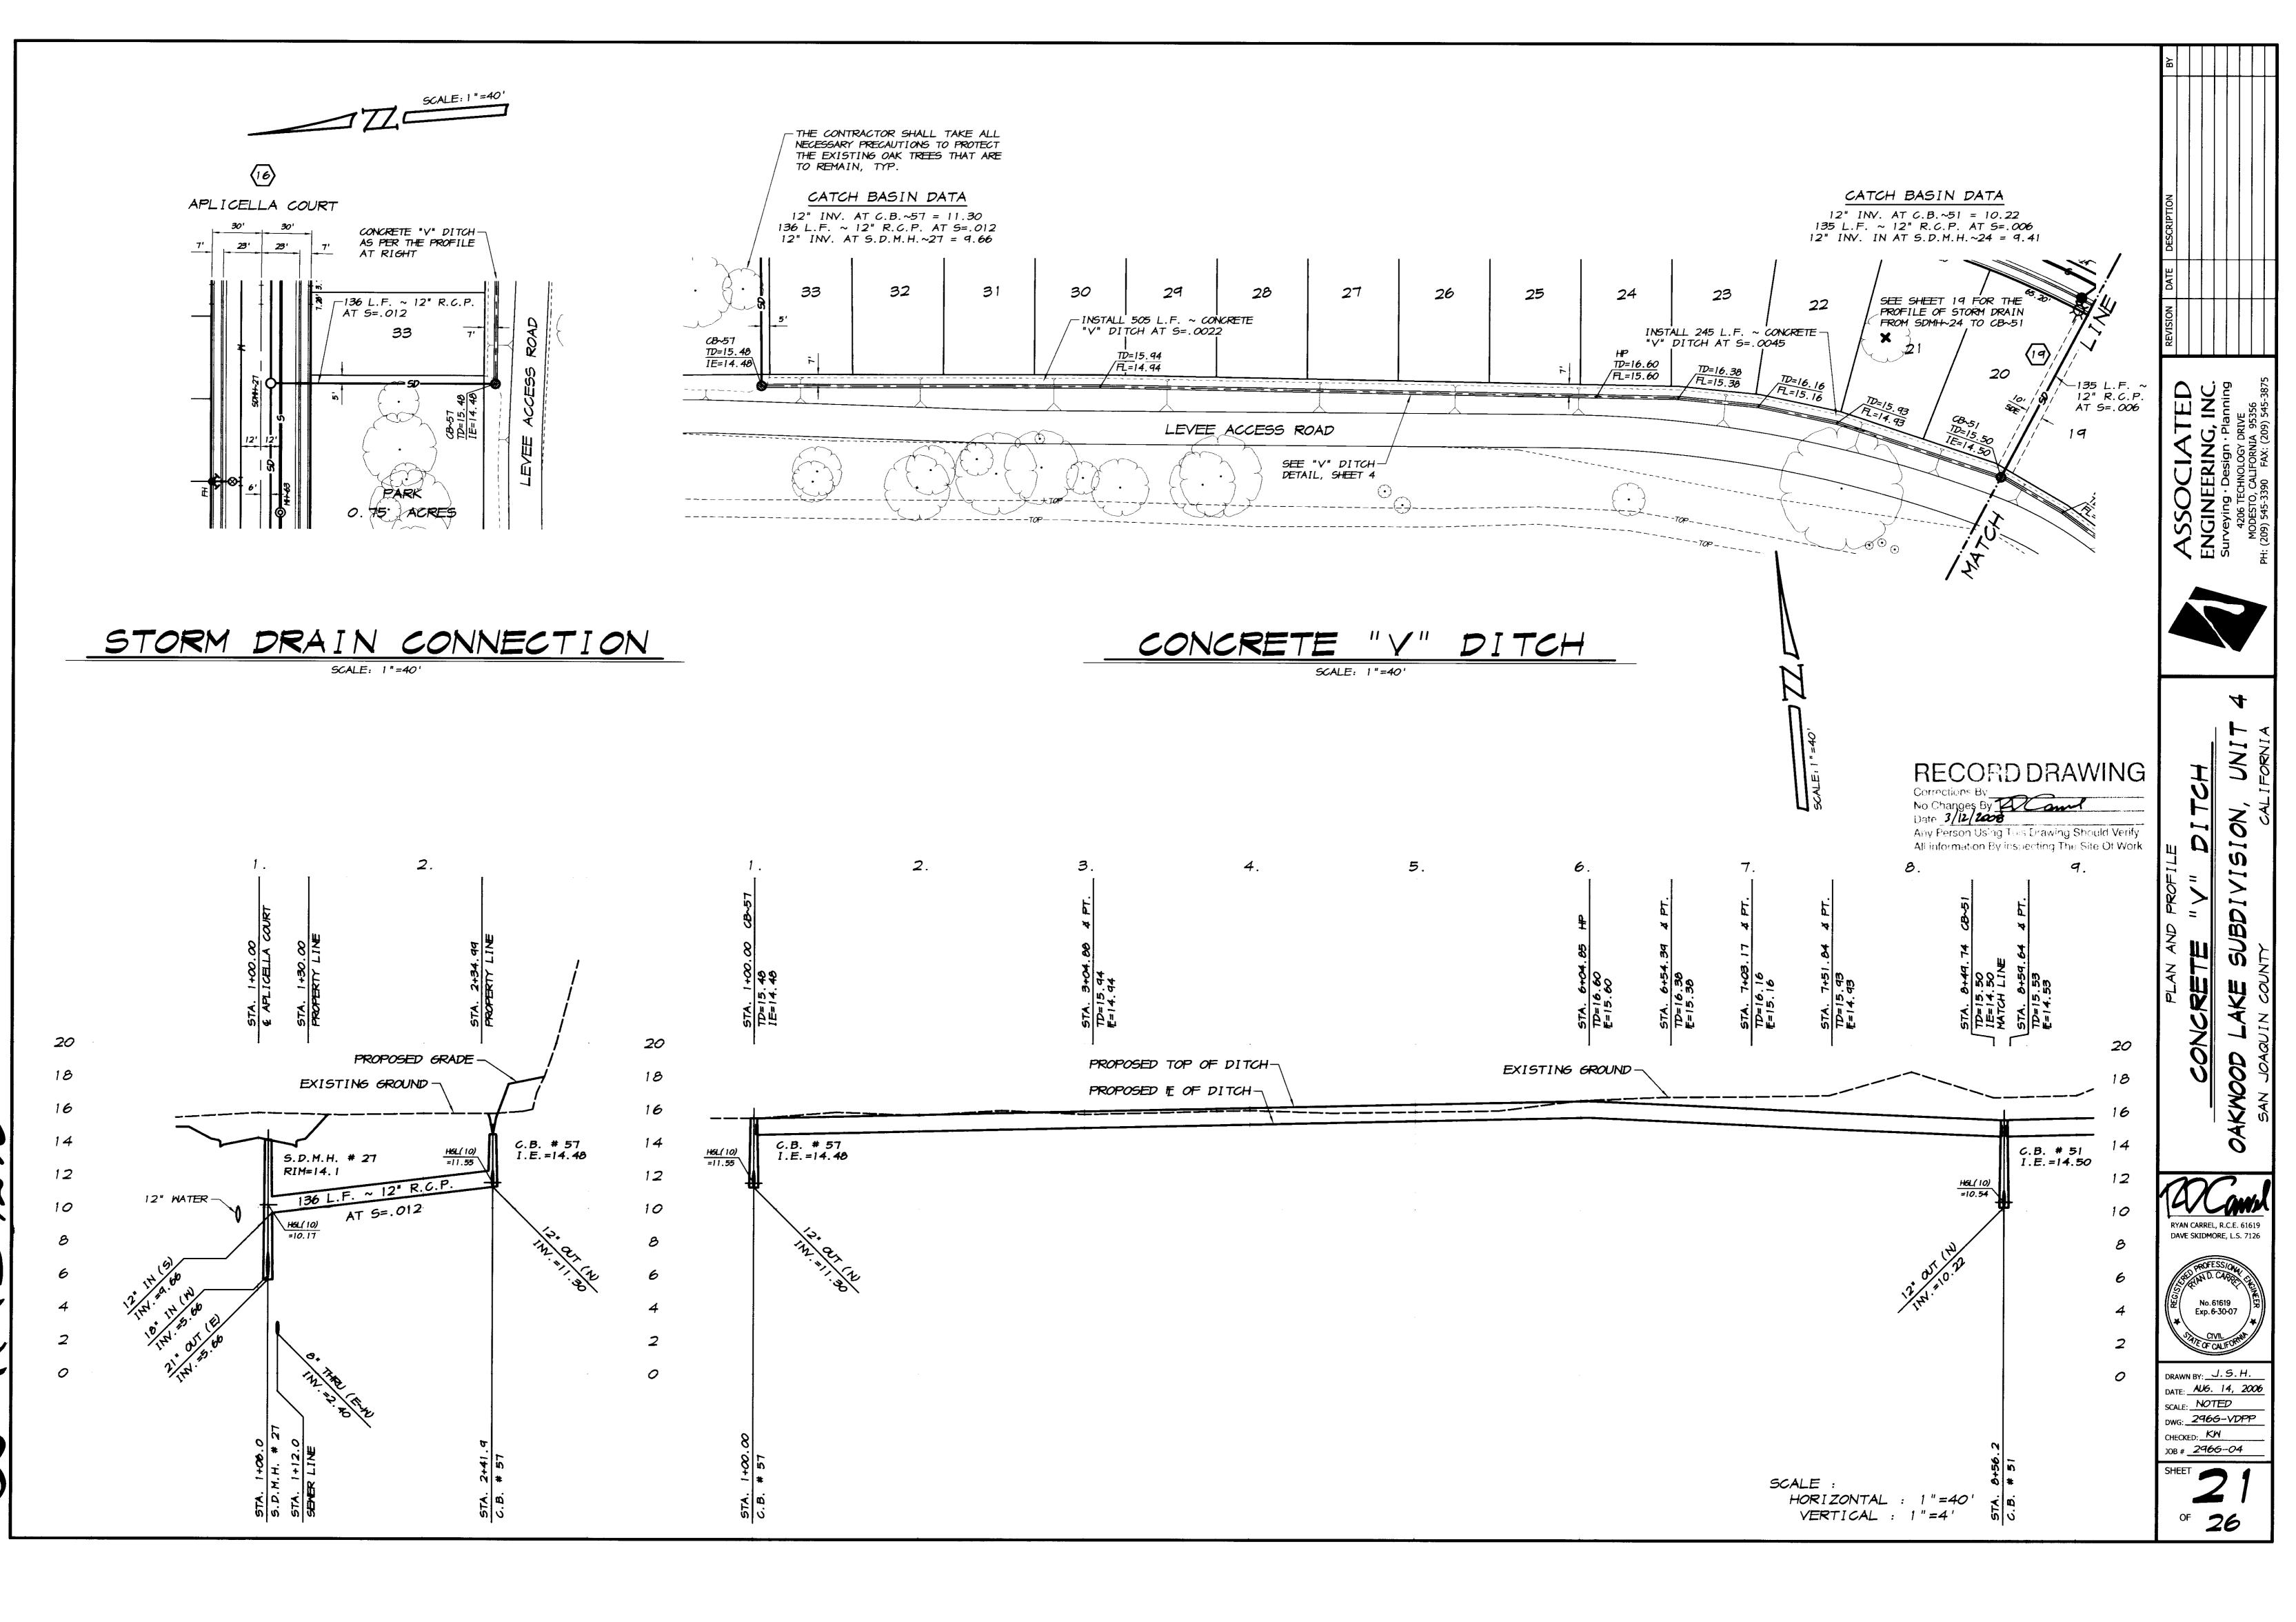


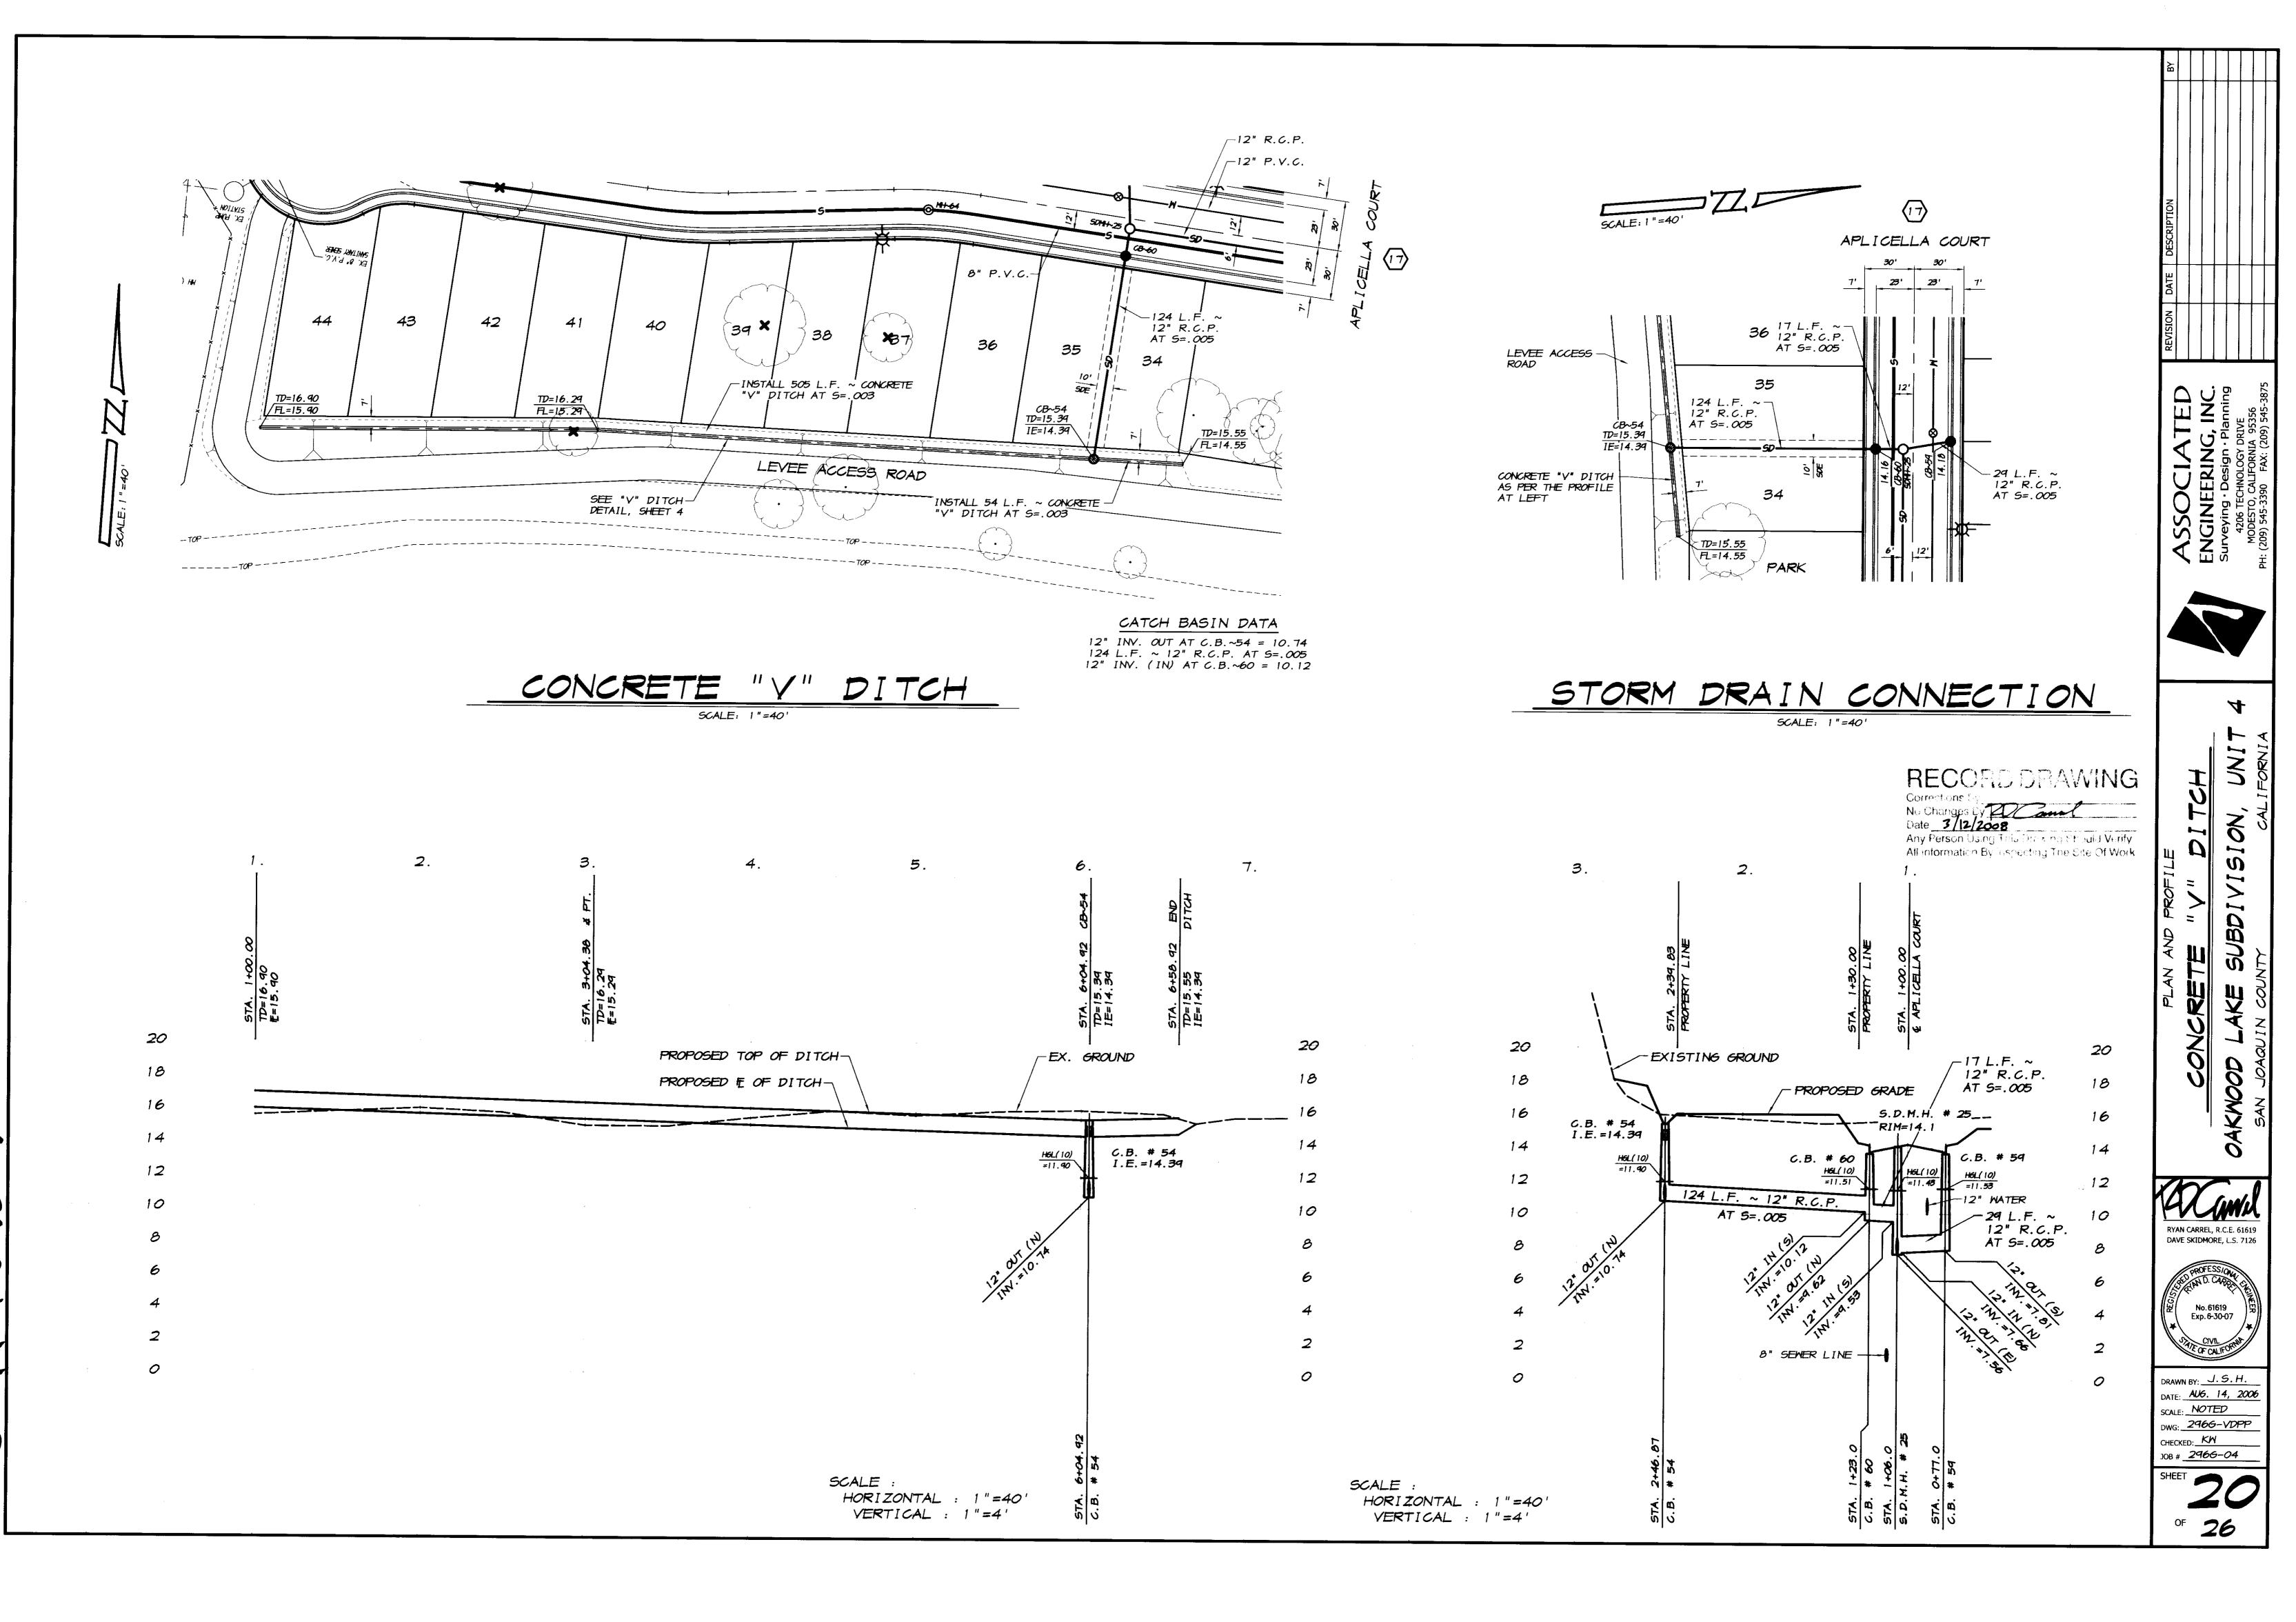

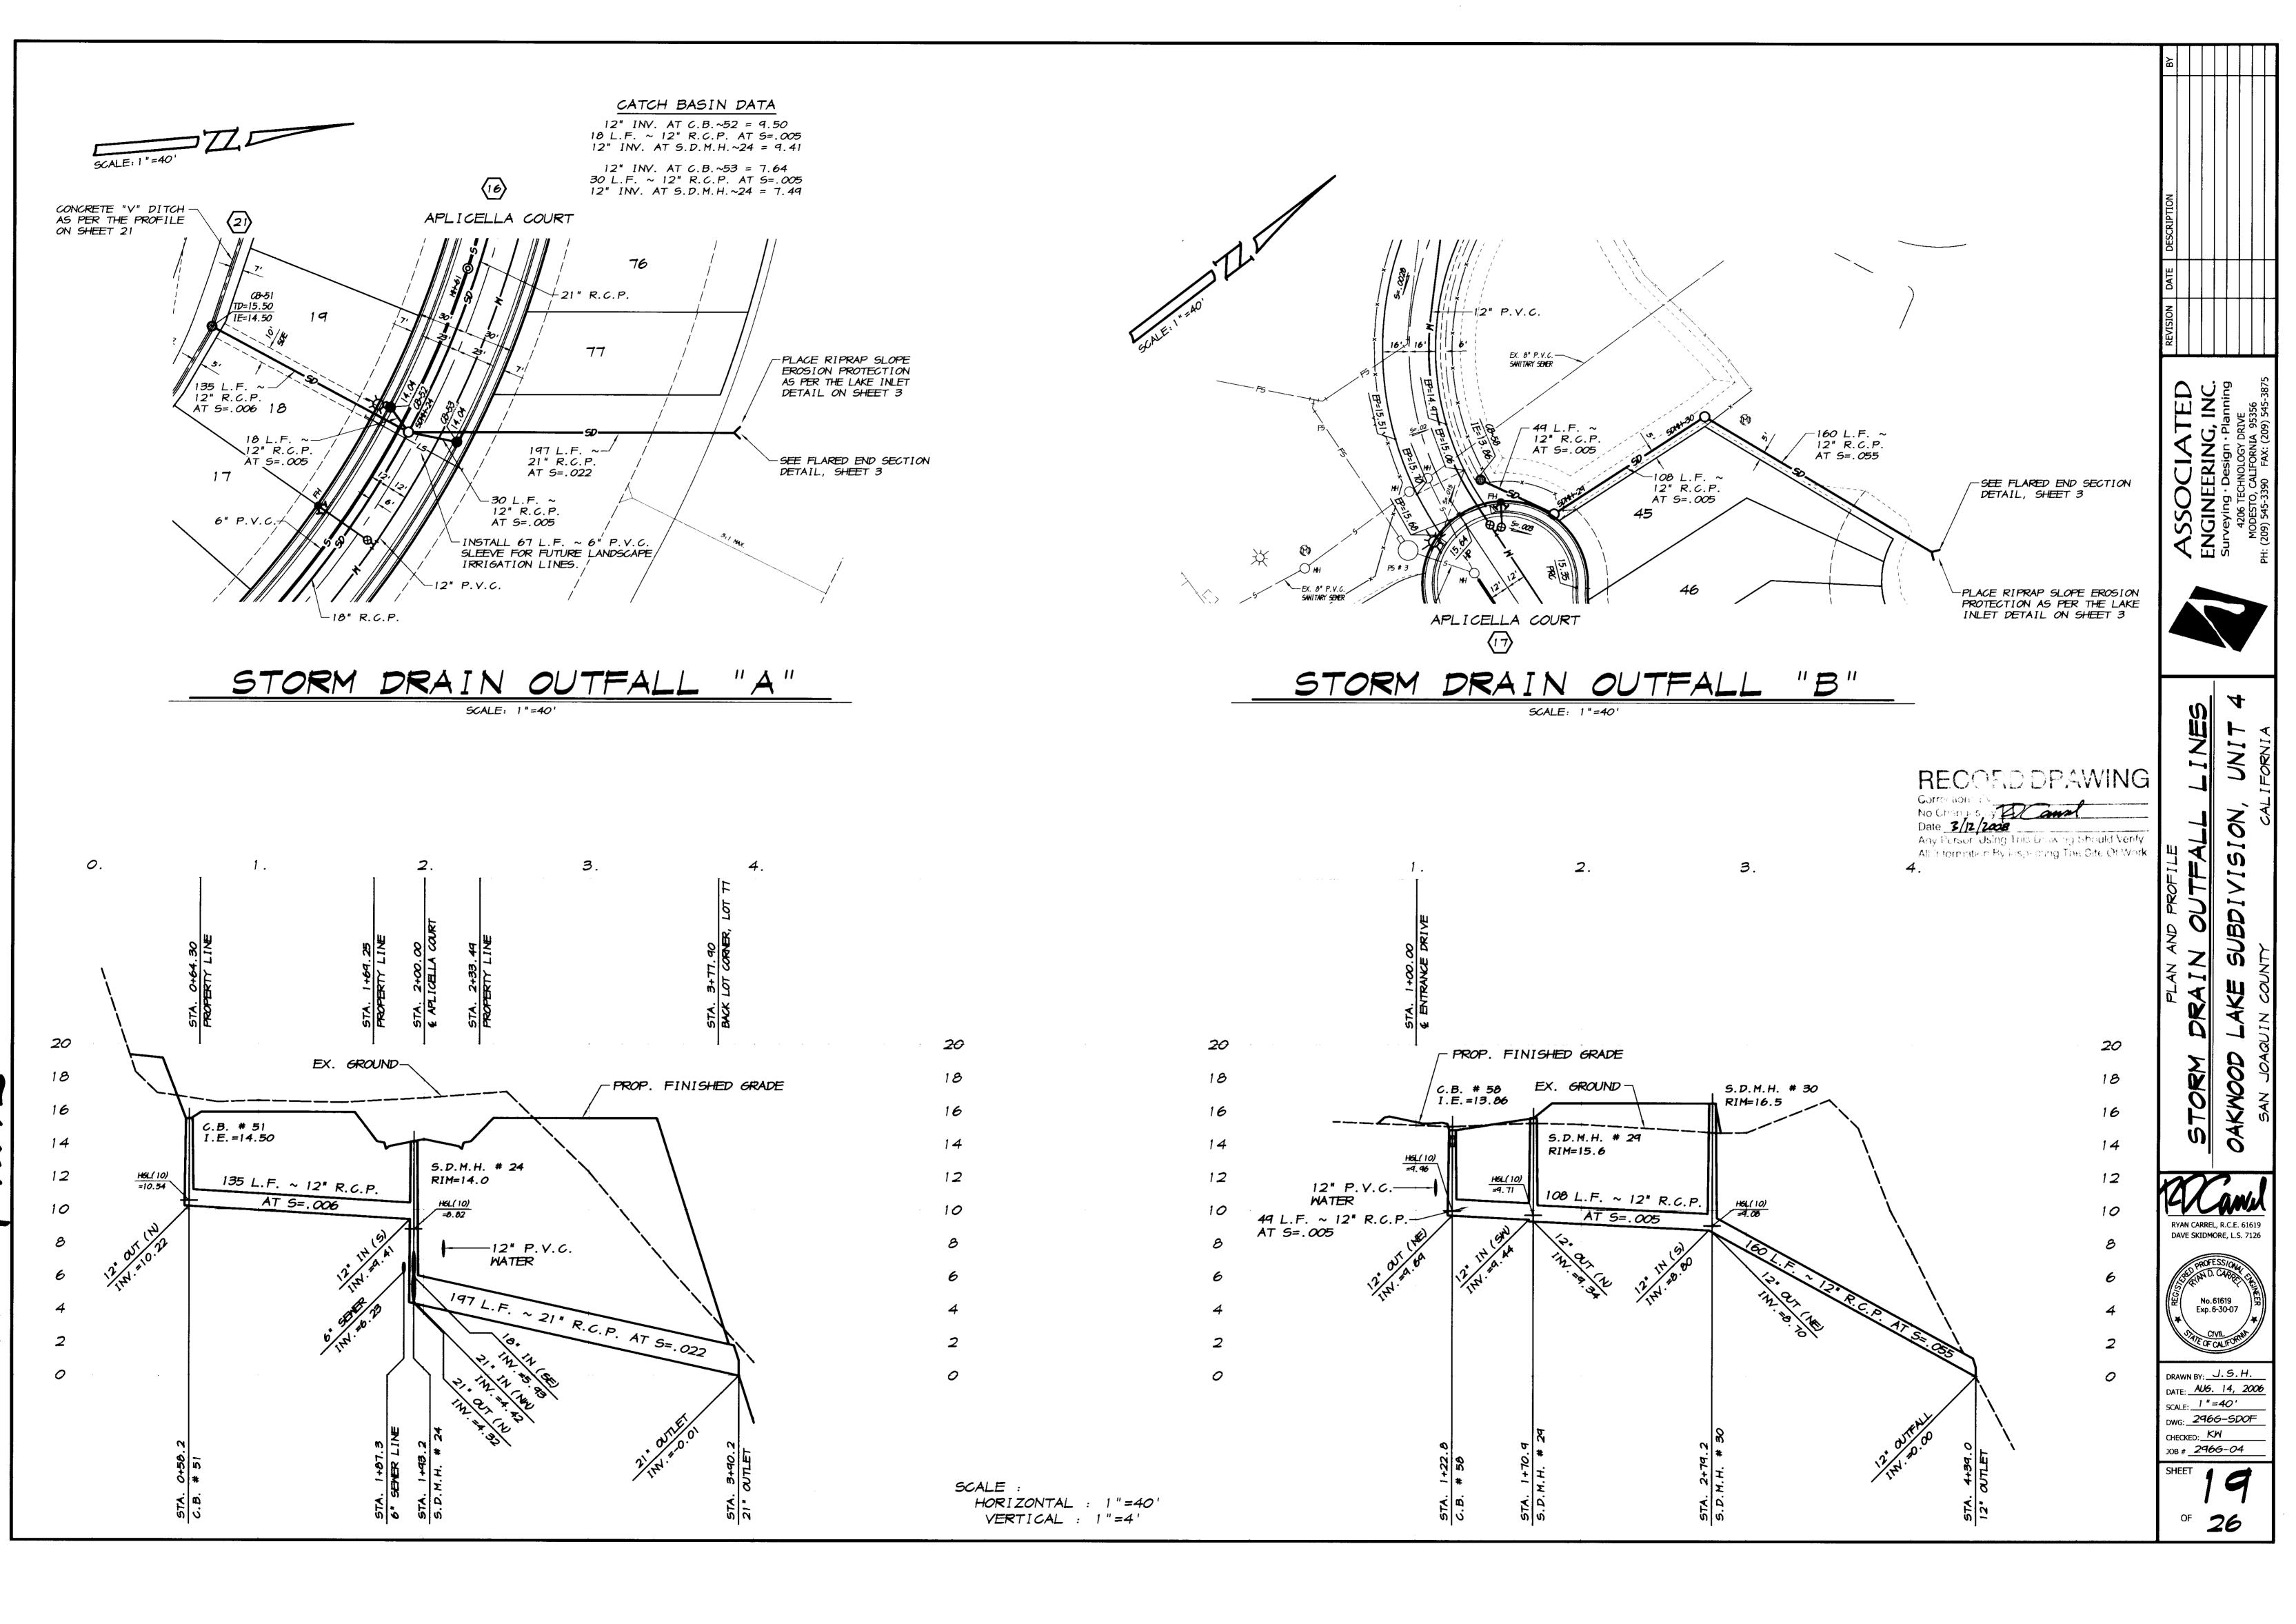

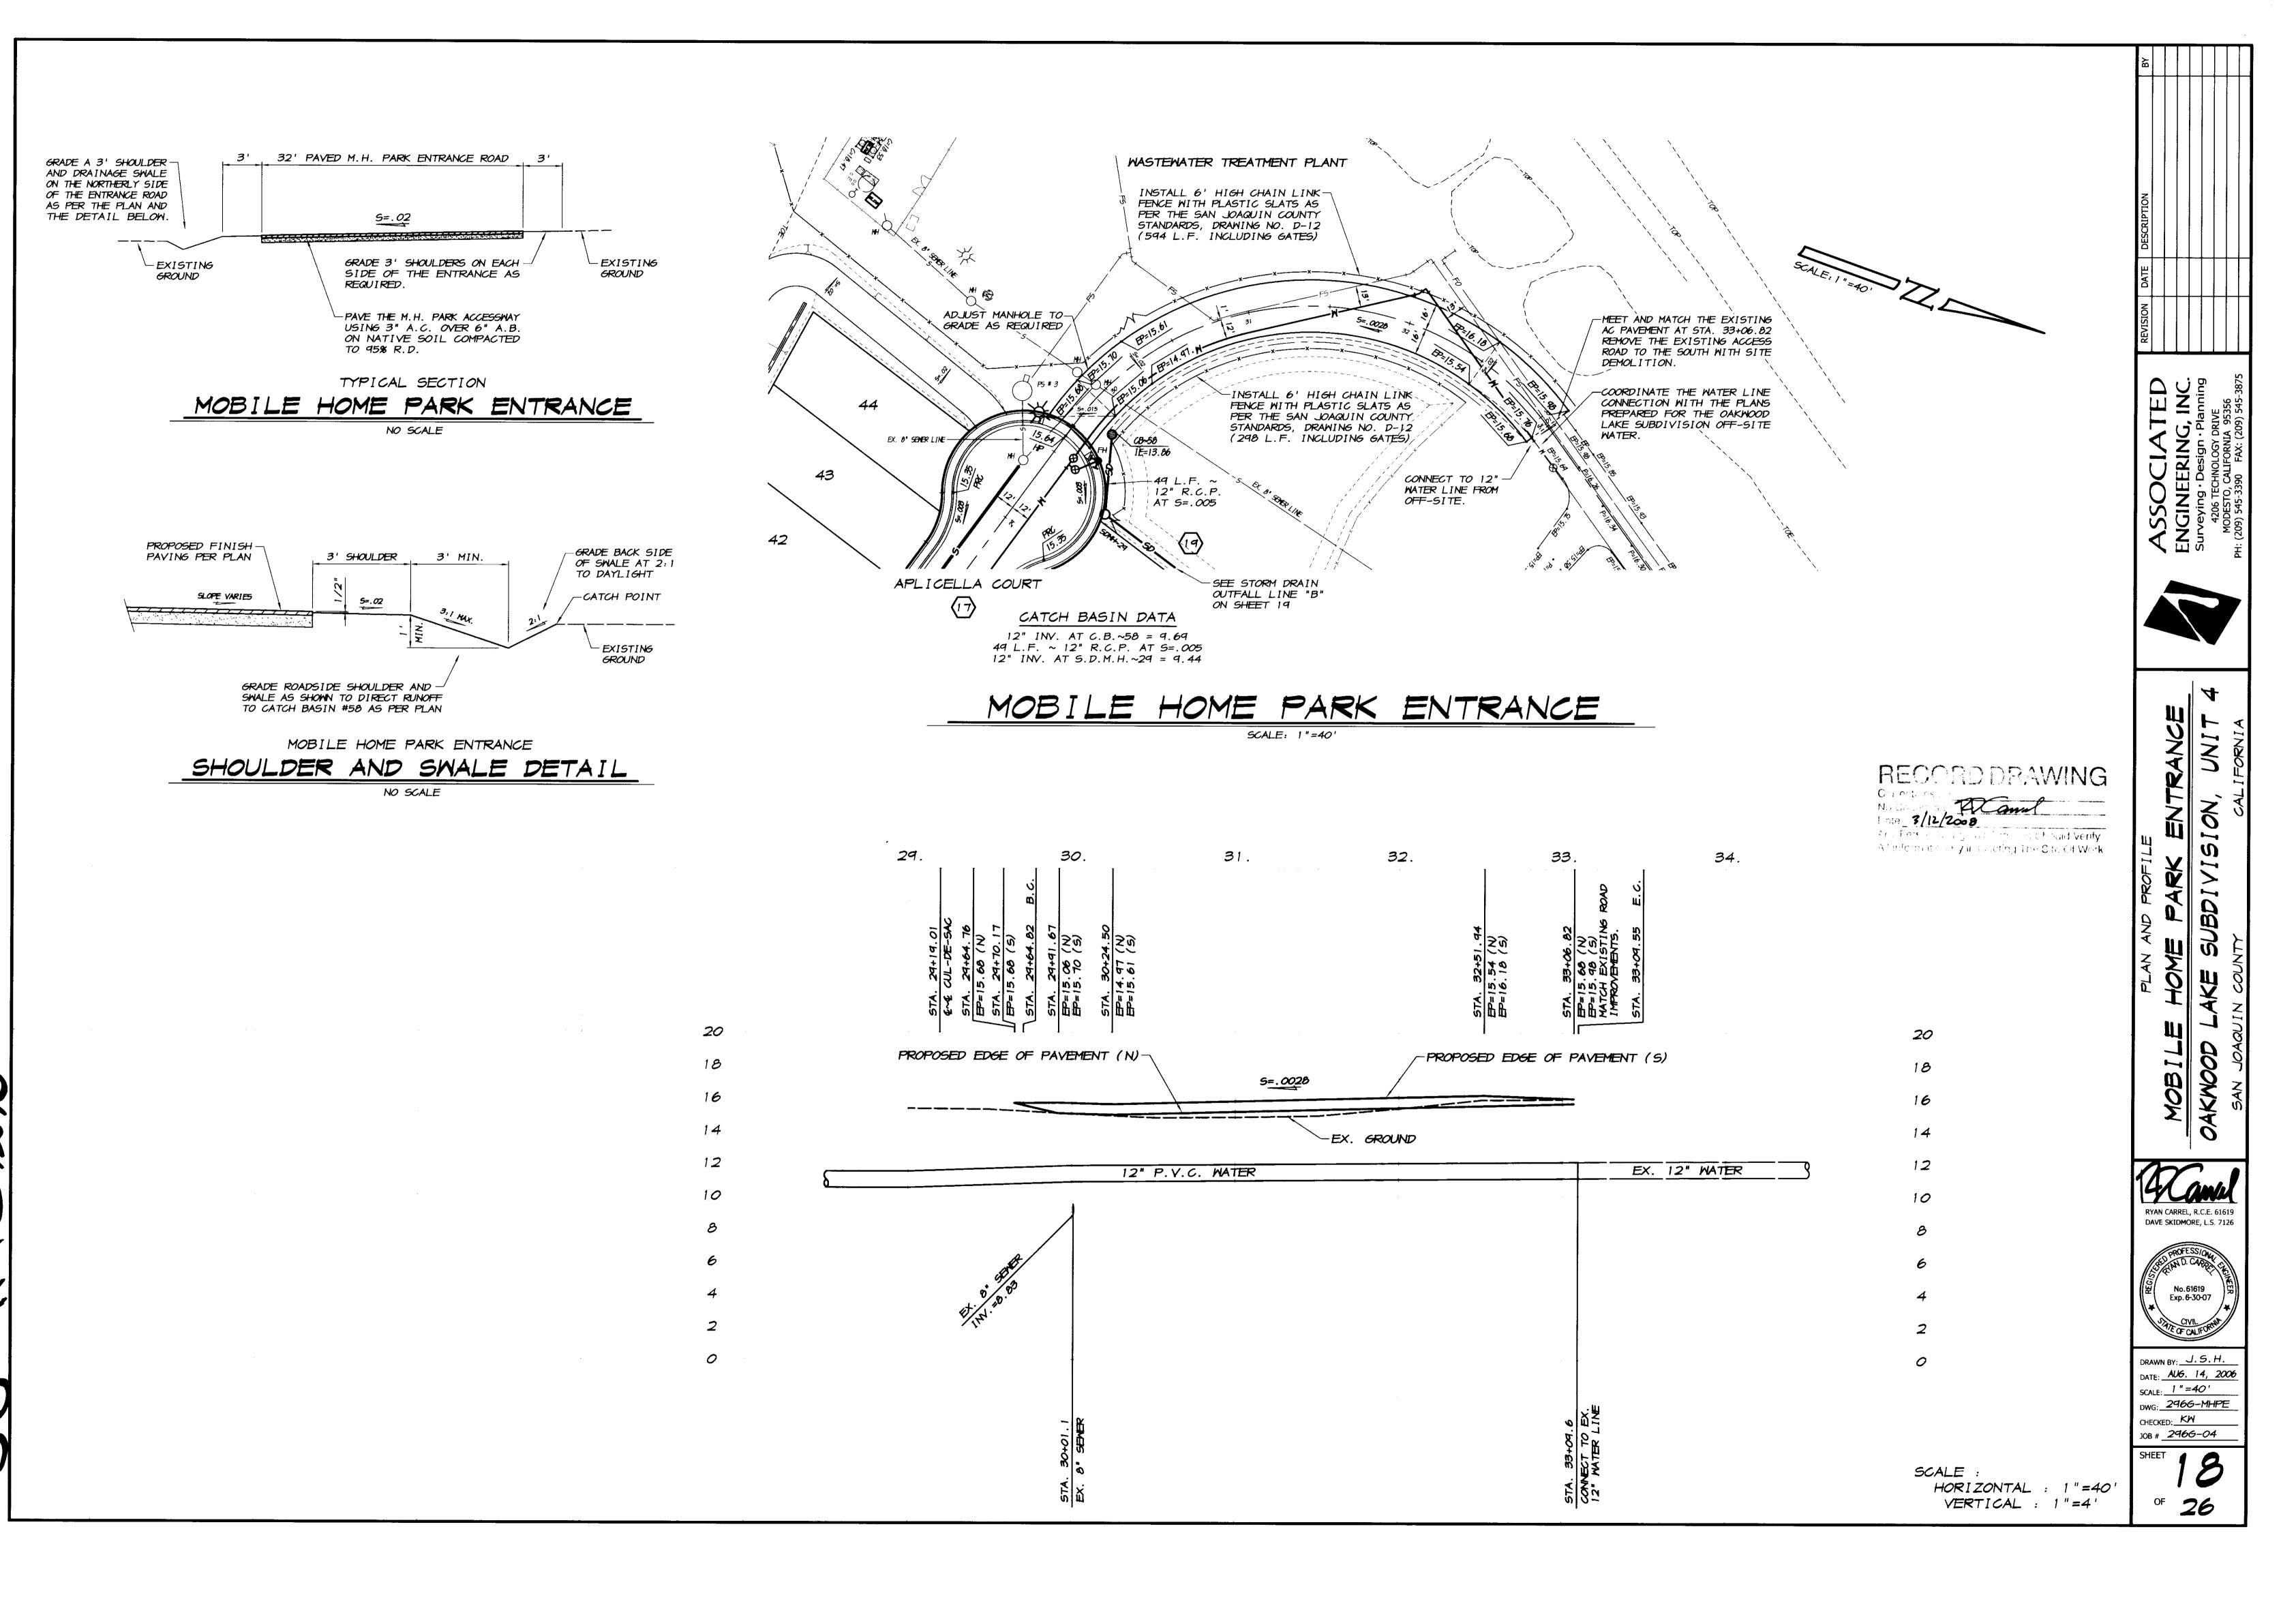

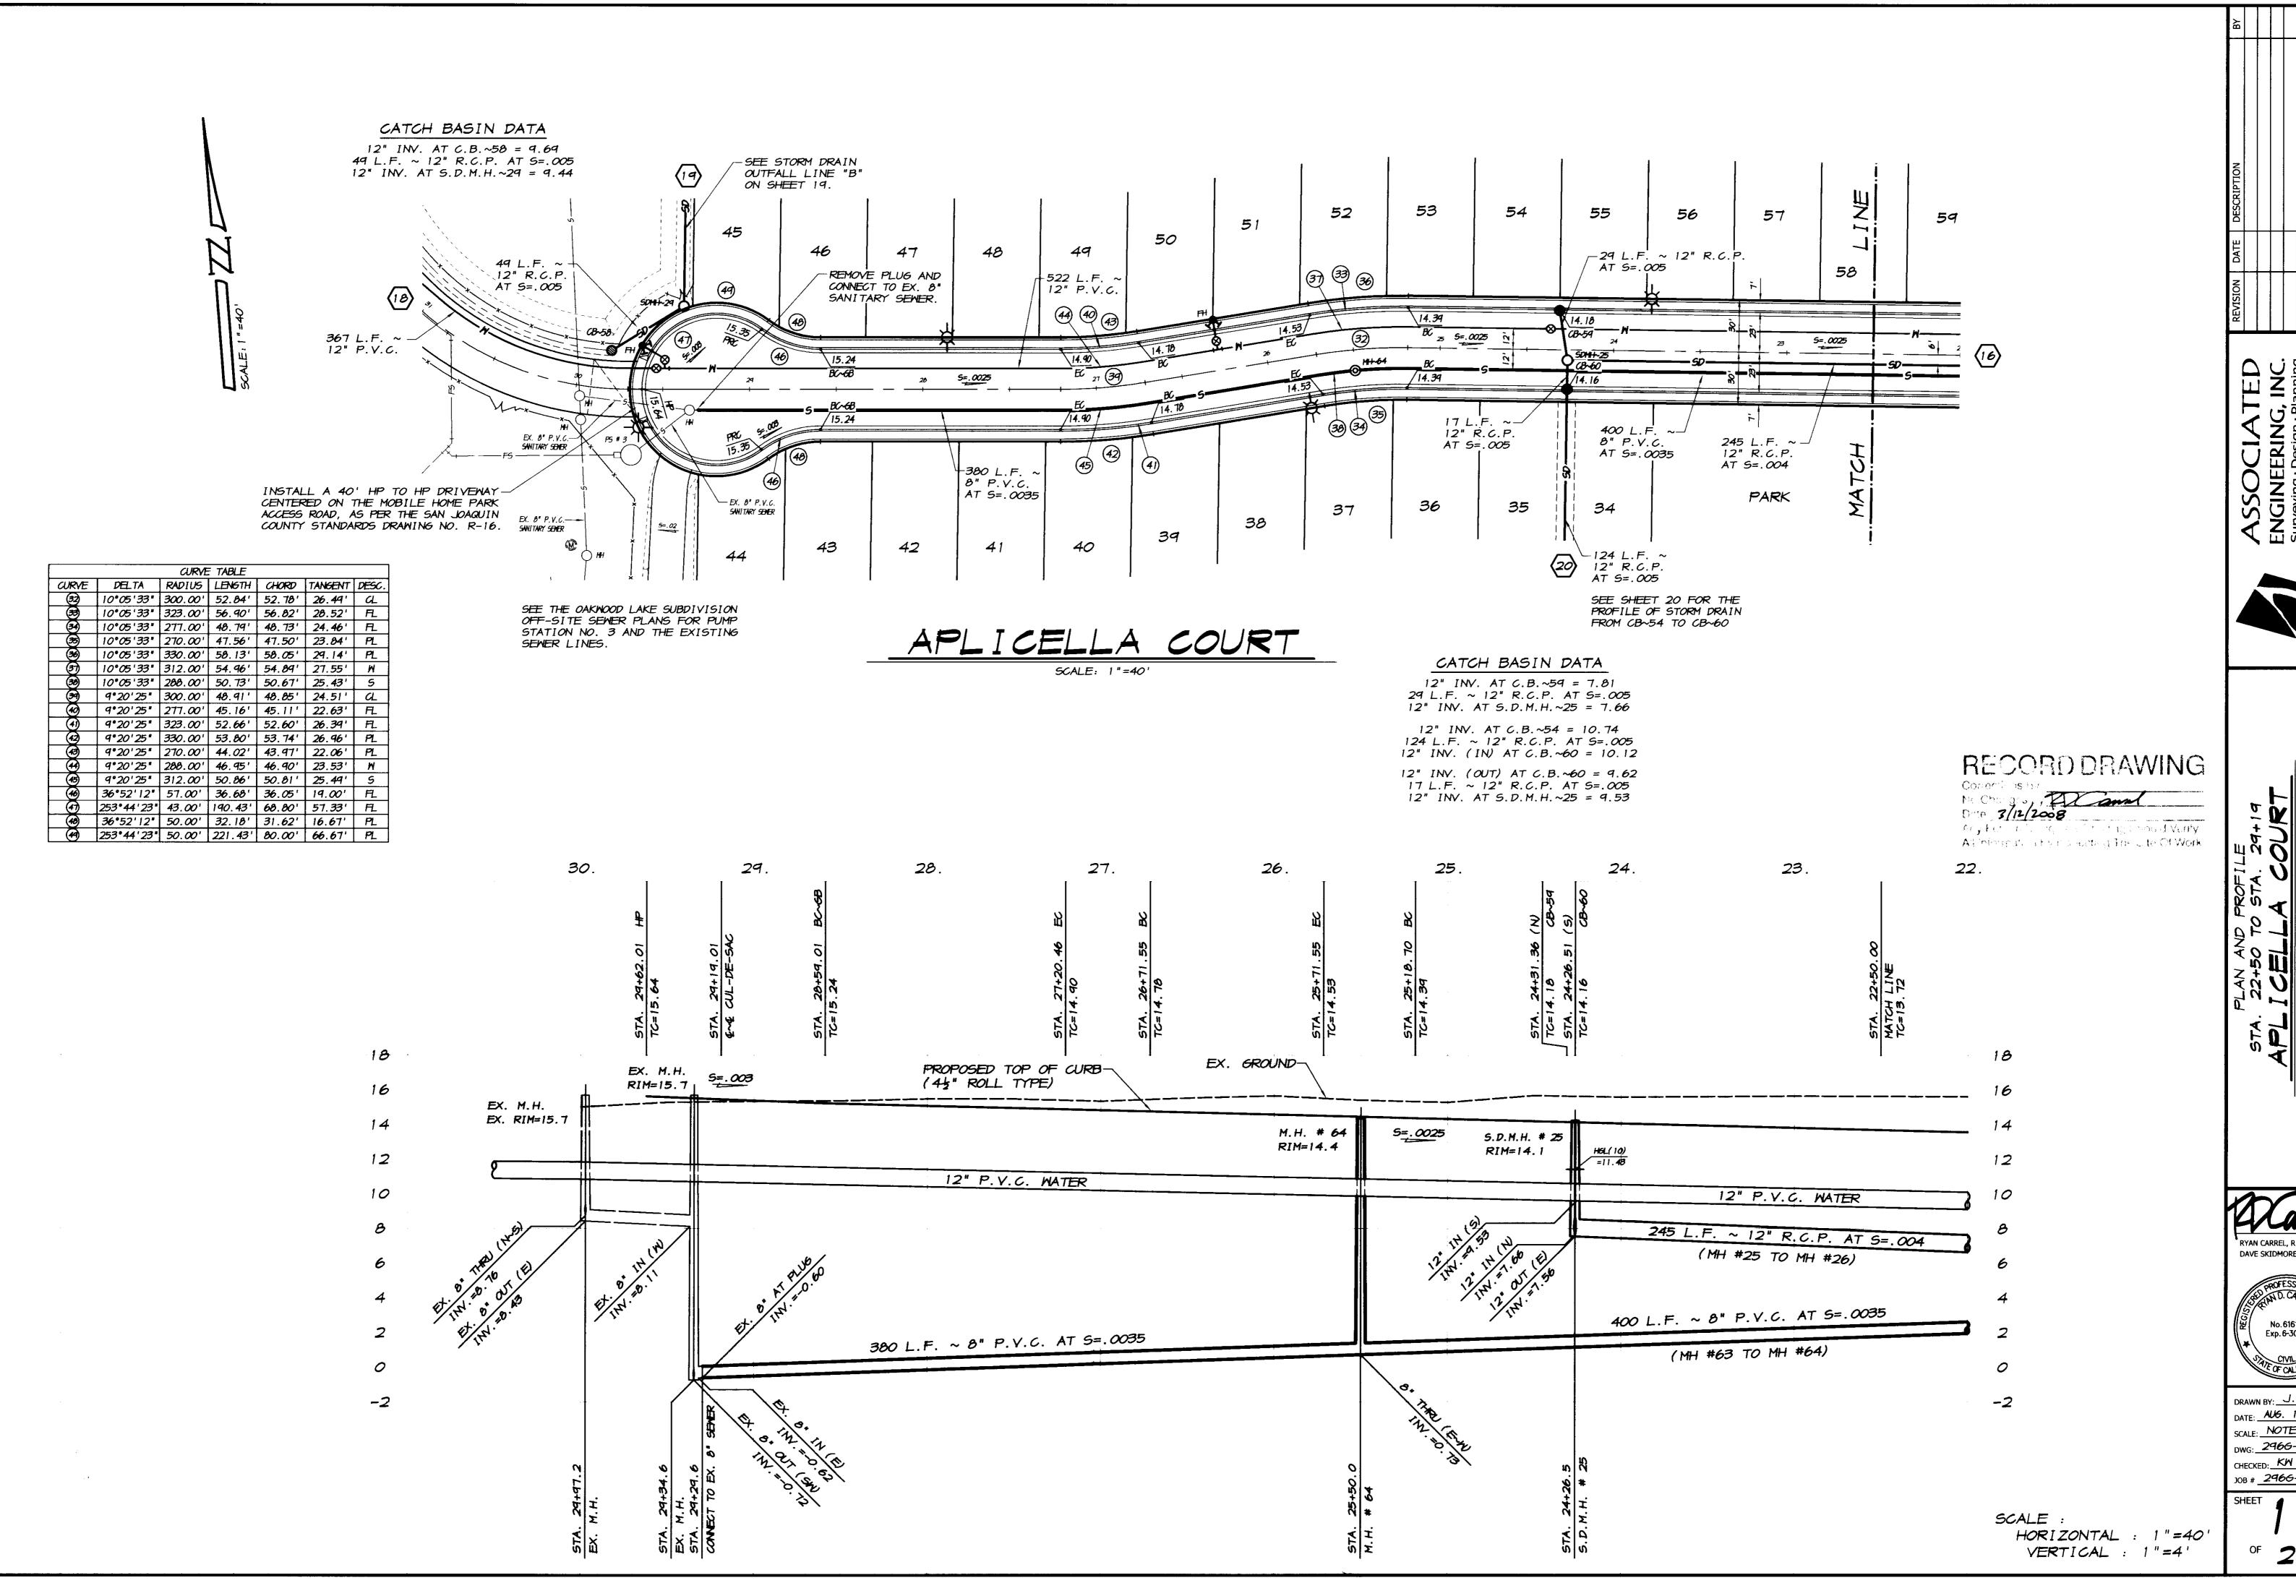

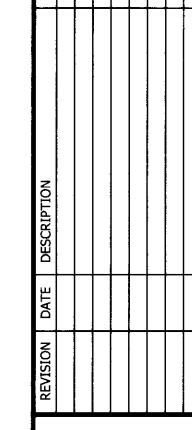

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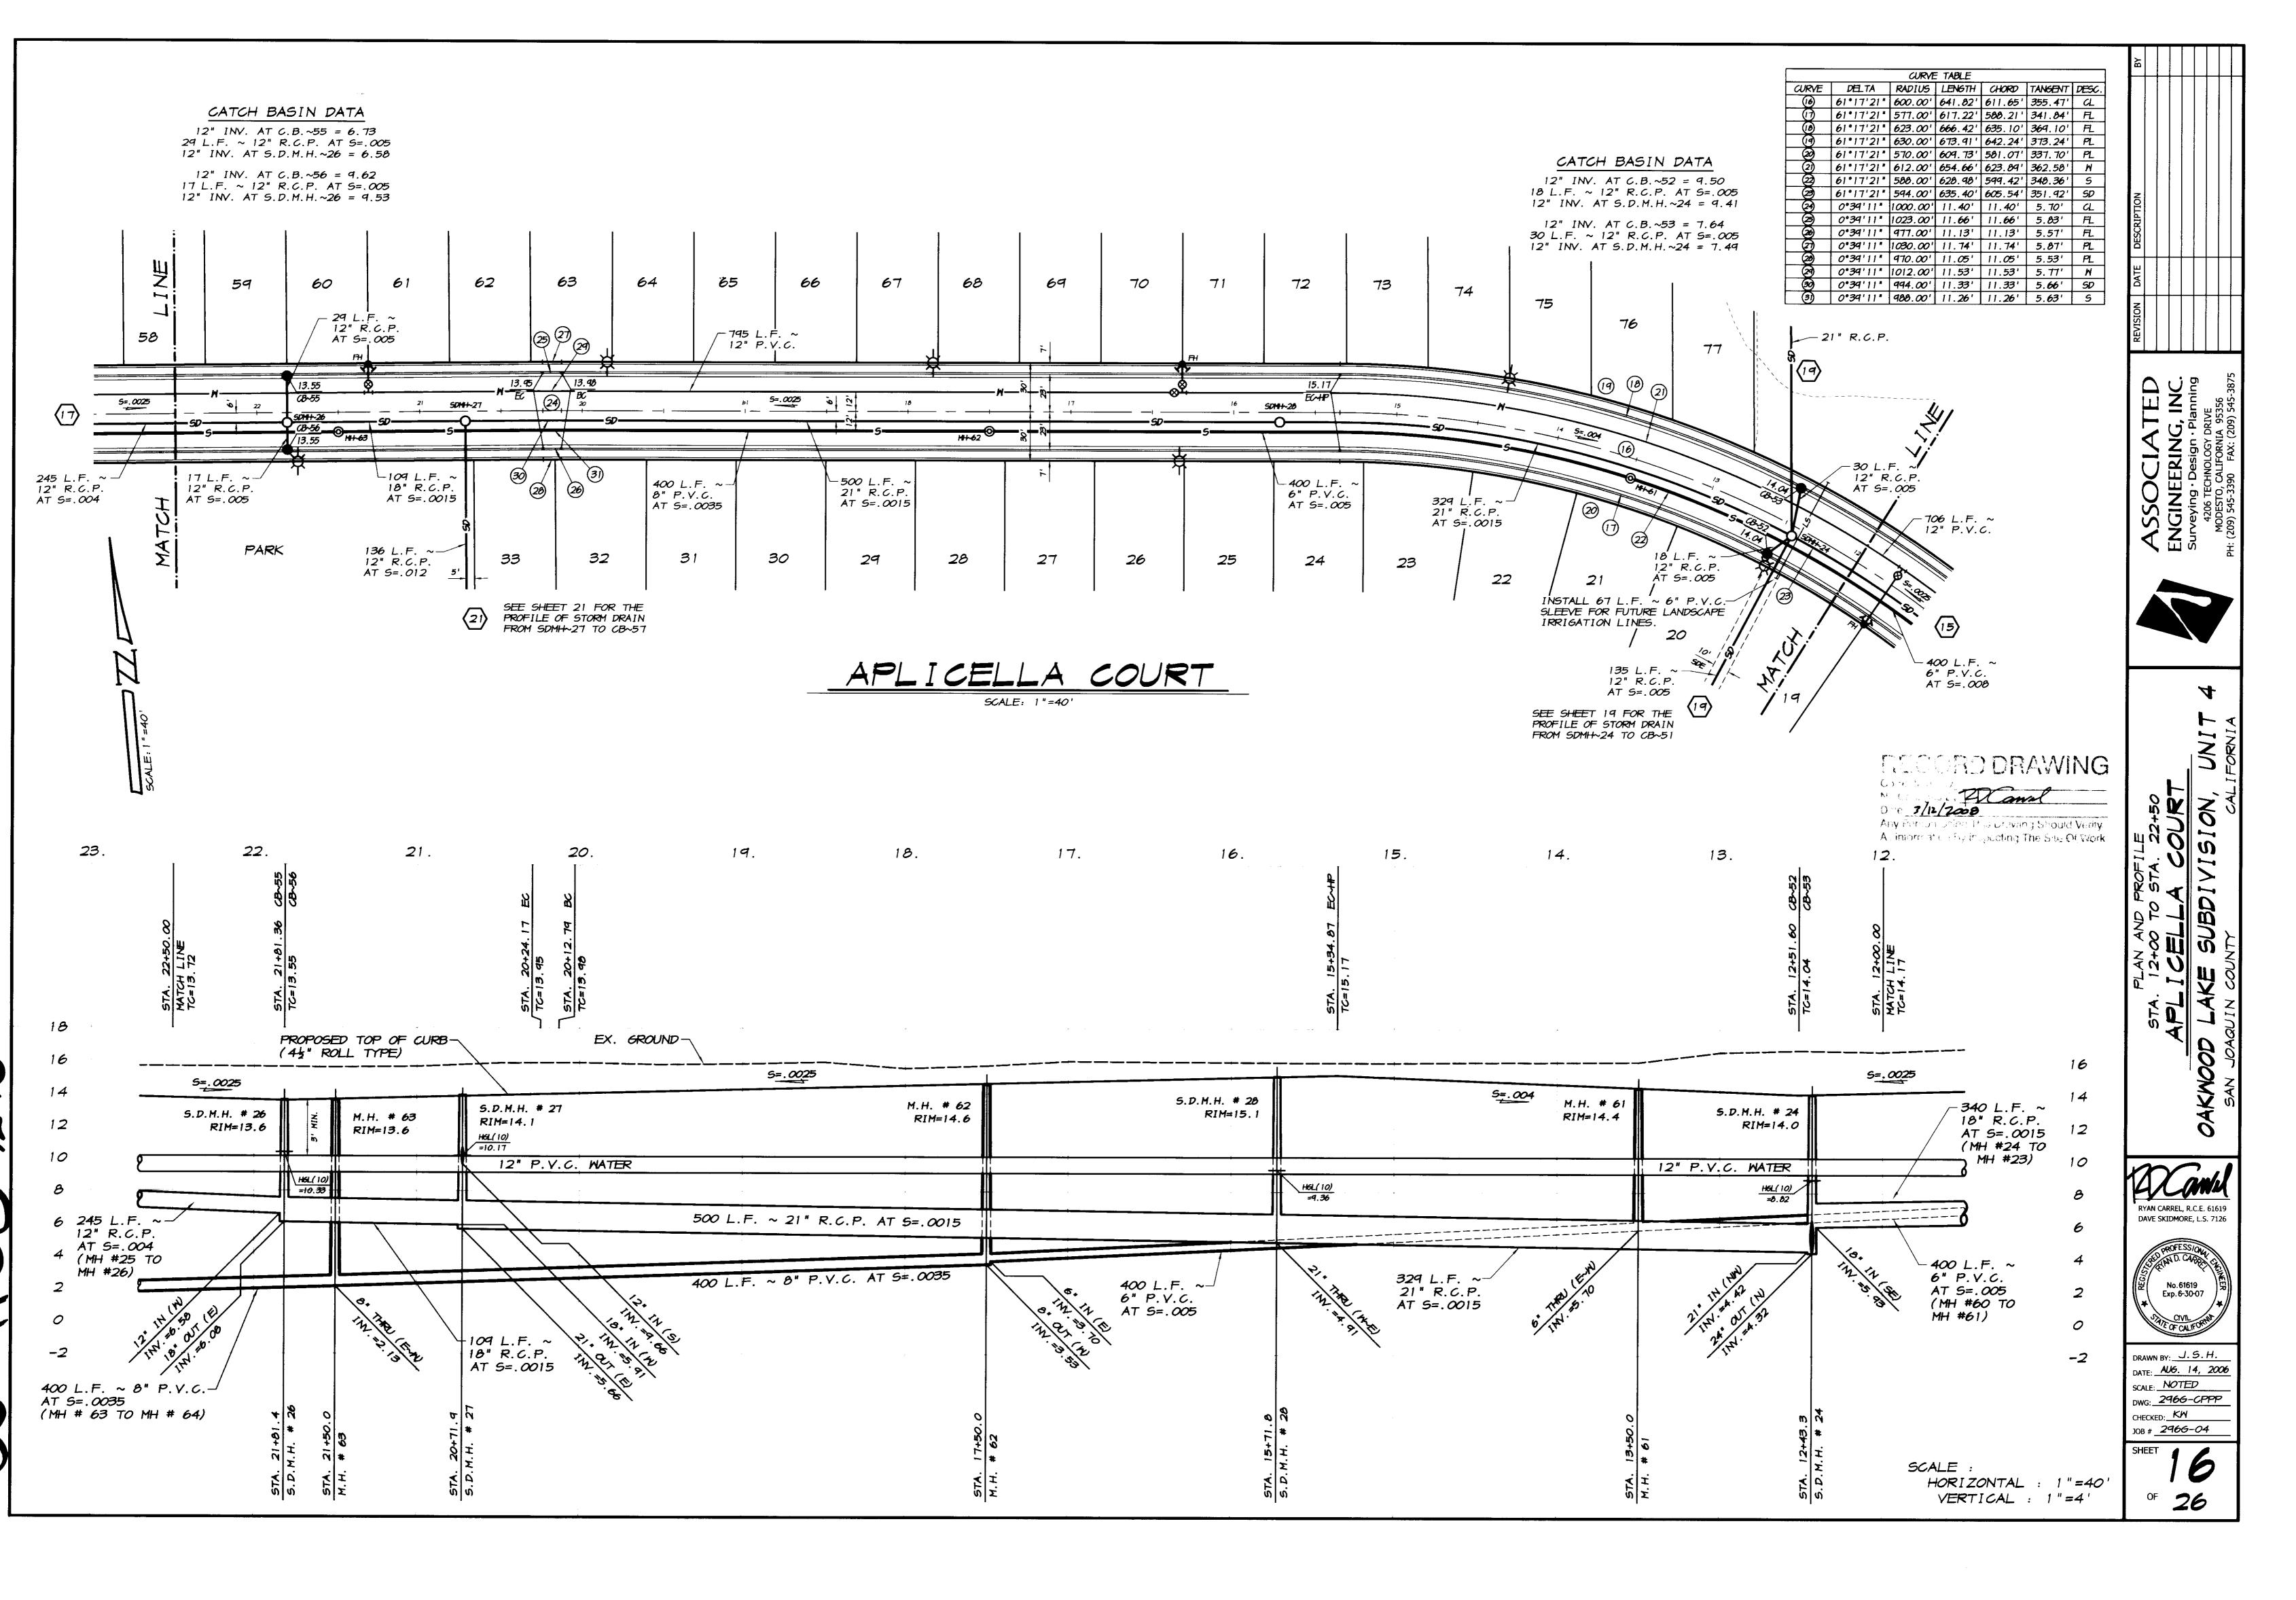
RYAN CARREL, R.C.E. 61619 DAVE SKIDMORE, L.S. 7126




DRAWN BY: J. S. H.

DATE: AUG. 14, 2006 SCALE: NOTED DWG: 2966-CPPP CHECKED: KW JOB # 2966-04

SHEET 1



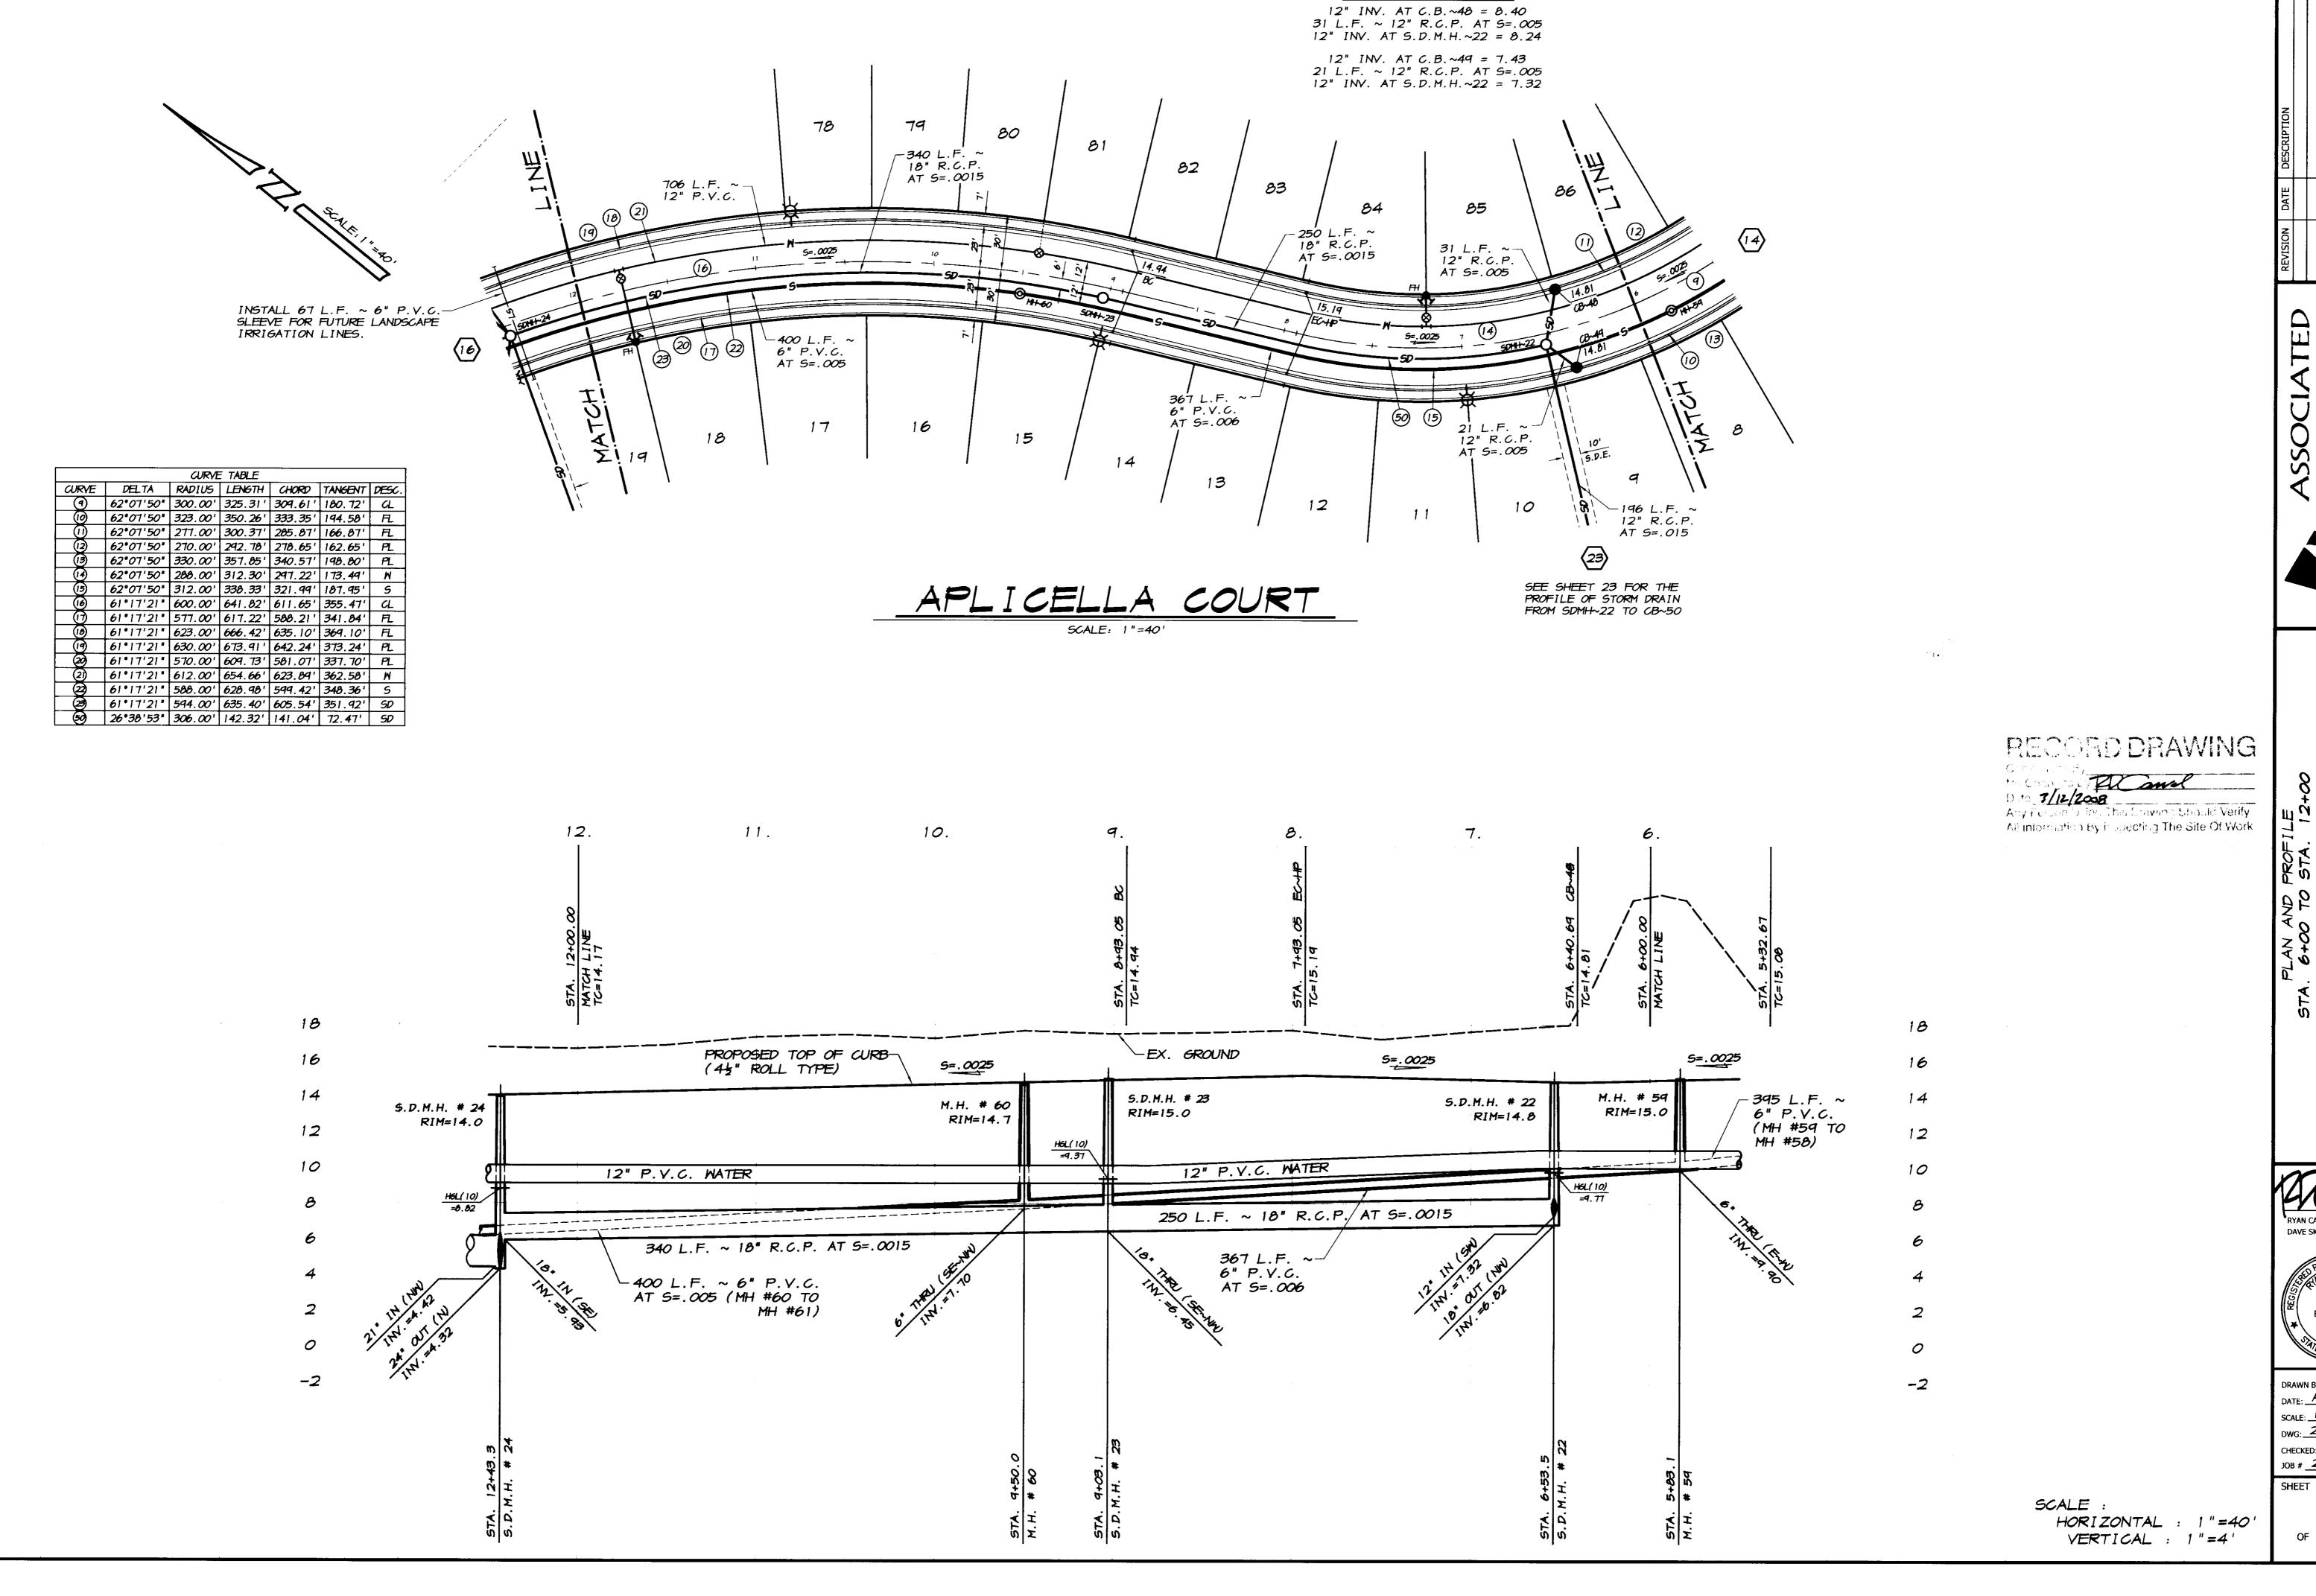

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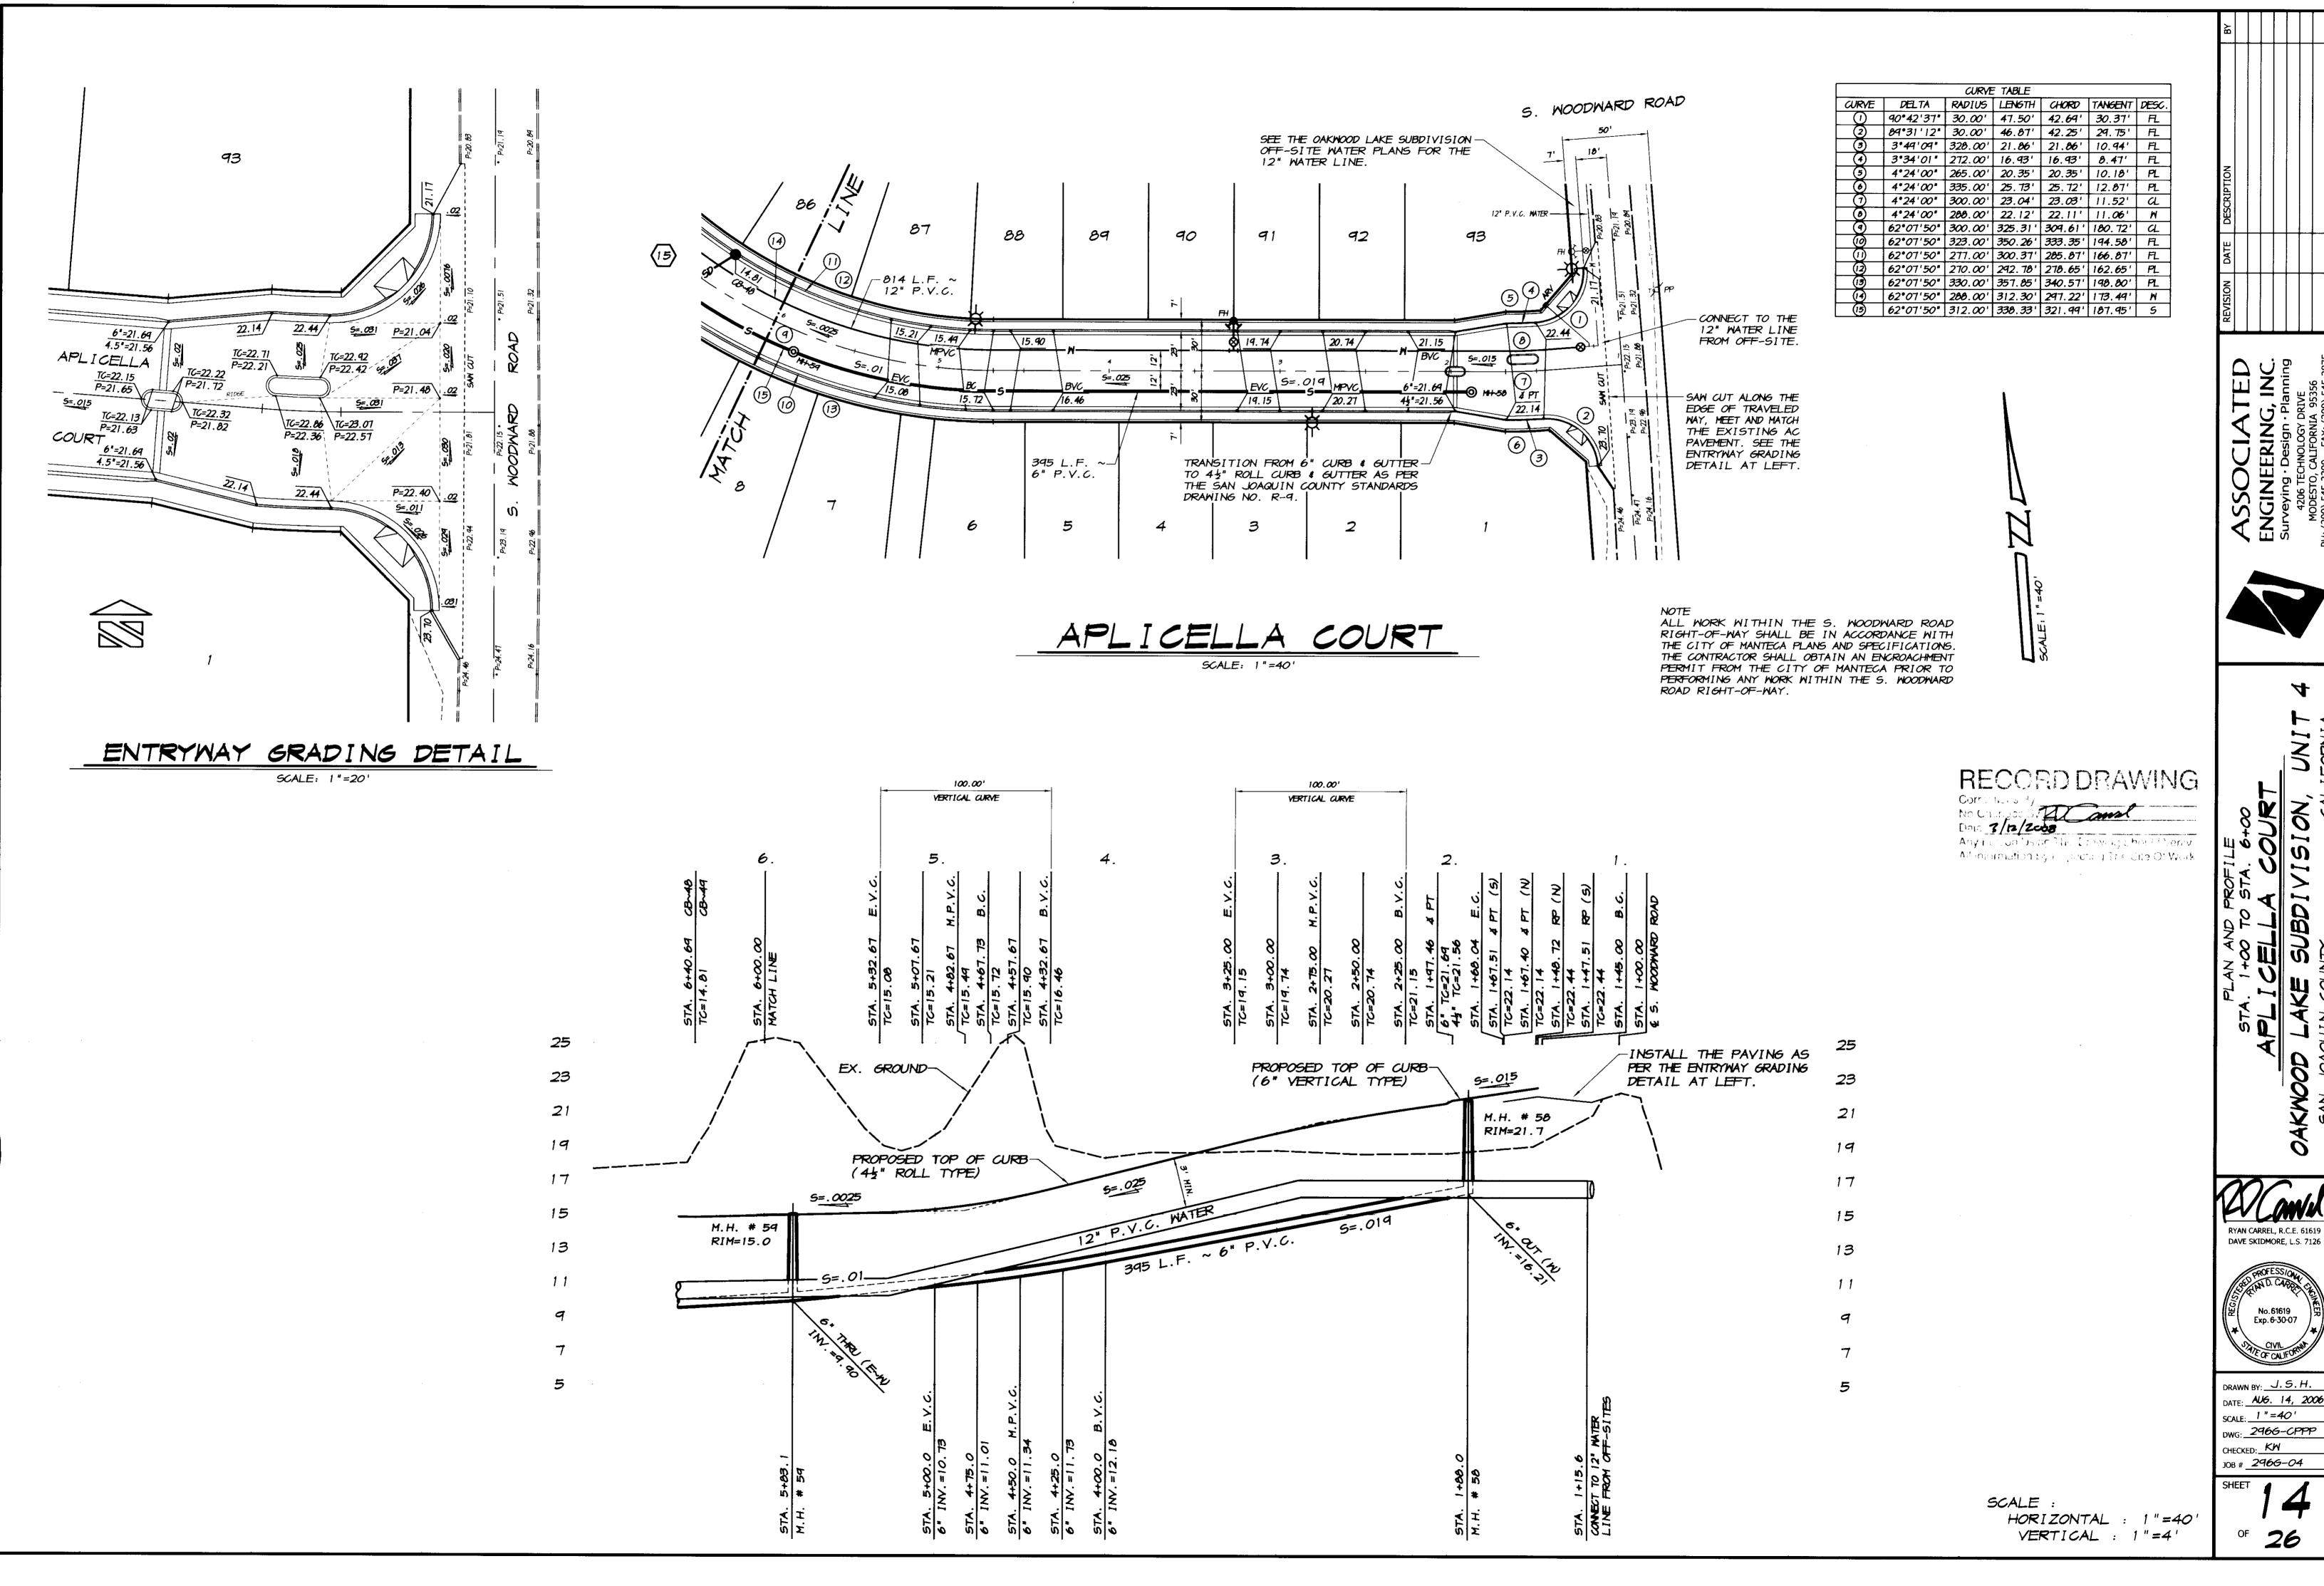


RYAN CARREL, R.C.E. 61619 DAVE SKIDMORE, L.S. 7126



DATE: AUG. 14, 2006 SCALE: NOTED DWG: 2966-CPPP CHECKED: KW

JOB # <u>2966-04</u>






DRAWN BY: J. S. H.

DATE: AUG. 14, 2006

SCALE: 1 " = 40' DWG: 2966-CPPP

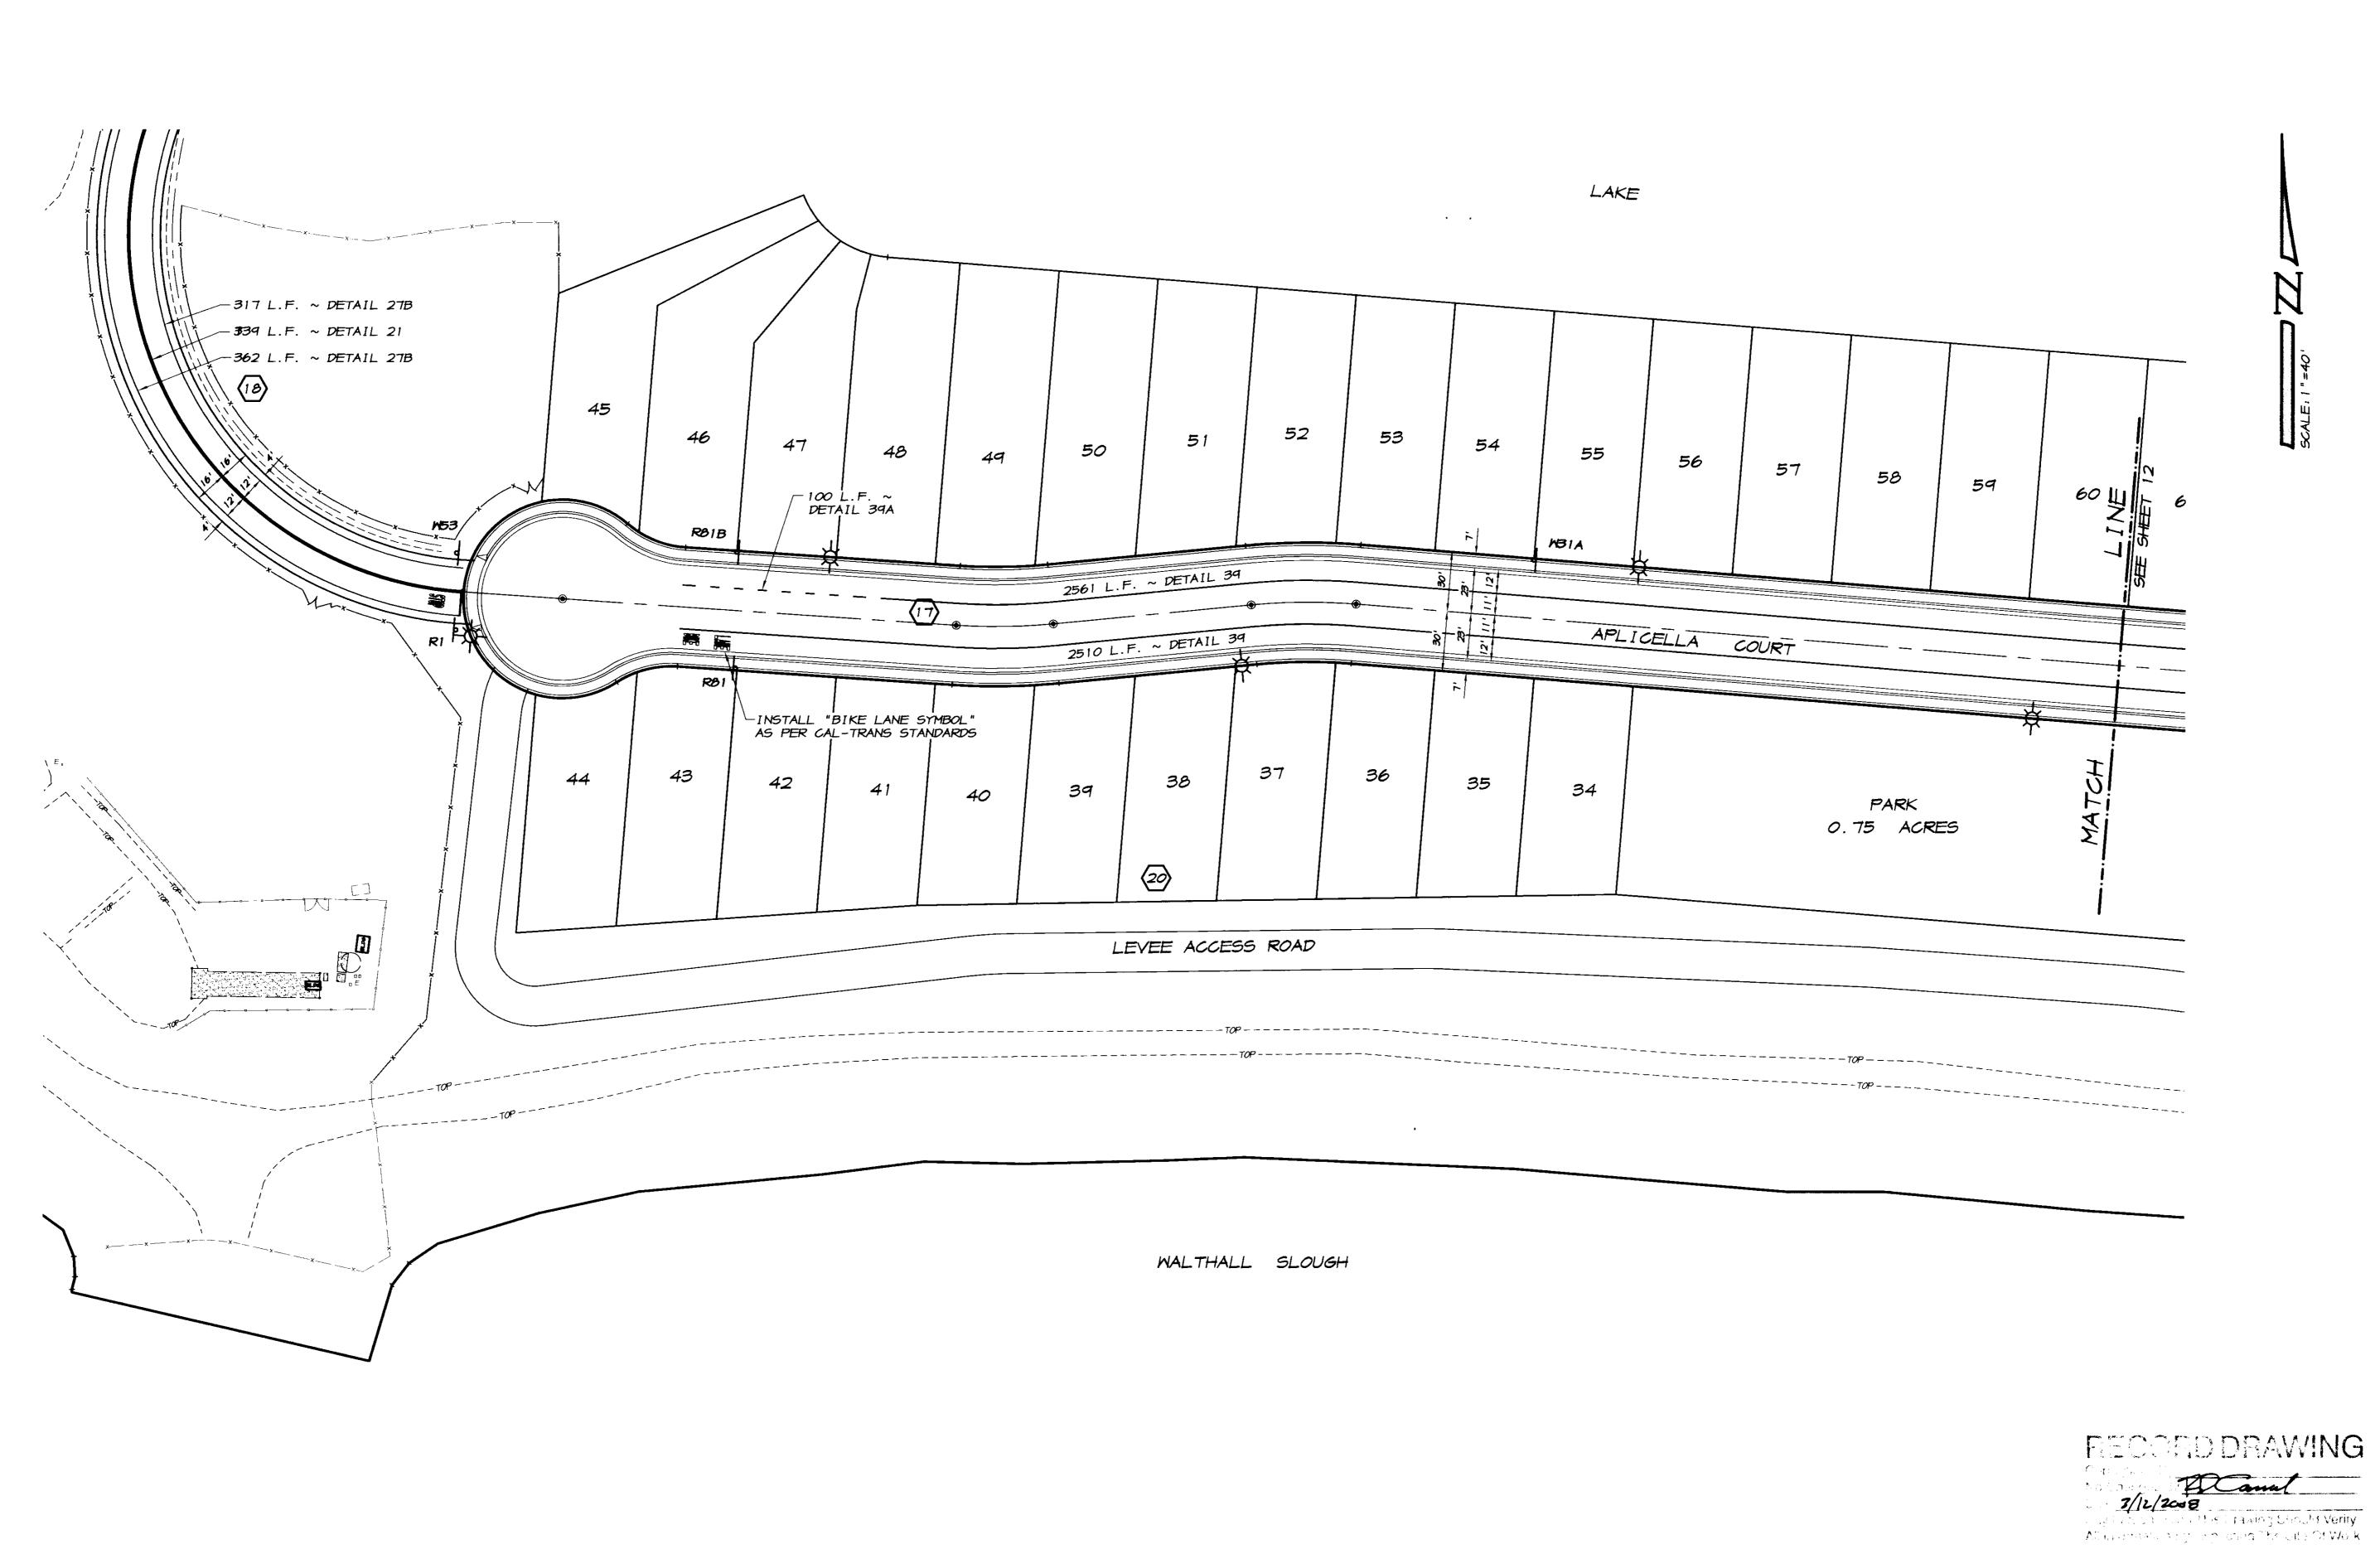


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RYAN CARREL R C F 61619



DRAWN BY: J. S. H.

DATE: AUG. 14, 2006

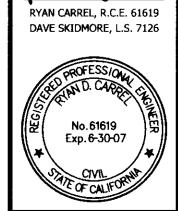
SCALE: 1 "=40'

DWG: 2966-STRIPE


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JOB # 2966-04


OF 26

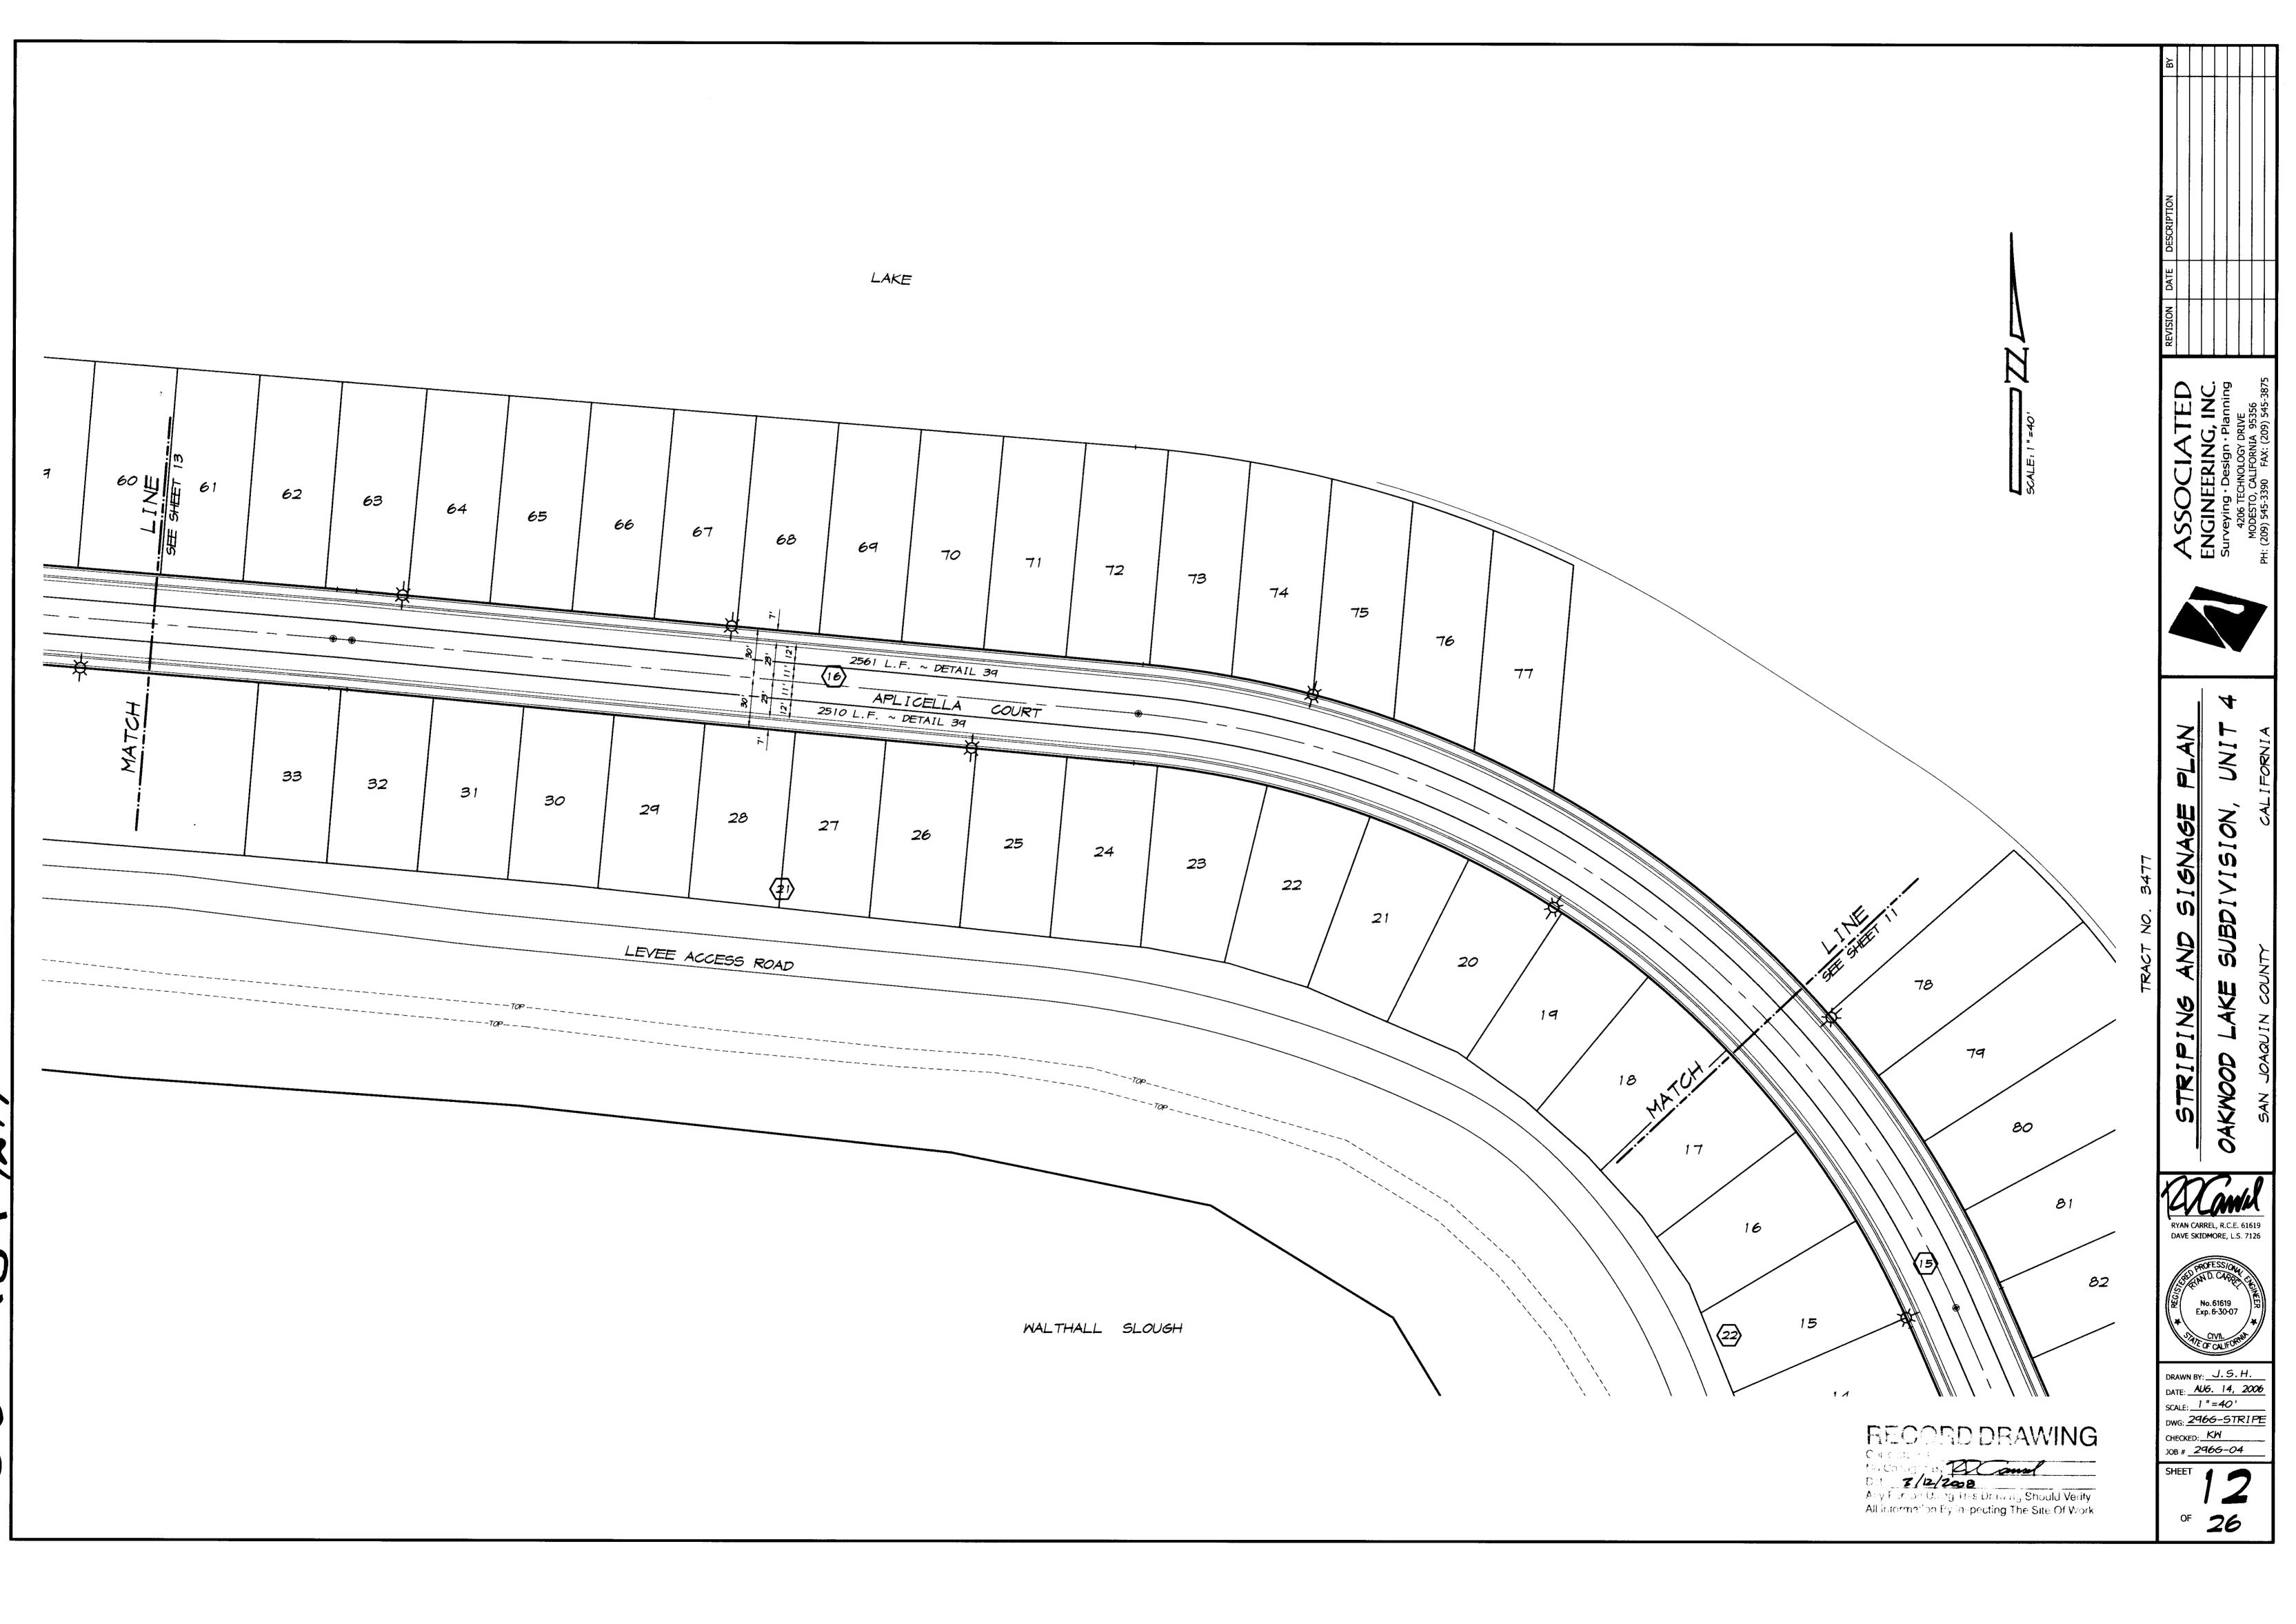

STRIPING NOTES LEGEND ALL WORK TO BE DONE SHALL BE DONE IN ACCORDANCE WITH THE REQUIREMENTS OF THE SAN JOAQUIN COUNTY DEPARTMENT OF PUBLIC WORKS PROPOSED STOP BAR AND LEGEND STANDARD SPECIFICATIONS AND THE LATEST EDITION OF THE STATE OF CALIFORNIA DEPARTMENT OF TRANSPORTATION, STANDARD SPECIFICATIONS. PROPOSED STOP SIGN R-25 2. THE DETAILS REFERRED TO ON THIS PLAN ARE THOSE AS SHOWN IN THE PROPOSED "BIKE LANE" SIGN CALIFORNIA DEPARTMENT OF TRANSPORTATION, TRAFFIC MANUAL, CHAPTER 6, "MARKINGS". PROPOSED "NOT A THROUGH STREET" SIGN THE CONTRACTOR SHALL REMOVE AND REPLACE ALL EXISTING PAVEMENT PROPOSED "ROAD ENDS 500 FT." SIGN MARKINGS THAT WOULD CONFLICT WITH EXISTING TRAFFIC PATTERNS. THE CONTRACTOR SHALL BE RESPONSIBLE FOR ANY TEMPORARY STRIPING THAT MAY PROPOSED STREET NAME SIGN R-23 BE REQUIRED. PROPOSED MONUMENT WELL 4. ALL LINES AND LEGENDS SHALL BE INSTALLED USING THERMOPLASTIC AND RAISED CERAMIC MARKERS UNLESS OTHERWISE NOTED ON THE PLANS. PLAN & PROFILE SHEET NUMBER THE CONTRACTOR SHALL CONDUCT HIS WORK TO INTERFERE AS LITTLE AS POSSIBLE WITH THE PUBLIC TRAVEL, WHETHER VEHICULAR OR PEDESTRIAN. WHENEVER IT NECESSARY TO CROSS, OBSTRUCT, OR CLOSE ROADS, DRIVENAYS 78 AND WALKS, PUBLIC OR PRIVATE, THE CONTRACTOR SHALL PROVIDE AND MAINTAIN SUITABLE AND SAFE DETOURS, OR TEMPORARY EXPEDIENTS FOR THE ACCOMODATION OF PUBLIC AND PRIVATE TRAVEL AND SHALL GIVE REASONABLE NOTICE TO OWNERS OF PRIVATE DRIVES BEFORE INTERFERING WITH THEM. SUCH MAINTENANCE OF TRAFFIC WILL NOT BE REQUIRED WHEN THE CONTRACTOR HAS OBTAINED WRITTEN PERMISSION FROM THE OWNER AND TENANT OF PRIVATE 79 PROPERTY OR FROM AUTHORITY HAVING JURISDICTION OVER PUBLIC PROPERTY INVOLVED, TO OBSTRUCT TRAFFIC AT THE DESIGNATED POINT. 18 RS 10-200 THE CONTRACTOR SHALL ADHERE TO ALL REQUIREMENTS OF THE LATEST EDITION OF THE STATE OF CALIFORNIA, MANUAL OF TRAFFIC CONTROLS FOR CONSTRUCTION AND MAINTENANCE ZONES. ANY PROPOSED DEVIATION OR MODIFICATIONS TO THESE TRAFFIC CONTROL REQUIREMENTS SHALL BE 80 SUBMITTED TO THE CITY, COUNTY OR STATE, WHICHEVER IS APPROPRIATE, FOR APPROVAL. 17 1. THE CONTRACTOR SHALL COMPLY WITH ALL LOCAL, STATE, AND FEDERAL SAFETY REGULATIONS PERTAINING TO HIS OPERATIONS. HE SHALL PROVIDE ALL LIGHTS, SIGNS, BARRICADES, FLAG MEN OR OTHER DEVICES NECESSARY FOR PUBLIC SAFETY. THE CONTRACTOR'S ATTENTION IS CALLED TO THE 81 REQUIREMENTS OF TITLE 8 OF THE CALIFORNIA ADMINISTRATIVE CODE, SUBCHAPTER 4, ARTICLE 6, "EXCAVATIONS, TRENCHES, EARTHWORK." 16 8. ALL BARRICADES AND OBSTRUCTIONS SHALL BE ILLUMINATED WITH WARNING LIGHTS FROM SUNSET TO SUNRISE. MATERIAL STORAGE AND CONDUCT OF THE WORK ON OR ALONGSIDE PUBLIC STREETS AND HIGHWAYS SHALL CAUSE THE MINIMUM OBSTRUCTION AND INCONVENIENCE TO THE TRAVELING PUBLIC. 82 ALL BARRICADES, SIGNS, LIGHTS AND OTHER PROTECTIVE DEVICES SHALL BE INSTALLED AND MAINTAINED IN CONFORMANCE WITH APPLICABLE STATUTORY REQUIREMENTS, AND WHERE WITHIN RAILROAD AND HIGHWAY RIGHT-OF-WAY, AS 15 (22) REQUIRED BY THE AUTHORITY HAVING JURISDICTION THEREOVER. 10. THE CONTRACTOR SHALL NOTIFY OWNERS OF ADJACENT PROPERTIES AND 83 UTILITIES WHEN PROSECUTION OF THE WORK MAY AFFECT THEM. WHEN IT IS NECESSARY TO DENY ACCESS TO PROPERTY, OR WHEN ANY UTILITY SERVICE CONNECTION MUST BE INTERRUPTED, THE CONTRACTOR SHALL GIVE NOTICES 14 NOT LESS THAN FORTY-EIGHT HOURS IN ADVANCE TO ENABLE THE AFFECTED PERSONS TO PROVIDE FOR THEIR NEEDS. NOTICES SHALL CONFORM TO ANY APPLICABLE LOCAL ORDINANCES AND, WHETHER DELIVERED IN WRITING OR ORALLY, WILL INCLUDE APPROPRIATE INFORMATION CONCERNING THE 84 INTERRUPTION AND INSTRUCTIONS ON HOW TO LIMIT THEIR INCONVENIENCE. UTILITIES AND OTHER CONCERNED AGENCIES SHALL BE CONTACTED AT LEAST FORTY-EIGHT HOURS PRIOR TO CUTTING OR CLOSING A STREET OR OTHER 13 TRAFFIC AREA, EXCAVATING NEAR UNDERGROUNG UTILITIES OR POLE LINES, OR PERFORMING WORK WHICH WILL AFFECT THEIR OPERATIONS. THE CONTRACTOR SHALL CONTACT UNDERGROUND SERVICE ALERT AT PH: (800) 85 227-2600 TO LOCATE ALL UNDERGROUND UTILITIES PRIOR TO CONSTRUCTION. 12. THE CONTRACTOR SHALL BE RESPONSIBLE FOR ALL AREAS OF THE SITE USED BY HIM AND ALL SUBCONTRACTORS IN THE PERFORMANCE OF THEIR WORK. THE 12 CONTRACTOR SHALL EXERT FULL CONTROL OVER ALL THE ACTIONS OF ALL 86 EMPLOYEES AND OTHER PERSONS WITH RESPECT TO THE USE AND PRESERVATION OF PROPERTY AND FACILITIES, EXCEPT SUCH CONTROLS AS MAY BE F) SPECIFICALLY RESERVED TO THE OWNER OR OTHERS. THE CONTRACTOR HAS THE 87 THE RIGHT TO EXCLUDE FROM THE SITE ALL PERSONS WHO HAVE NO PURPOSE 88 RELATED TO THE WORK OR ITS INSPECTION, AND MAY REQUIRE ALL PERSONS 89 90 ON THE SITE (EXCEPT OWNERS EMPLOYEES) TO OBSERVE THE SAME 91 92 REGULATIONS AS HE REQUIRES OF HIS EMPLOYEES. 11 INSTALL "BIKE LANE SYMBOL" AS PER CAL-TRANS STANDARDS 47 L.F. ~-DETAIL 39 10 2561 L.F. ~ DETAIL 39 -16 L.F. ~ DETAIL 21 APLICELLA 9 9 2510 L.F. ~ DETAIL 39 START LIMIT LINE AT BACK OF HANDICAP RAMP 8 150 L.F. ~-DETAIL 39A 51 L.F. DETAIL 39A DAVE SKIDMORE, L.S. 7126 -STANDARD 12" LIMIT LINE 6 AND LEGEND PER CAL TRANS TRAFFIC MANUAL SEC. 6-02.11 RI SIGN AS PER LOCAL No.61619 Exp.6-30-07 STANDARDS. LOCATE SIGN 1' BEHIND BACK OF SIDEWALK ADJACENT TO THE R.P. DRAWN BY: J.S.H. DATE: AUG. 14, 2006 STOP BAR SCALE: 1 " = 40' LEGEND DETAIL DWG: 2966-STRIP CHECKED: KM RECORD DRAWING NO SCALE JOB # 2966-04 SHEET Any Period Unity by the Entering Charact Verilia All information 5, to peeting The She Of Work OF 26

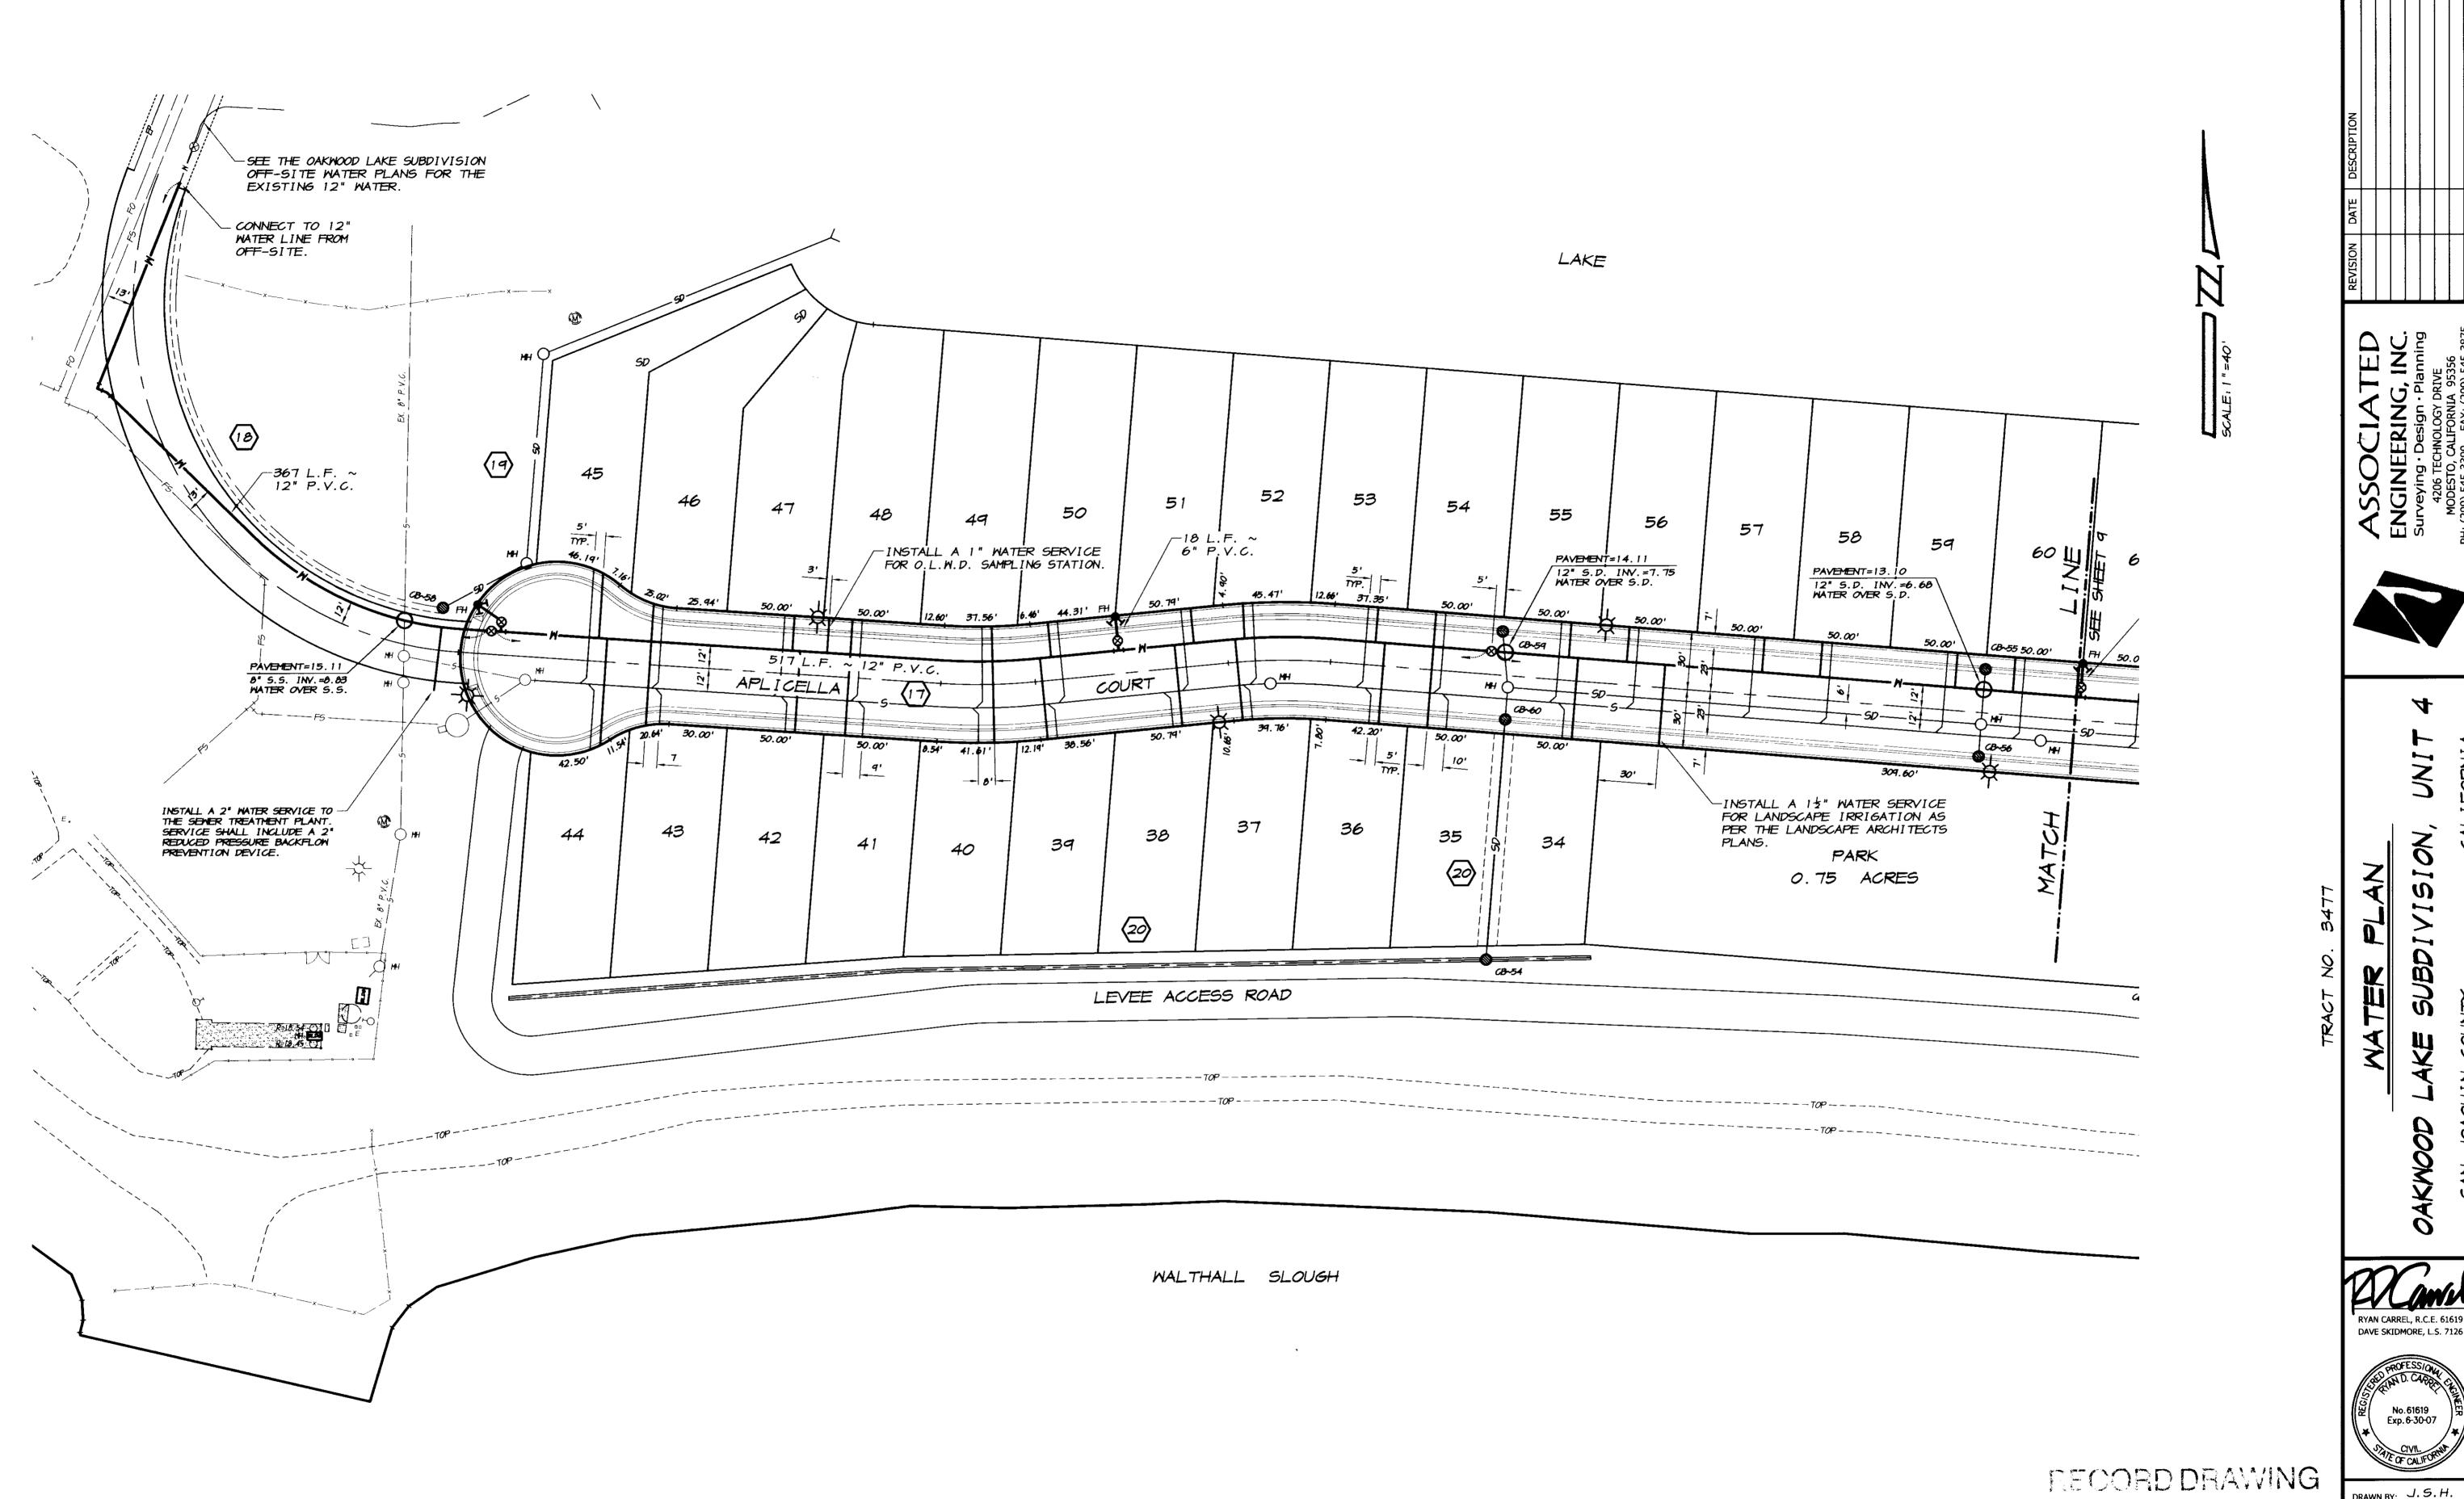

RYAN CARREL, R.C.E. 61619 DAVE SKIDMORE, L.S. 7126

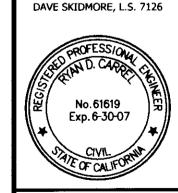


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DATE: AUG. 14, 2006 SCALE: 1 " =40' DWG: 2966-WTR CHECKED: KW

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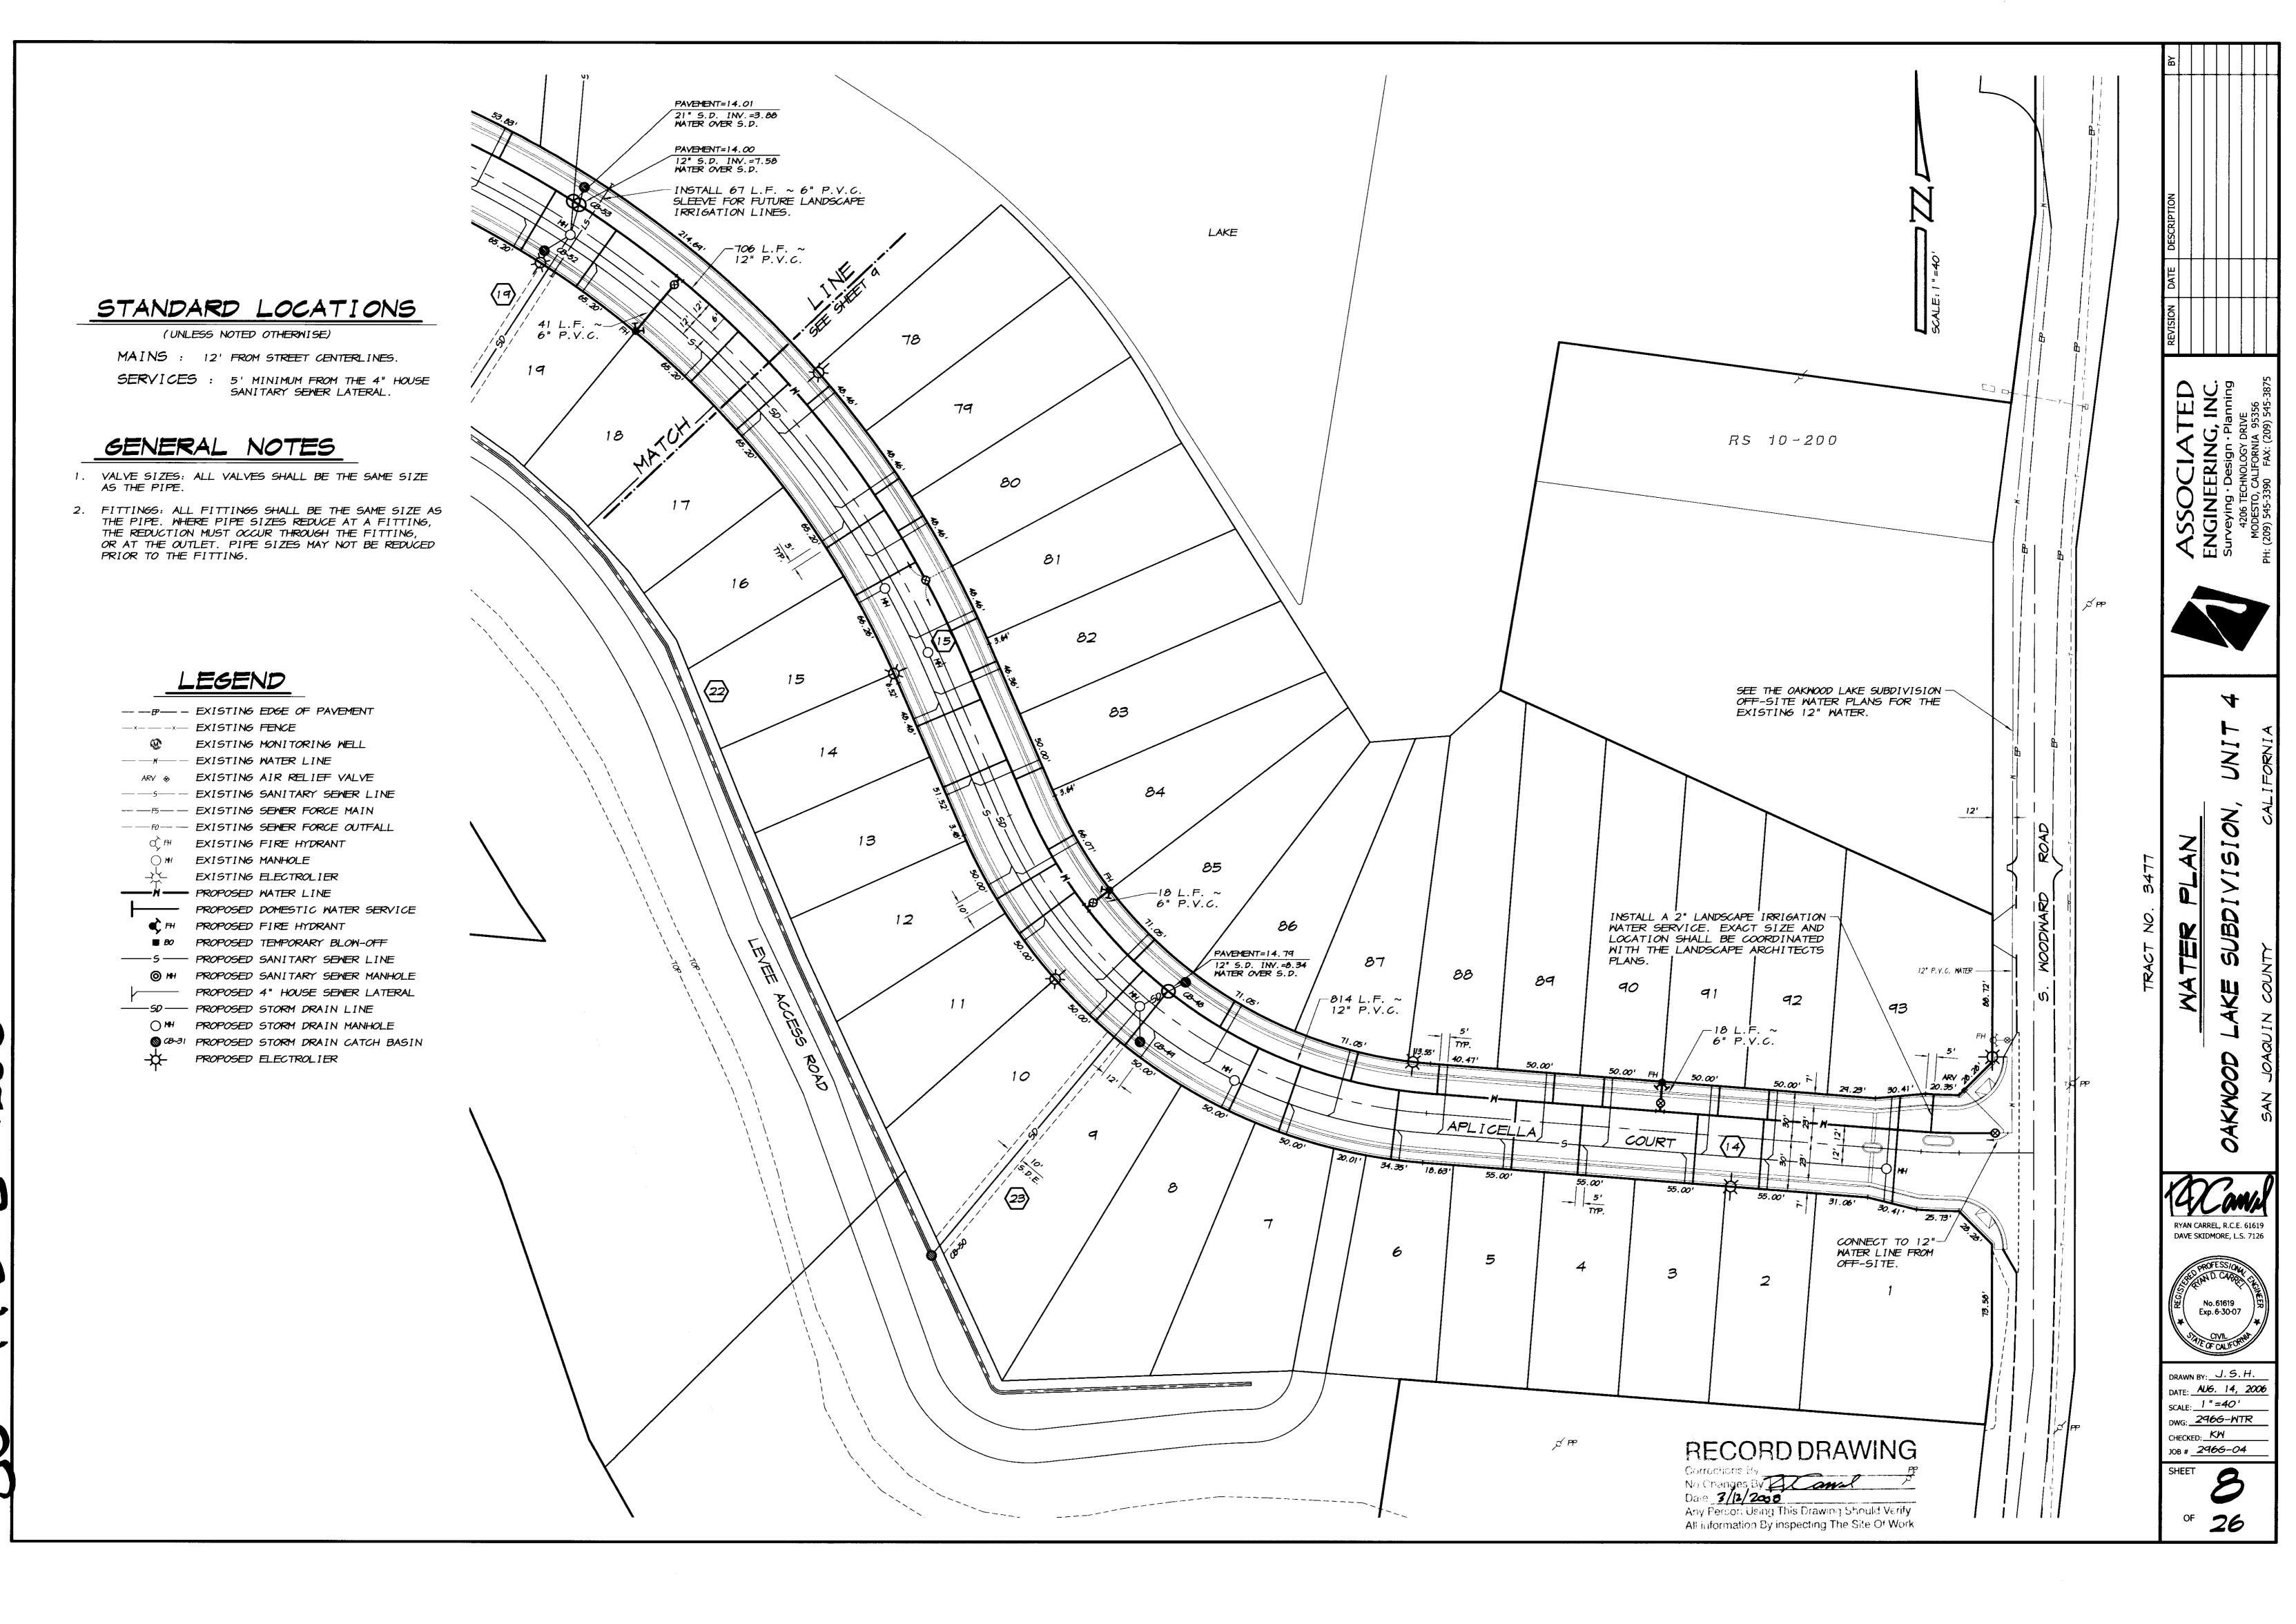
RYAN CARREL, R.C.E. 61619 DAVE SKIDMORE, L.S. 7126




DRAWN BY: J. S. H.
DATE: AUG. 14, 2006

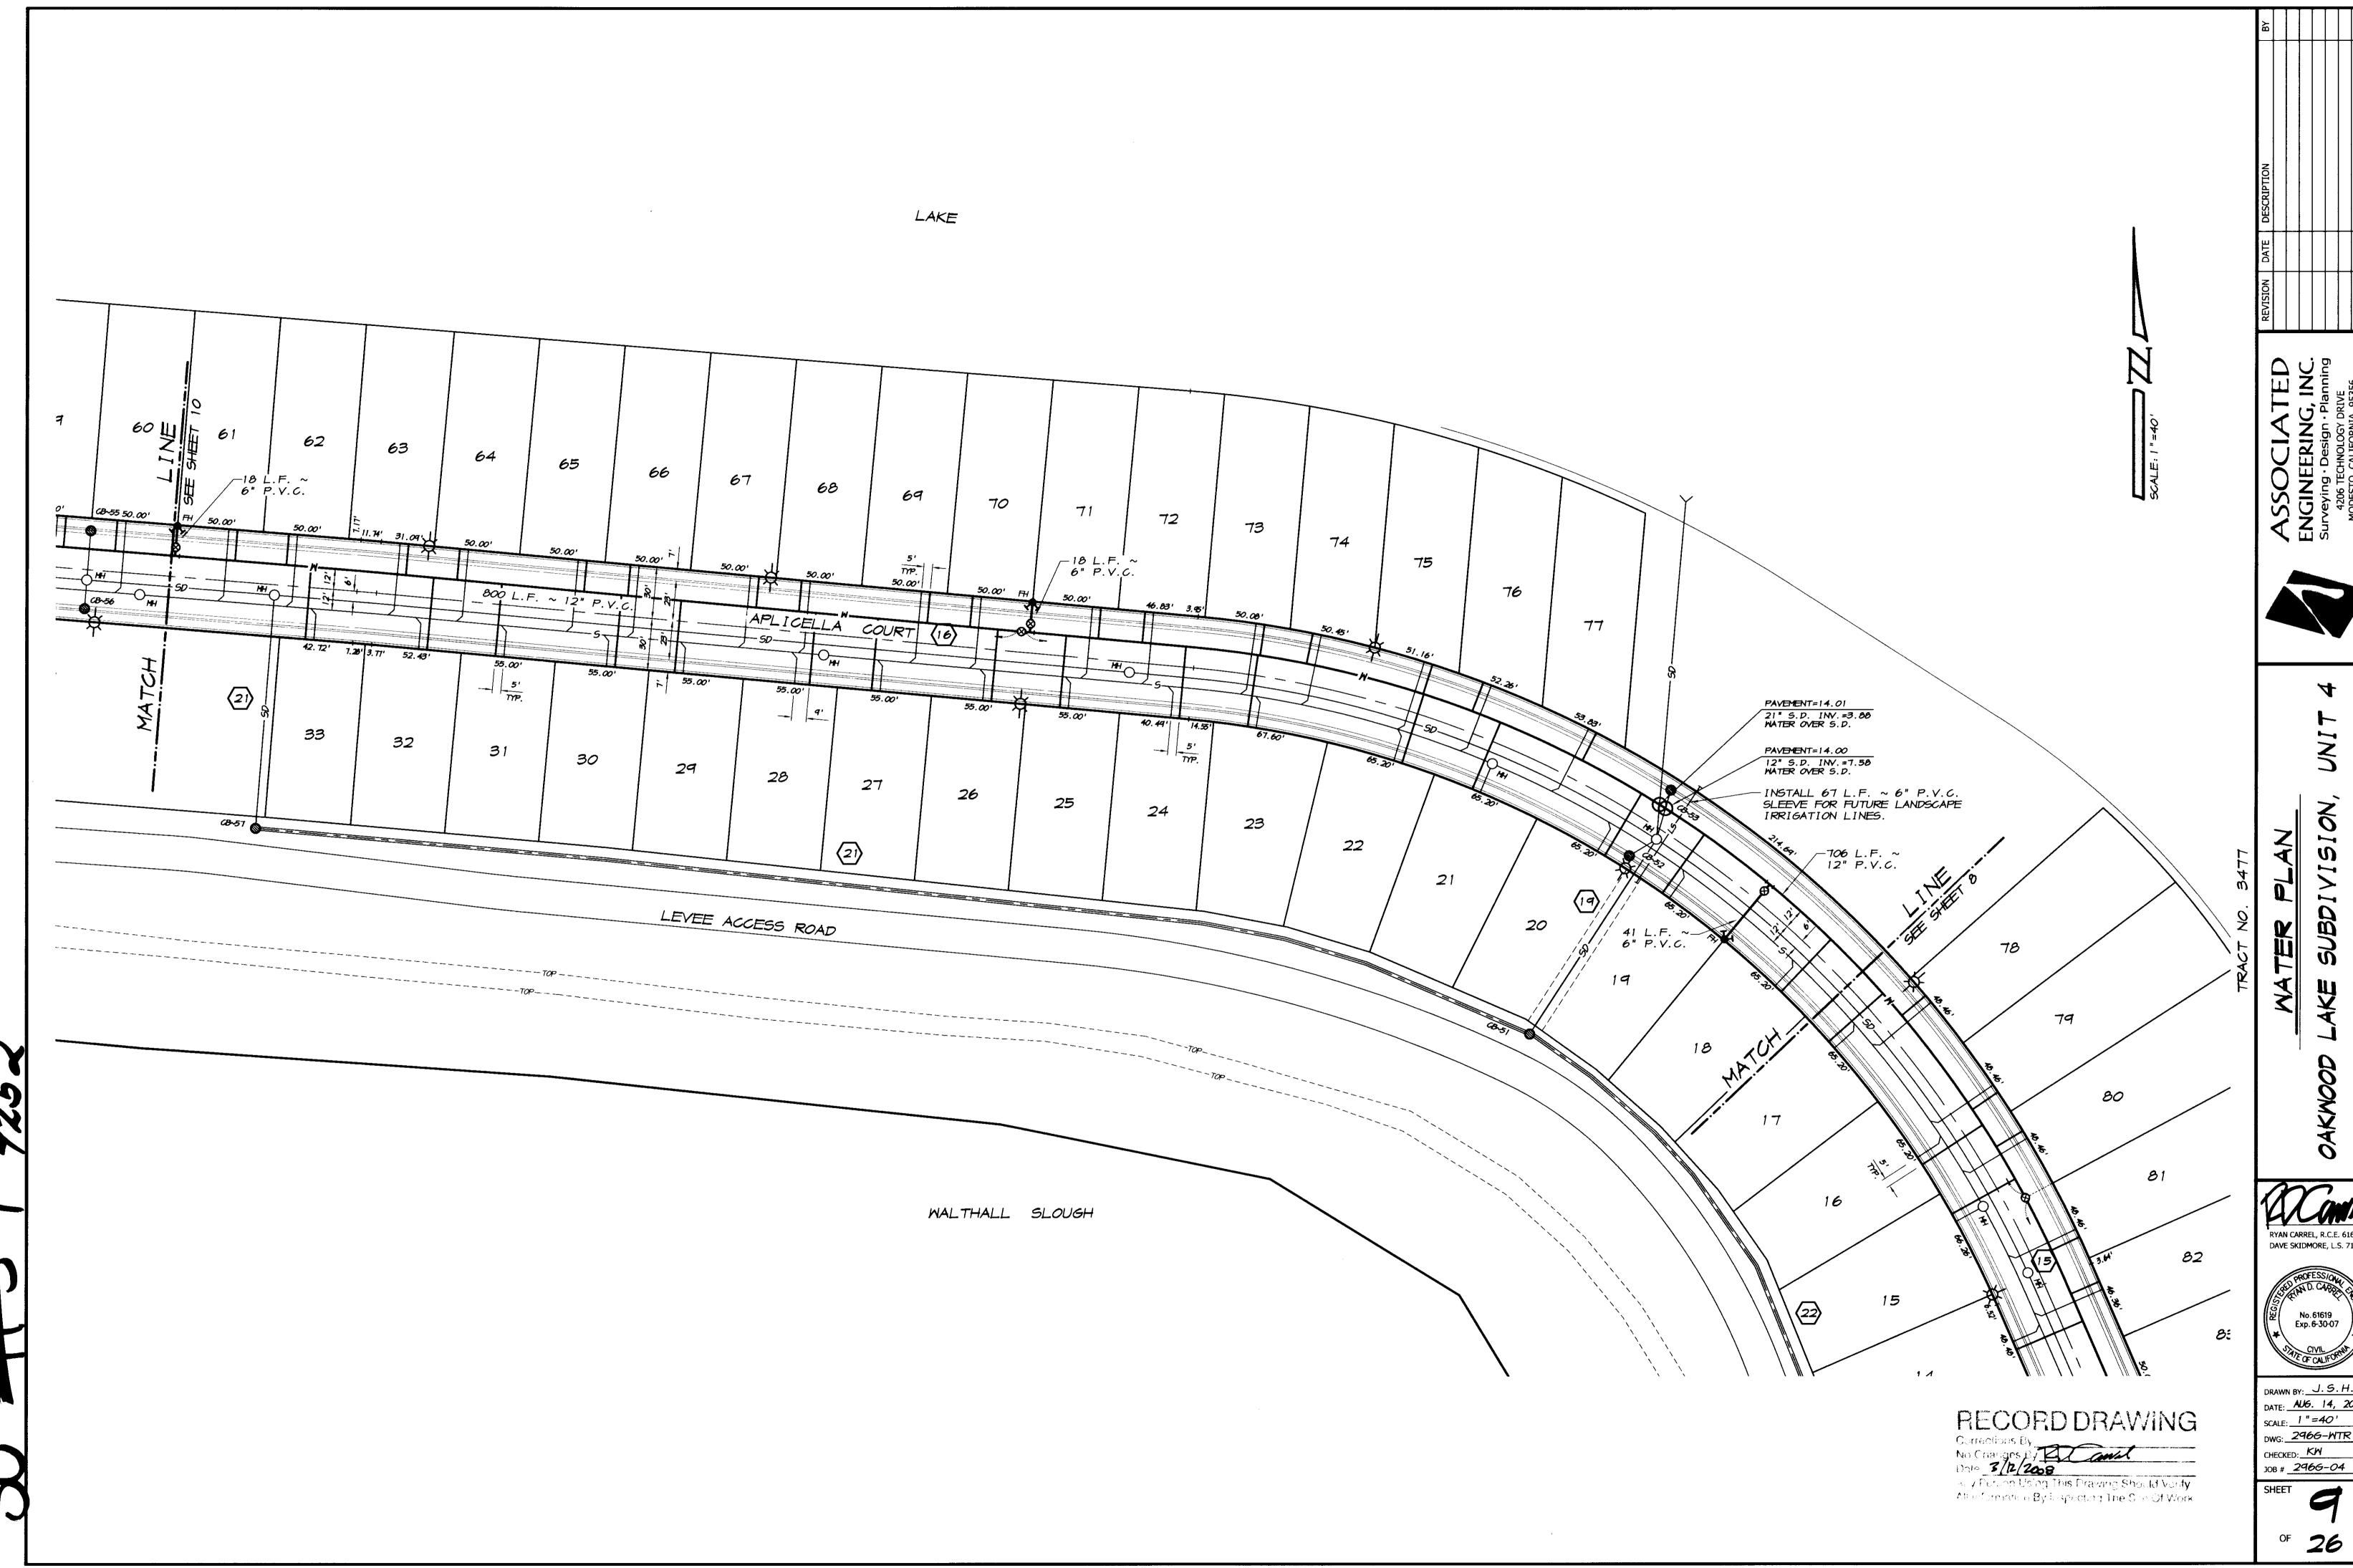SCALE: 1 " =40 ' DWG: 2966-WTR CHECKED: KW

JOB # **2966-04**



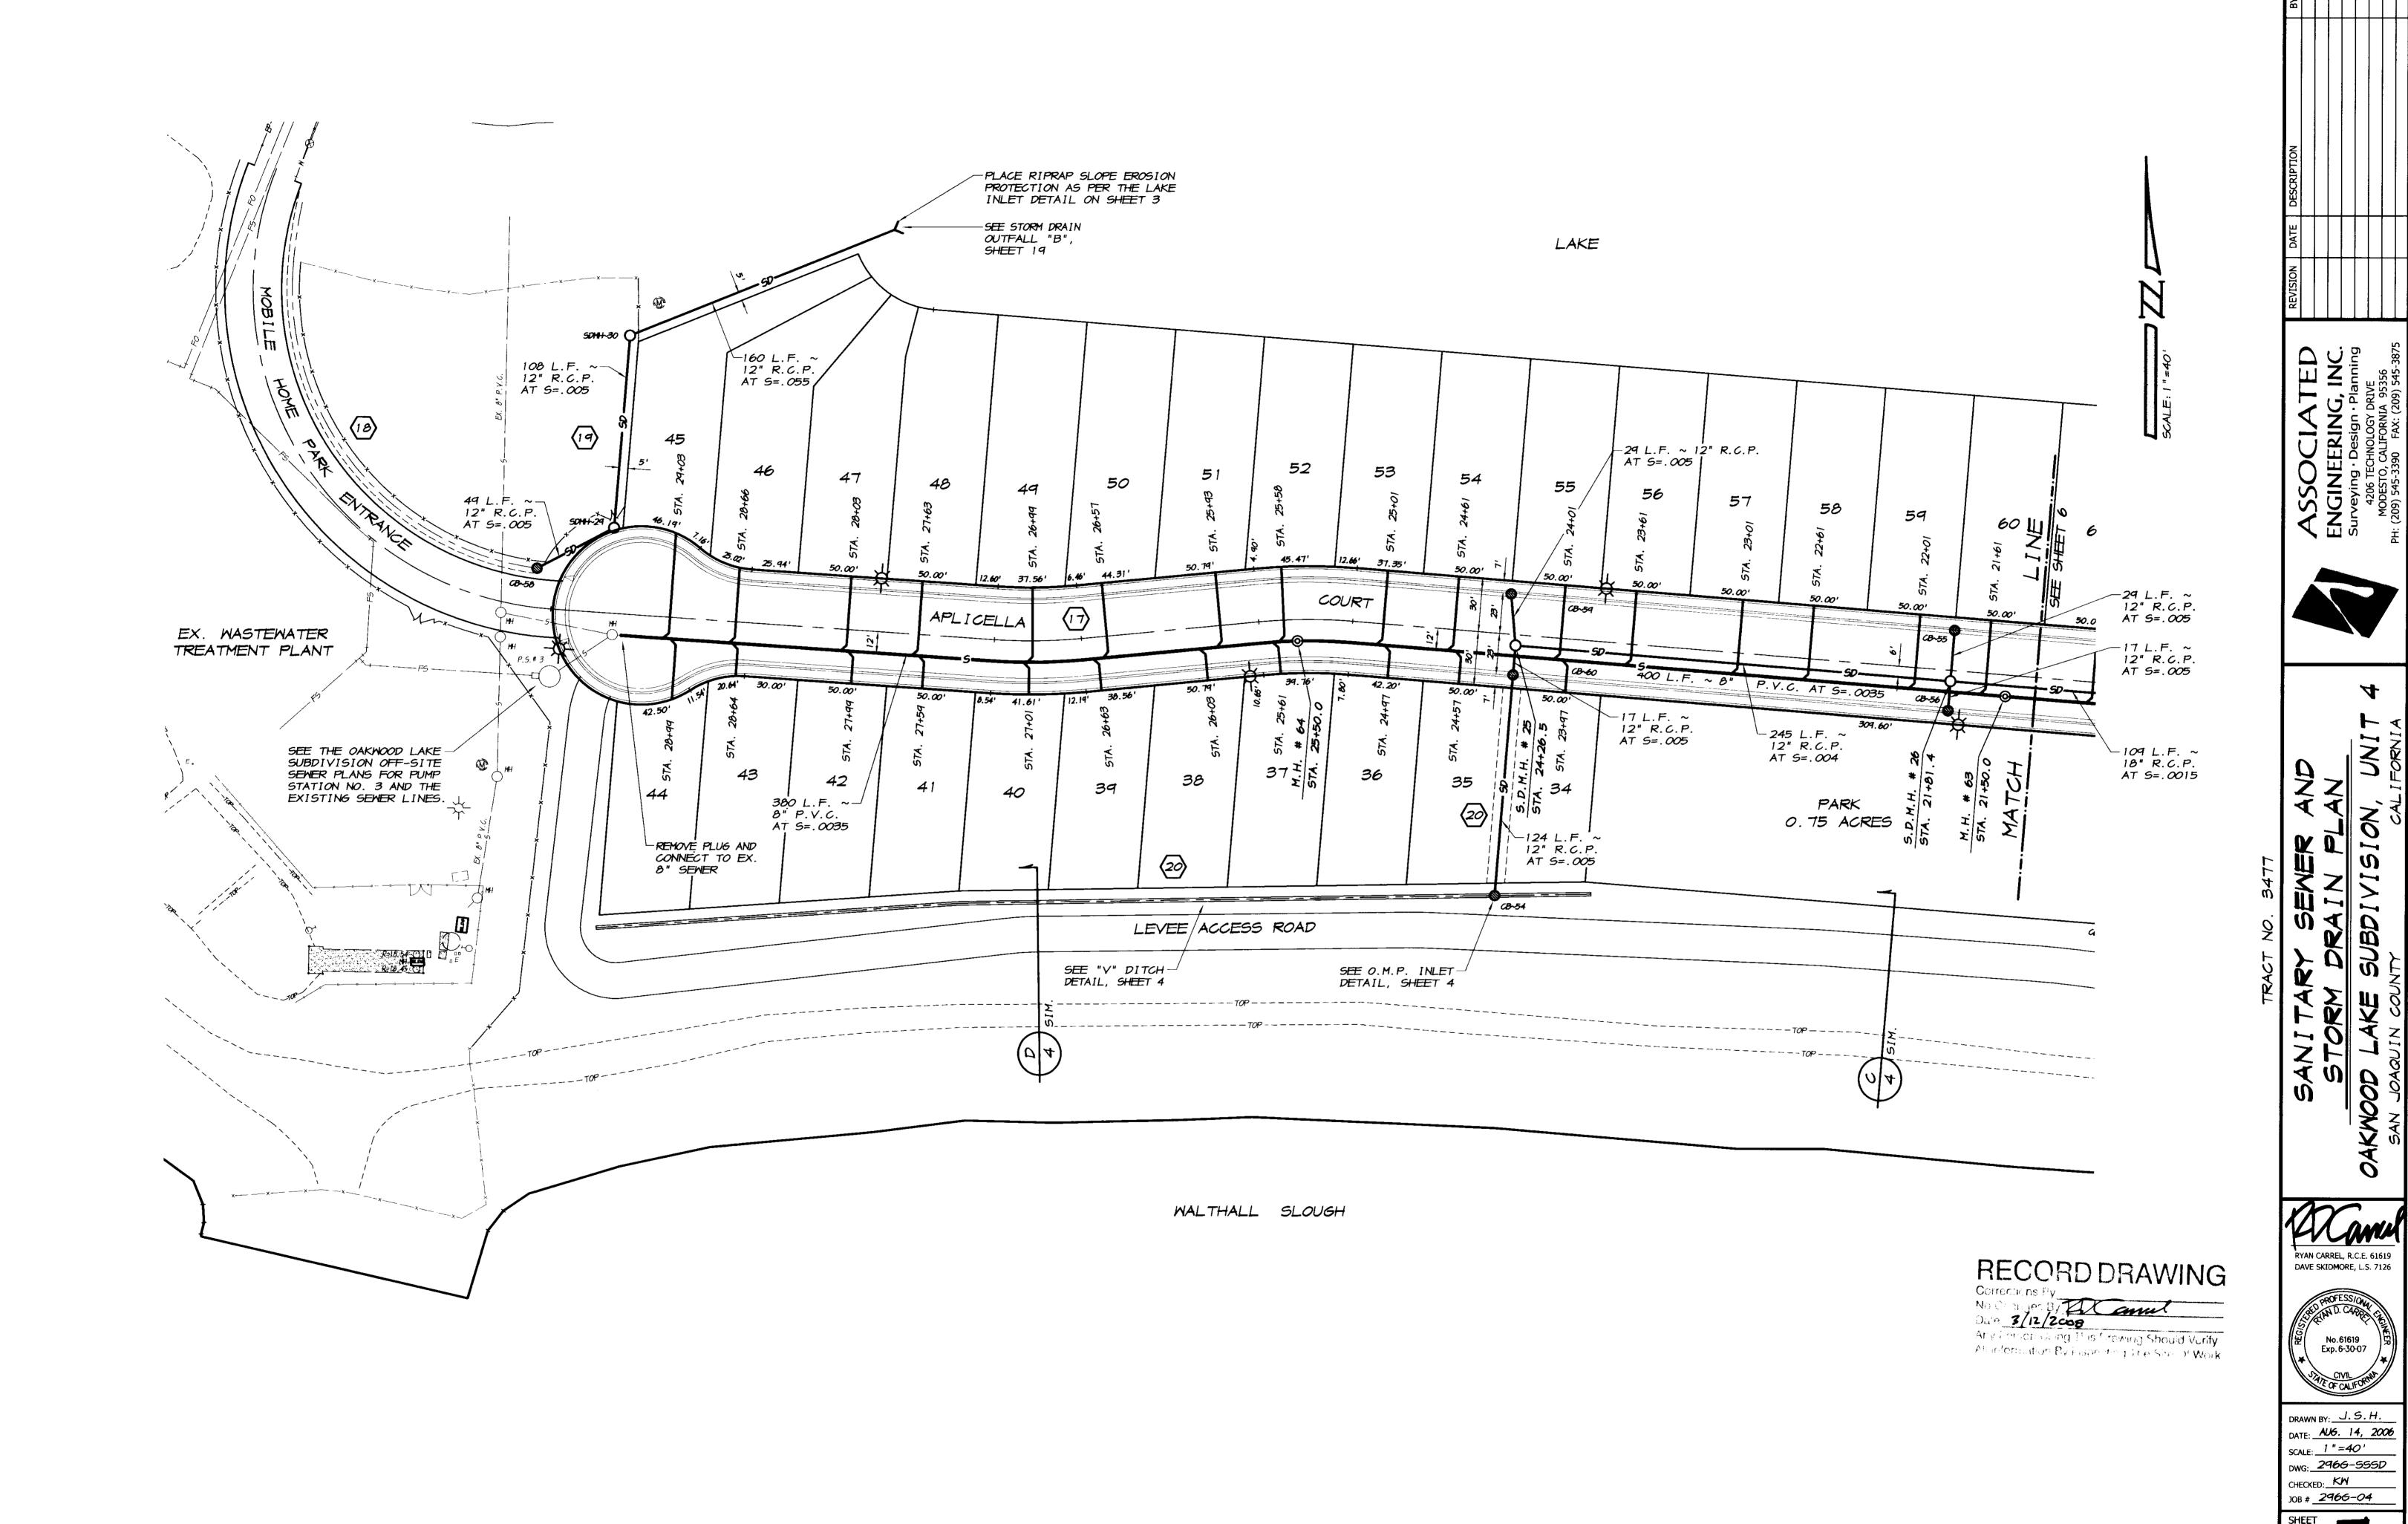


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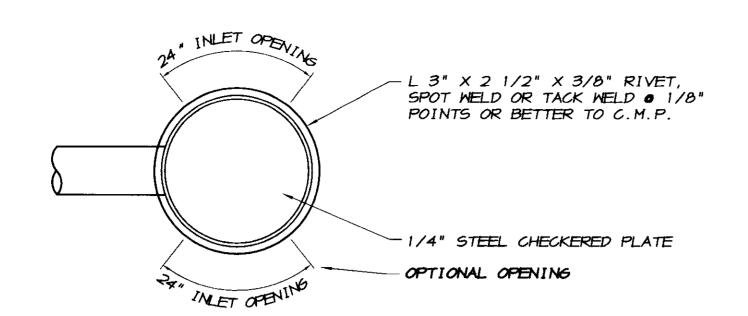
RYAN CARREL, R.C.E. 61619 DAVE SKIDMORE, L.S. 7126




DRAWN BY: J.S.H. DATE: AUG. 14, 2006 SCALE: 1 " =40' DWG: 2966-555D CHECKED: KW

JOB # 2966-04 SHEET



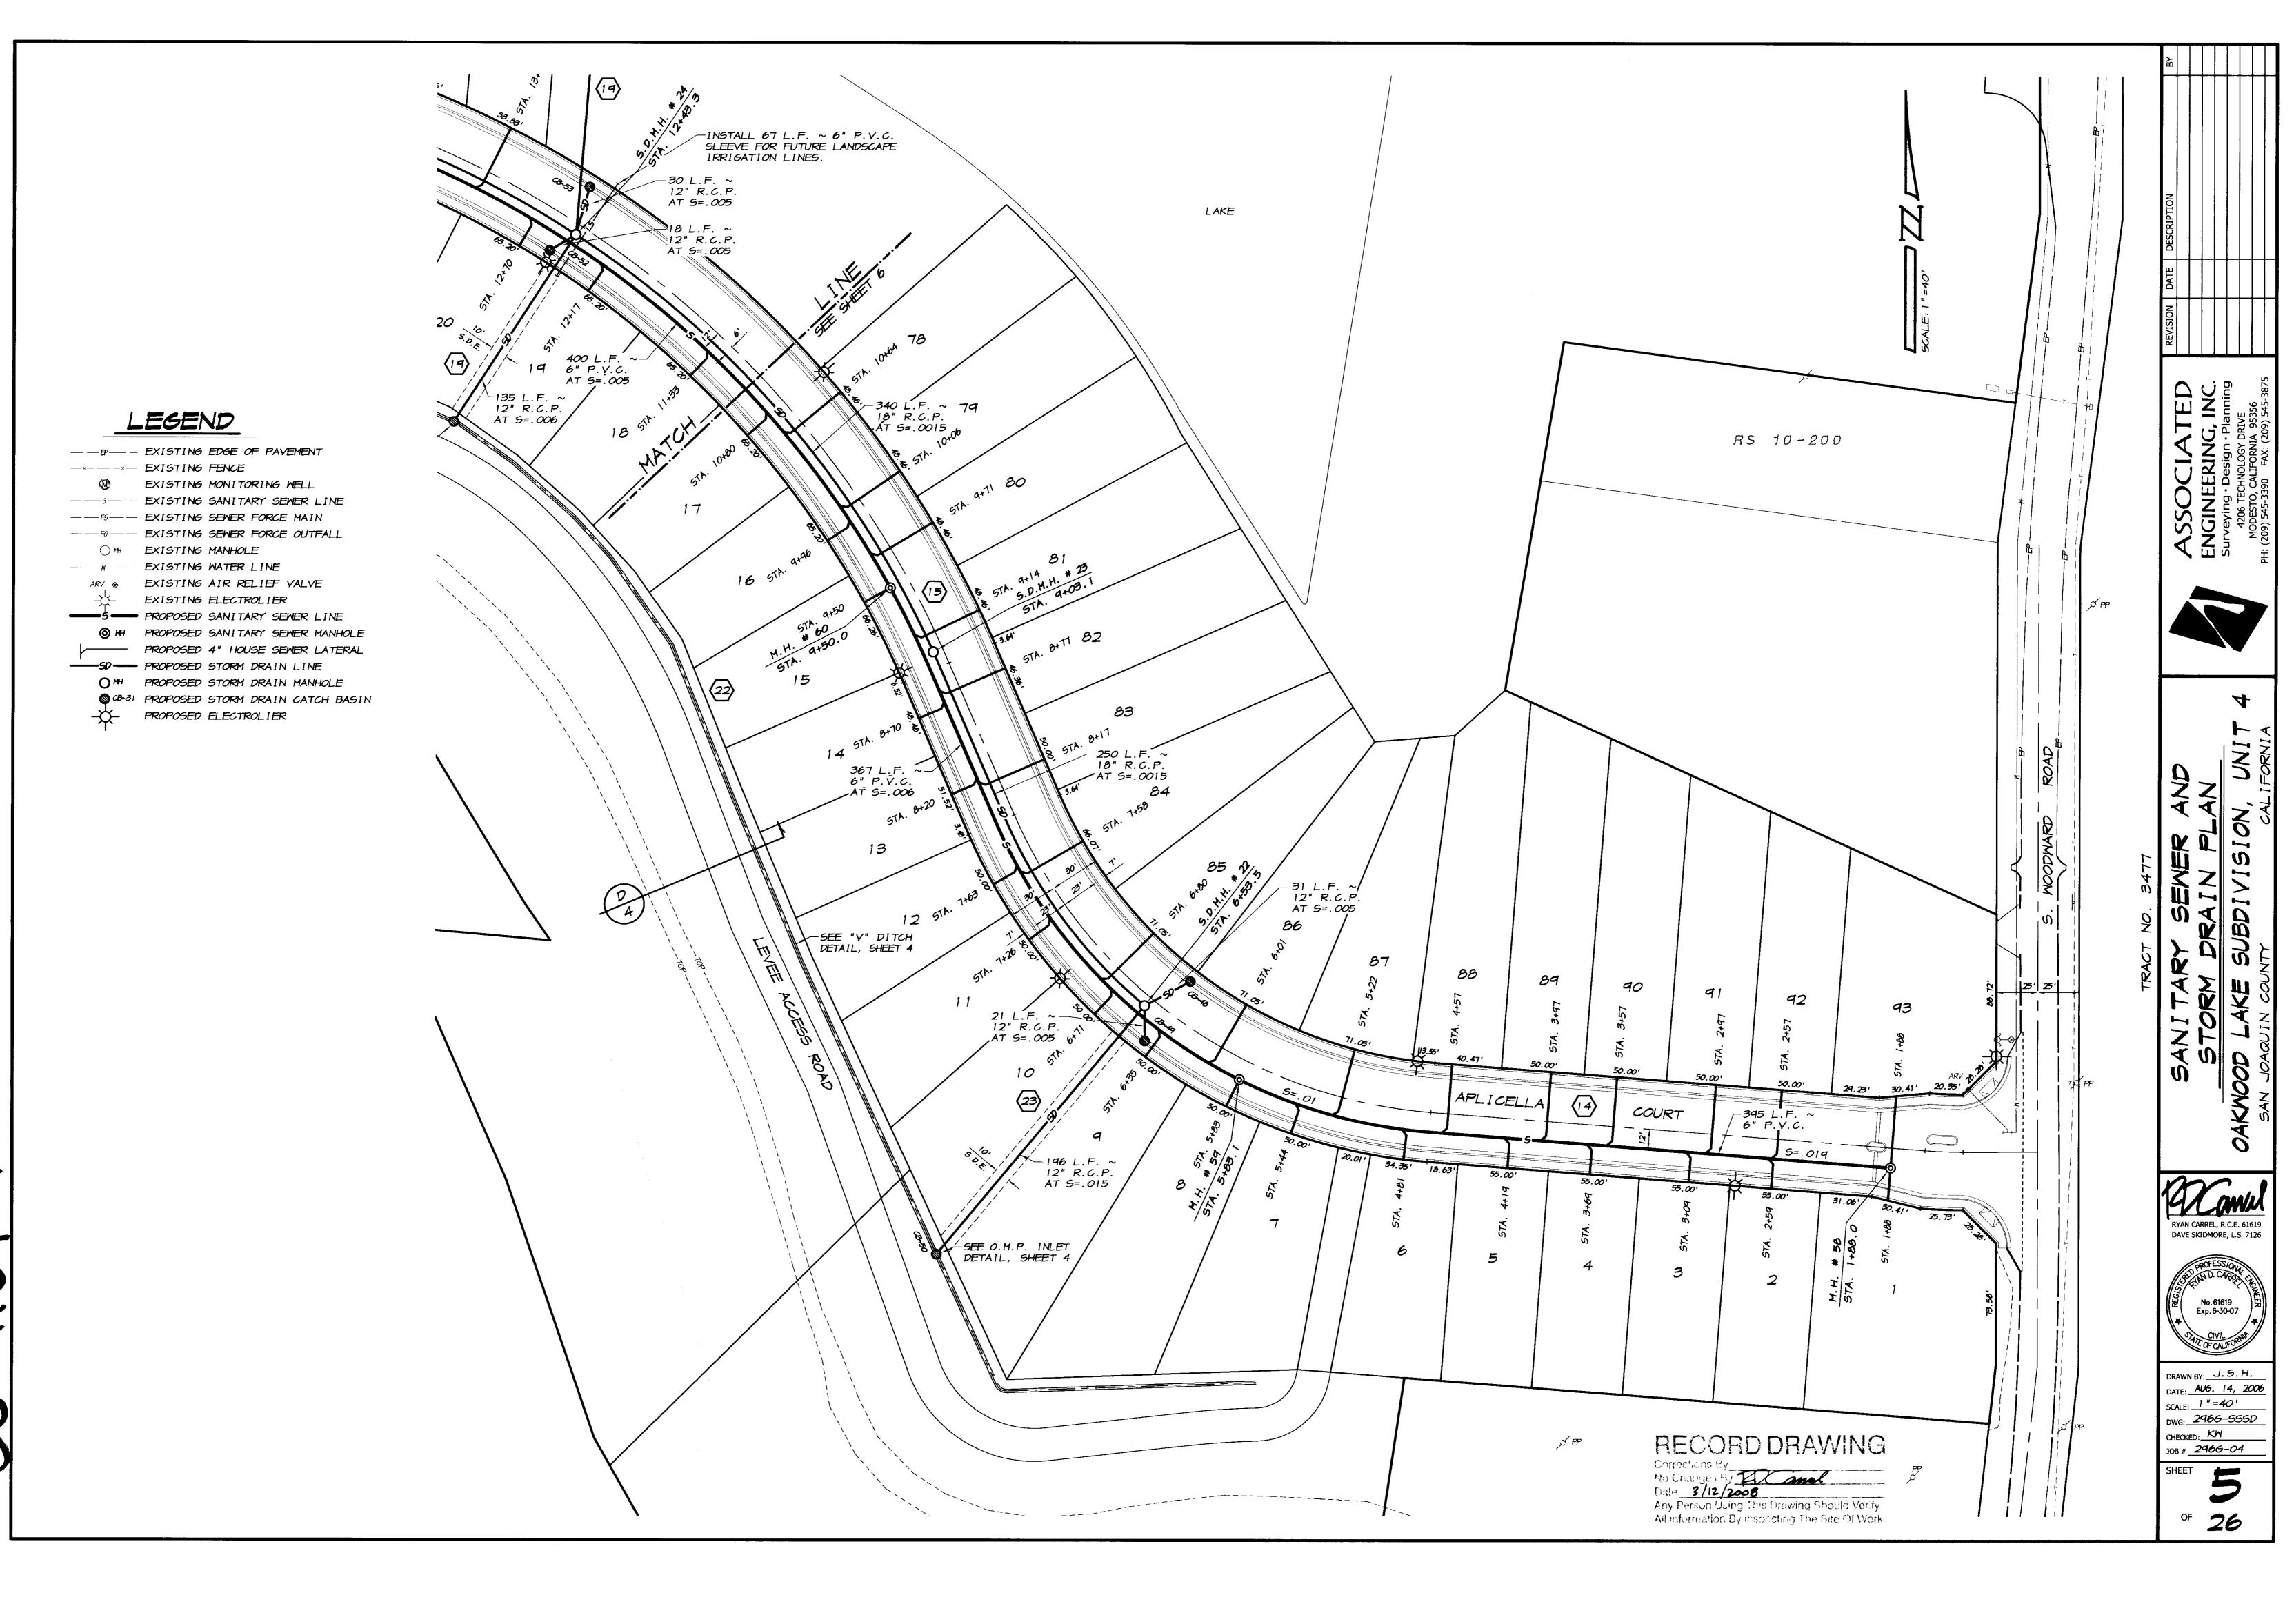


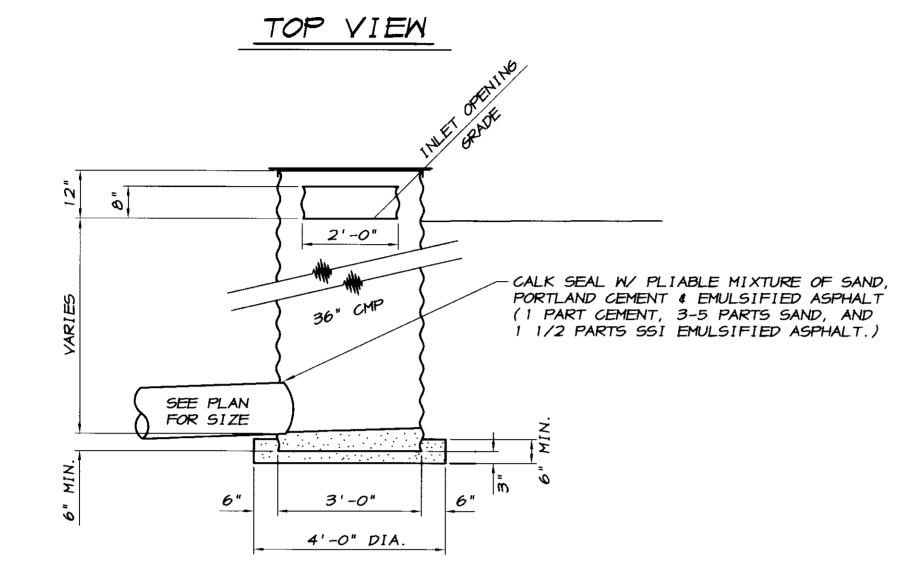

SECTION VIEW

DETAIL AS PER CAL-TRANS STD. PLANS DRING. NO. D75A


O.M.P. INLET DETAIL SCALE: 1"=2"

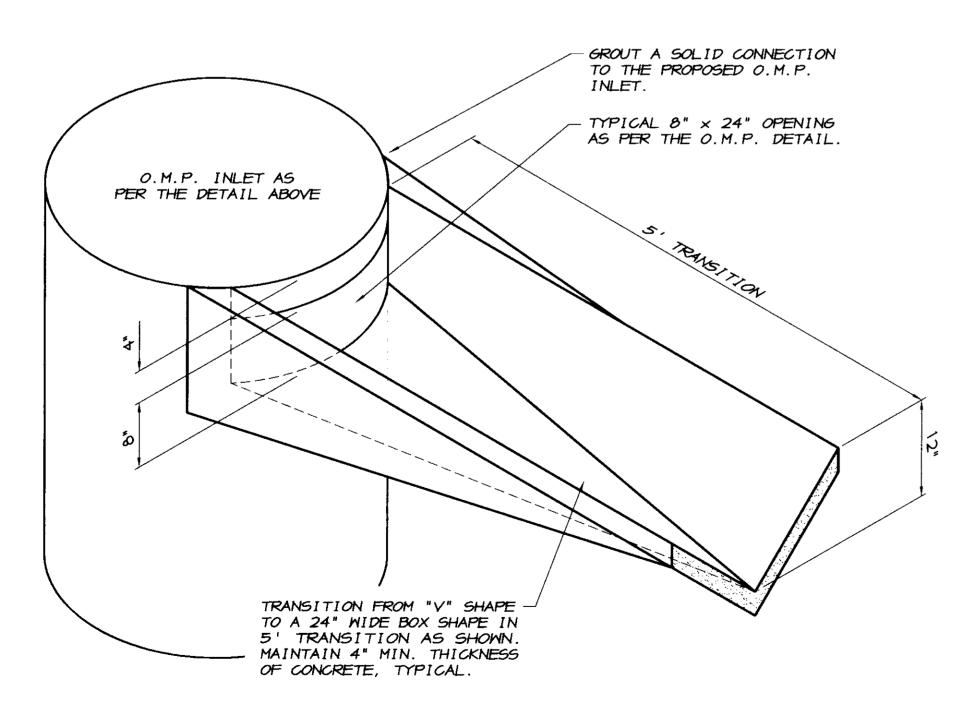

CONCRETE "V" DITCH TRANSITION

INLET DETAIL


NO SCALE

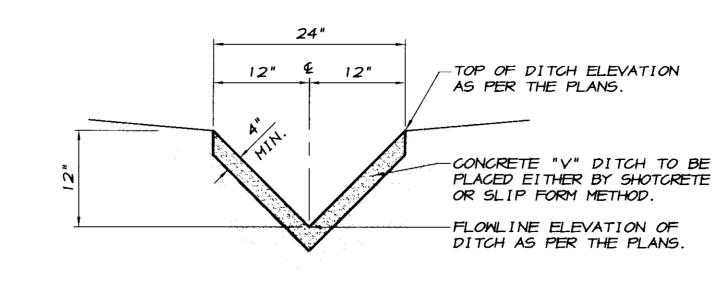

CONCRETE

"Y" DITCH DETAIL

SCALE: 1"=1'

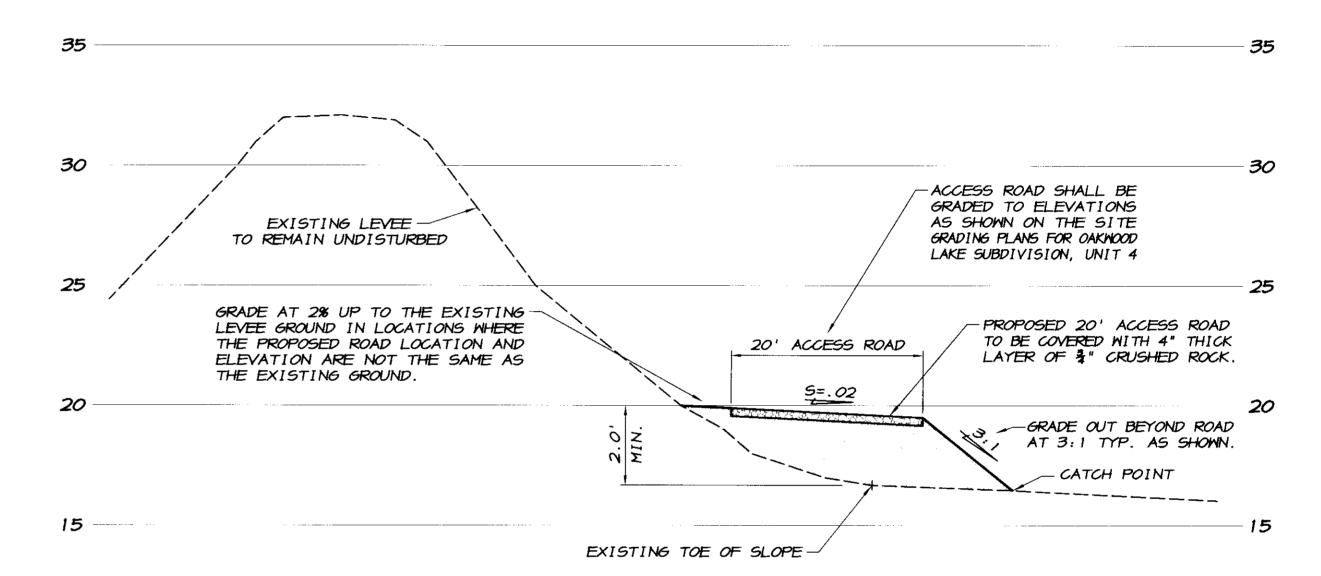

20' LEVEE ACCESS ROAD DETAIL

SECTION "C"

SCALE: HORIZ: 1"=10'

VERTICAL: 1"=4'

*3*5

RECORD DRAWING
Corrections By
No Charges By
Date 3/12/2008
Any Person Using Trus Drawing Church Verify

All information by inspecting The Site Of Work

-CONCRETE "V" DITCH AS PER THE DETAIL ON THIS SHEET, PLACED TO THE GRADES AS

SHOWN ON THE PLANS.

30 30 - ACCESS ROAD SHALL BE GRADED TO ELEVATIONS AS SHOWN ON THE SITE GRADING PLANS FOR OAKMOOD EXISTING LEVEE TO REMAIN UNDISTURBED LAKE SUBDIVISION, UNIT 4 PROPOSED 20' ACCESS ROAD TO BE COVERED WITH 4" THICK LAYER OF %" CRUSHED ROCK. *2*5 *2*5 GRADE AT 2% UP TO THE EXISTING -LEVEE GROUND IN LOCATIONS WHERE 20' ACCESS ROAD THE PROPOSED ROAD LOCATION AND -"V" DITCH LOCATION IS AT 5.0' FROM THE LOT LINE AT LOTS 16, ELEVATION ARE NOT THE SAME AS THE EXISTING GROUND. 17 & 18, AS PER PLAN. S=.02 EXISTING TOE OF SLOPE LOT GRADE 15 GRADE AT A MAXIMUM SLOPE OF 2:1 BETWEEN -THE PROPOSED LEVEE ACCESS ROAD AND THE -GRADE BREAK CONCRETE "V" DITCH AS SHOWN.

20' LEVEE ACCESS ROAD DETAIL

SECTION "D"


SCALE: HORIZ: 1"=10' VERTICAL: 1"=4' EVISION DATE DESCRIPTION

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4206 TECHNOLOGY DRIVE
MODESTO, CALIFORNIA 95356
H; (209) 545-3390 FAX; (209) 545-3875



NS & DETAILS
SUBDIVISION, UNIT 4

OAKNOOD LAKE SUBI

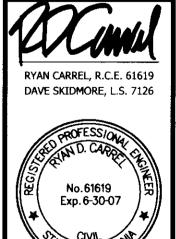

DRAWN BY: J. S. H.

DATE: AUG. 14, 2006

SCALE: 1 "=500'

DWG: 2966-CVR

CHECKED: KW

JOB # 296H-04


SHEET 4

OF 26

PLAN


PROTECTION

TO CAL TRANS SPECIFICATIONS, SECTION 72, FACING CLASS, METHOD B PLACEMENT SLOPE

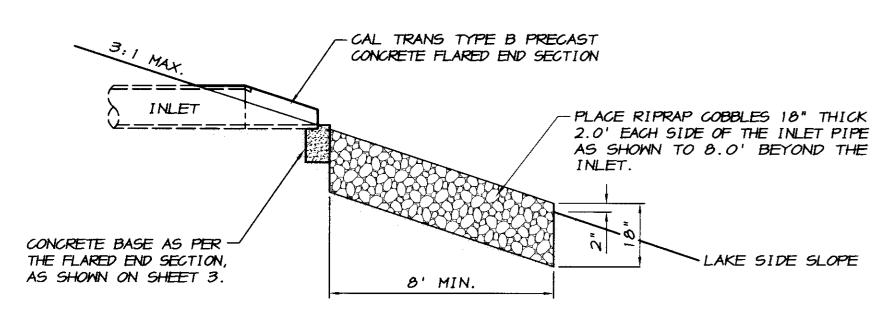

SECTION

LAKE INLET DETAIL SCALE: 1"=2'

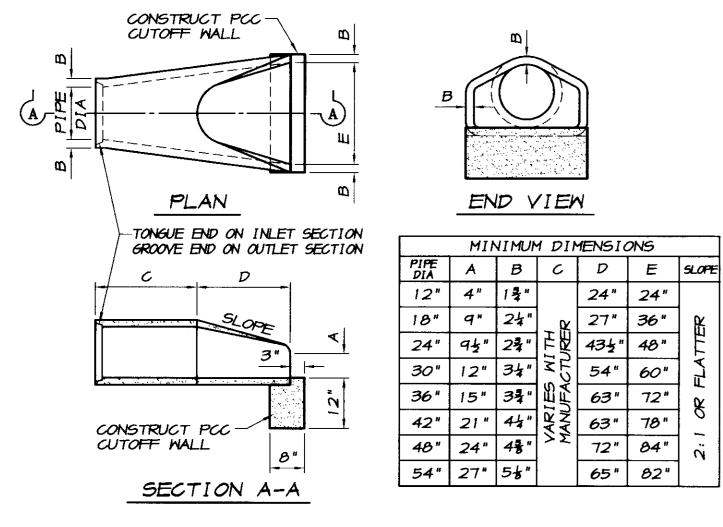


PRECAST CONCRETE

FLARED END SECTION DETAIL

NO SCALE

////////////////FINISH GRADE

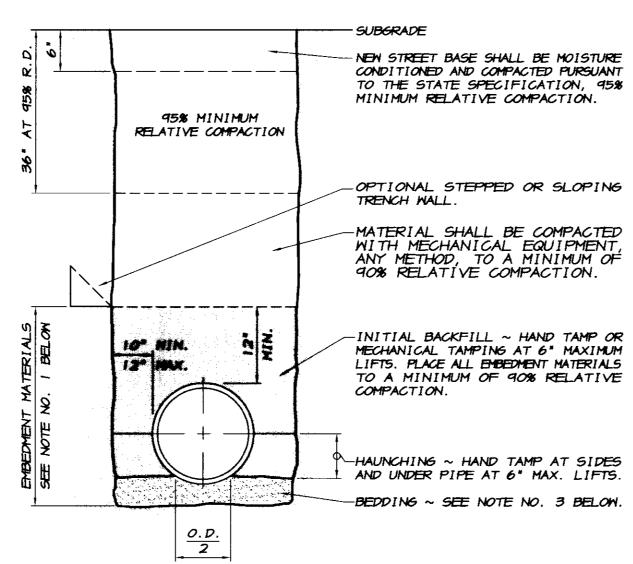

NOTES

- 1. ALL EMBEDMENT MATERIALS SHALL CONFORM TO CLASS I, II OR III SOIL CLASSIFICATIONS AS DESIGNATED IN ASTM D-2321.

 CLASS I: ANGULAR 1/4 TO 11/2" GRADED STONE, INCLUDING A NUMBER OF FILL MATERIALS THAT HAVE REGIONAL SIGNIFICANCE SUCH AS CORAL, SLAG,
- CINDERS, CRUSHED STONE OR CRUSHED SHELLS.

 CLASS II: COARSE SANDS AND GRAVELS WITH MAXIMUM PARTICLE SIZE OF 1½", INCLUDING VARIOUSLY GRADED SANDS AND GRAVELS CONTAINING SMALL PERCENTAGES OF FINES, GENERALLY GRANULAR AND NON-COHESIVE, EITHER WET OR DRY. SOILS TYPES GM, GP, SM AND SP ARE INCLUDED IN THIS CLASS.

 CLASS III: FINE SAND AND CLAY GRAVELS, INCLUDING FINE SANDS, SAND-CLAY MIXTURES, AND GRAVEL-CLAY MIXTURES. SOIL TYPES GM, GC, SM AND SC ARE INCLUDED IN THIS CLASS. CLASS III MATERIALS SHALL NOT BE USED IN EMBEDMENT ZONE OF PIPELINES THAT ARE GREATER THAN 14' OF COVER TO THE PROPOSED FINISH GRADE.
- SELECTED NATIVE MATERIALS CONFORMING TO CLASS I, II, OR III MAY BE USED IN ALL EMBEDMENT ZONES. NATIVE MATERIAL SHALL BE FREE OF ORGANIC MATERIAL, STONES OR LUMPS EXCEEDING 3" IN GREATEST DIMENSION.
- 3. ANY AREA AT THE BOTTOM OF THE TRENCH DETERMINED TO BE UNGUITABLE BY THE GEOTECHNICAL ENGINEER SHALL BE REMOVED AND REPLACED WITH 6" OF CLASS I, II OR III MATERIALS AT 95% MINIMUM RELATIVE COMPACTION. IN A CASE WHERE THE TRENCH BOTTOM IS UNSTABLE, THE BOTTOM AREA SHALL BE REMOVED AND REPLACED WITH CLASS I, II OR III MATERIALS TO A DEPTH DETERMINED BY THE GEOTECHNICAL ENGINEER.
- 4. JETTING WILL NOT BE ALLOWED IN THE EMBEDMENT ZONES, COMPACTION OF EMBEDMENT MATERIALS SHALL CONSIST OF HAND TAMPING AND/OR MECHANICAL TAMPING

P.V.C. SANITARY SEMER
TRENCH SECTION
NO SCALE

UTILITY CONTACTS

SANITARY SEMER ~ OAKMOOD LAKE WATER DISTRICT ATTN.: MIKE GILTON PH. (209) 634-6920

DOMESTIC WATER ~ OAKWOOD LAKE WATER DISTRICT ATTN.: MIKE GILTON PH. (209) 634-6920

STORM DRAINAGE ~ OAKWOOD LAKE WATER DISTRICT ATTN.: MIKE GILTON PH. (209) 634-6920


ELECTRIC ~ PACIFIC GAS AND ELECTRIC COMPANY ATTN.: THOMAS SAMANIEGO PH. (209) 942-1793

GAS ~ PACIFIC GAS AND ELECTRIC COMPANY ATTN.: THOMAS SAMANIEGO PH. (209) 942-1793

TELEPHONE ~ VERIZON COMMUNICATIONS ATTN.: KATHY STROUT PH. (209) 239-0346


CABLE TELEVISION ~ COMCAST ATTN.: MELANIE HERNANDEZ PH. (209) 474-1747 EXT. 238

STREET LIGHTING ~ PACIFIC GAS AND ELECTRIC CO. ATTN.: THOMAS SAMANIEGO PH. (209) 942-1793

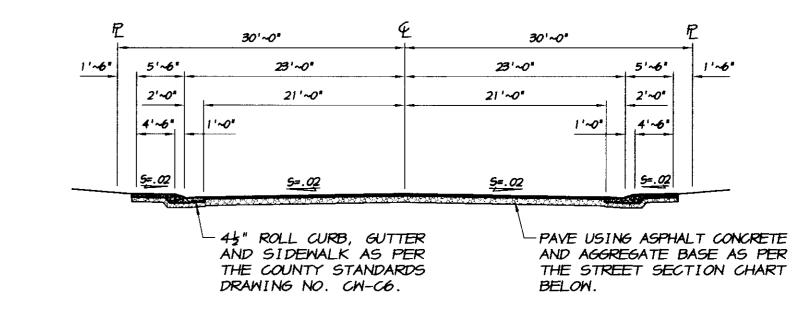

TYPICAL SECTION


APLICELLA COURT SCALE: 1"=10'

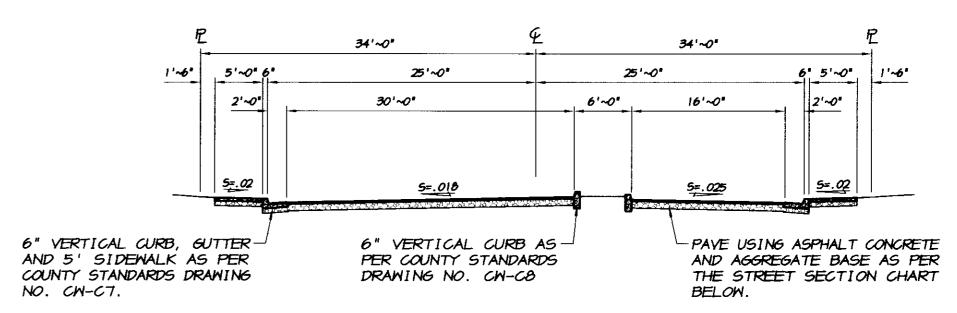

TYPICAL ENTRYWAY


APLICELLA COURT


SCALE: 1"=10'

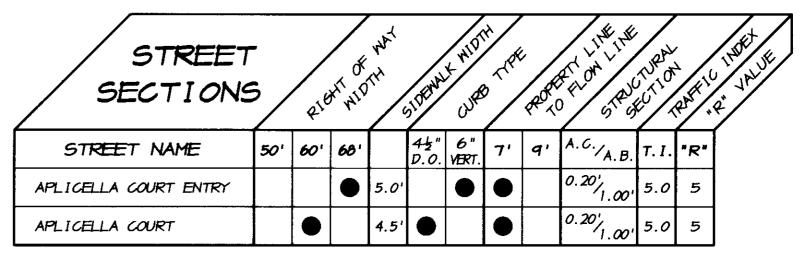

R-VALUE NOTE

R-VALUE TESTING SHALL BE PERFORMED ON SUBGRADE AFTER THE ROUGH GRADING HAS BEEN COMPLETED, TO VERIFY THE EXACT R-VALUES TO BE USED FOR THE FINAL ASPHALTIC PAVEMENT DESIGNS. THE CONTRACTOR SHALL WORK CLOSELY WITH THE SOILS ENGINEER TO DETERMINE THE EXTENTS OF THE GRADING WORK REQUIRED IN AREAS DEEMED UNACCEPTABLE BY THE SOILS ENGINEER. ALL FINAL DESIGNS AND SOLUTIONS SHALL BE APPROVED BY SAN JOAQUIN COUNTY PRIOR TO PLACING THE AGGREGATE BASE ROCK.

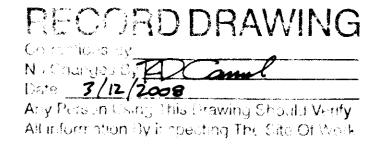

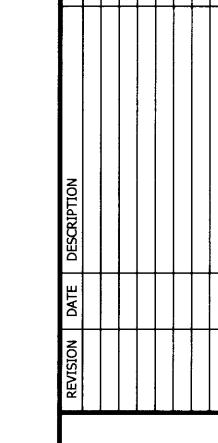

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DATE: AU6. 14, 2006
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JOB # 296H-04
SHEET

26

- 2. BENCHMARK: CITY OF MANTECA BENCHMARK NO. 71, 2" BRASS CAP LOCATED APPROXIMATELY 25 FEET NORTH OF THE NORTHEAST CORNER OF SECTION 11, TOWNSHIP 2 SOUTH, RANGE 6 EAST, MOUNT DIABLO MERIDIAN, AT THE INTERSECTION OF MCKINLEY AVENUE AND BRONZAN ROAD. ELEVATION = 16.703, U.S.6.S. DATUM.
- 3. SOILS REPORT: THE GEOTECHNICAL SERVICES REPORT FOR THE PROPOSED OAKWOOD LAKE DEVELOPMENT, WOODWARD AVENUE, MANTECA, CALIFORNIA, AS PREPARED BY KLEINFELDER, INC., WITH PROJECT NO. 48093.601, DATED OCTOBER 27, 2004, IS HEREBY MADE A PART OF THESE PLANS.
- 4. THESE PLANS HAVE BEEN CHECKED BY THE COUNTY OF SAN JOAQU'IN AND/OR ITS AUTHORIZED REPRESENTATIVE, BUT SUCH CHECKING AND/OR APPROVAL DOES NOT RELIEVE THE DEVELOPER FROM HIS RESPONSIBILITY TO CORRECT ERRORS, OMISSIONS OR MAKE CHANGES REQUIRED BY CONDITIONS DISCOVERED IN THE FIELD DURING THE COURSE OF CONSTRUCTION.
- 5. IF A CONFLICT OCCURS BETWEEN THE SAN JOAQUIN COUNTY DESIGN AND CONSTRUCTION STANDARDS AND THE RECOMMENDATIONS BY THE DESIGN ENGINEER AND/OR SOILS ENGINEER, THE MORE STRINGENT SHALL APPLY AS DIRECTED BY THE DIRECTOR OF PUBLIC WORKS.
- 6. GUARANTEE: THE COMPLETED PROJECT, INCLUDING ALL WORK, MATERIALS, DEVICES AND EQUIPMENT, SHALL BE GUARANTEED BY THE DEVELOPER AGAINST FAULTY WORKMANSHIP AND MATERIALS FOR A PERIOD OF ONE YEAR AFTER FINAL ACCEPTANCE BY THE DIRECTOR OF PUBLIC WORKS. THE DEVELOPER SHALL BE RESPONSIBLE FOR ALL REPAIR AND/OR REPLACEMENTS INCLUDING ALL LABOR, MATERIALS, EQUIPMENT, DEVICES, PLANT AND OTHER ITEMS OF WORK NECESSARY. TO SECURE THIS GUARANTEE, A BOND OR OTHER SECURITY SHALL BE PROVIDED IN THE AMOUNT OF 20% OF THE VALUE OF THE WORK ESTIMATED BY THE ENGINEER. SAID BOND SHALL CONTINUE IN FULL FORCE AND EFFECT FOR A PERIOD OF ONE YEAR FROM THE DATE OF THE FORMAL ACCEPTANCE OF THE WORK BY THE DIRECTOR OF PUBLIC WORKS OR BOARD OF SUPERVISORS.
- 7. INSPECTION DURING CONSTRUCTION: ANY IMPROVEMENTS CONSTRUCTED TO THESE SPECIFICATIONS AND WHICH IT IS INTENDED THAT THE COUNTY OR A HOMEOWNERS ASSOCIATION WILL ASSUME MAINTENANCE RESPONSIBILITY, MUST BE INSPECTED DURING CONSTRUCTION BY AN AUTHORIZED AGENT OF THE DEVELOPER AND DIRECTOR OF PUBLIC WORKS. EACH PHASE OF CONSTRUCTION MUST BE INSPECTED AND APPROVED PRIOR TO PROCEEDING TO THE SUBSEQUENT PHASES.

ANY IMPROVEMENTS CONSTRUCTED WITHOUT INSPECTION AS PROVIDED ABOVE OR CONSTRUCTED CONTRARY TO THE ORDERS OR INSTRUCTIONS OF THE AUTHORIZED AGENT OF THE DEVELOPER OR DIRECTOR WILL BE DEEMED AS NOT COMPLYING WITH THE SAN JOAQUIN COUNTY STANDARDS AND SPECIFICATIONS, AND WILL NOT BE ACCEPTED BY SAN JOAQUIN COUNTY FOR MAINTENANCE PURPOSES.

THE DEVELOPER WILL HAVE COMPACTION TESTS TAKEN ON ALL LOTS WHERE THE DEPTH OF FILL IS GREATER THAN SEVEN (7") INCHES AND WITHIN THE STREETS. RE-TESTS THAT ARE THE RESULT OF THE CONTRACTOR'S FAILURE TO COMPACT THESE AREAS AS REQUIRED WILL BE BORNE BY THE CONTRACTOR.

THE COUNTY DEPARTMENT OF PUBLIC WORKS WILL PERFORM FIELD INSPECTIONS FOR THIS PROJECT. THE OAKWOOD LAKE WATER DISTRICT WILL PERFORM FIELD INSPECTIONS FOR THE INSTALLATION OF THE SANITARY SEMER, DOMESTIC WATER AND STORM DRAIN SYSTEMS FOR THIS PROJECT.

THE CIVIL ENGINEER, DIRECTOR AND DEVELOPER, OR THEIR AGENTS, SHALL AT ALL TIMES, HAVE ACCESS TO THE WORK DURING ITS CONSTRUCTION, AND SHALL BE FURNISHED WITH EVERY REASONABLE FACILITY FOR ASCERTAINING THAT THE MATERIALS AND THE WORKMANSHIP ARE IN ACCORDANCE WITH THE REQUIREMENTS AND INTENTIONS OF THESE SPECIFICATIONS, SPECIAL PROVISIONS, AND PLANS. ALL WORK DONE AND ALL MATERIALS FURNISHED SHALL BE SUBJECT TO REVIEW. THE REVIEW OF THE WORK OR MATERIALS SHALL NOT RELIEVE THE CONTRACTOR AND DEVELOPER OF ANY OF THEIR OBLIGATIONS TO FULFILL THEIR CONTRACT AS PRESCRIBED.

B. FINAL REVIEW: UPON COMPLETION OF ANY IMPROVEMENTS WHICH ARE CONSTRUCTED UNDER AND IN CONFORMANCE WITH THE STANDARD SPECIFICATIONS, AND PRIOR TO REQUESTING FINAL INSPECTION, THE AREA SHALL BE THOROUGHLY CLEANED OF ALL RUBBISH, EXCESS MATERIAL AND EQUIPMENT, AND ALL PORTIONS OF THE WORK SHALL BE LEFT IN A NEAT AND ORDERLY CONDITION, SATISFACTORY TO THE DIRECTOR AND THE DEVELOPER.

WITHIN TEN (10) DAYS AFTER RECEIVING THE REQUEST FOR FINAL INSPECTION, THE DIRECTOR SHALL INSPECT THE WORK. THE DEVELOPER, OR HIS AUTHORIZED REPRESENTATIVE, WILL BE NOTIFIED IN WRITING AS TO ANY PARTICULAR DEFECTS OR DEFICIENCIES TO BE REMEDIED. THE CONTRACTOR SHALL PROCEED TO CORRECT ANY SUCH DEFECTS OR DEFICIENCIES AT THE EARLIEST POSSIBLE DATE. AT SUCH TIME, AS THE WORK HAS BEEN COMPLETED, A SECOND INSPECTION SHALL BE MADE BY THE DIRECTOR TO DETERMINE IF THE PREVIOUSLY MENTIONED DEFECTS HAVE BEEN REPAIRED, ALTERED AND COMPLETED IN ACCORDANCE WITH THESE STANDARDS AND SPECIFICATIONS.

WHEN THE WORK HAS BEEN COMPLETED IN ACCORDANCE WITH THE APPROVED PLANS AND SPECIFICATIONS, THE DIRECTOR WILL RECOMMEND ACCEPTANCE OF THE WORK TO THE BOARD OF SUPERVISORS. THE DIRECTOR WILL NOTIFY, IN WRITING, THE DEVELOPER, OR HIS AUTHORIZED REPRESENTATIVE, AS TO THE DATE OF APPROVAL AND FINAL ACCEPTANCE.

- 9. CHANGES ON PLANS AND SPECIFICATIONS: ANY CHANGES TO THE APPROVED IMPROVEMENT PLANS AND SPECIFICATIONS MUST BE PREPARED AND CERTIFIED BY THE CIVIL ENGINEER, AND SHALL BE SUBMITTED TO THE DIRECTOR FOR APPROVAL PRIOR TO IMPLEMENTATION.
- 10. THE CONTRACTOR SHALL KEEP HIMSELF FULLY INFORMED OF ALL EXISTING AND FUTURE STATE AND FEDERAL LANG AND ALL COUNTY, MUNICIPAL AND SPECIAL DISTRICT ORDINANCES AND REGULATIONS WHICH IN ANY MANNER AFFECT THOSE ENGAGED OR EMPLOYED IN THE WORK, OR THE MATERIALS USED IN THE WORK, OR WHICH IN ANY WAY AFFECT THE CONDUCT OF THE WORK, AND OF ALL SUCH ORDERS AND DECREES OF BODIES OR TRIBUNALS HAVING ANY JURISDICTION OR AUTHORITY OVER THE SAME. THE CONTRACTOR SHALL AT ALL TIMES OBSERVE AND COMPLY WITH, AND SHALL CAUSE ALL HIS AGENTS AND EMPLOYEES TO OBSERVE AND COMPLY WITH ALL SUCH EXISTING AND FUTURE LANS, ORDINANCES, REGULATIONS, ORDERS AND DECREES OF BODIES OR TRIBUNALS HAVING ANY JURISDICTION OR AUTHORITY OVER THE WORK; AND SHALL PROTECT AND INDEMNIFY SAN JOAQU'IN COUNTY AND THE OWNER, AND ALL OFFICERS AND EMPLOYEES THEREOF CONNECTED WITH THE WORK, INCLUDING THE ENGINEER, AGAINST ANY CLAIM OR LIABILITY ARISING FROM OR BASED ON THE VIOLATION OF ANY SUCH LAW, ORDINANCE, REGULATION, ORDER, OR DECREE, WHETHER BY HIMSELF OR HIS EMPLOYEES. IF ANY DISCREPANCY OR INCONSISTENCY IS DISCOVERED IN THE PLANS, SPECIFICATIONS, OR CONTRACT FOR THE WORK IN RELATION TO ANY SUCH LAW, ORDINANCE, REGULATION, ORDER, OR DECREE THE CONTRACTOR SHALL FORTHWITH REPORT THE SAME TO THE ENGINEER IN WRITING.
- 11. THE ENGINEER ASSUMES NO RESPONSIBILITY FOR ANY WORK PERFORMED BY THE CONTRACTOR OR OWNER BASED ON PLANS WHICH HAVE NOT BEEN SIGNED AND SEALED BY THE ENGINEER AND APPROVED BY THE CITY OR COUNTY HAVING JURISDICTION. ALL INFORMATION SHOWN ON PRELIMINARY DRAWINGS IS SUBJECT TO CORRECTION AND CHANGE, AND THE CONTRACTOR OR OWNER SHALL PERFORM ANY AND ALL WORK AT THEIR OWN RISK.
- 12. ALL DISTANCES AND MEASUREMENTS ARE GIVEN AND WILL BE MADE IN A HORIZONTAL PLANE. GRADE WILL BE GIVEN FROM THE TOP OF NAILS OR STAKES, UNLESS NOTED OTHERNISE, THE CONTRACTOR SHALL PRESERVE ALL POINTS AND STAKES SET FOR LINES AND GRADES OR MEASUREMENTS OF THE WORK. IN THEIR PROPER LOCATION UNTIL AUTHORIZED TO REMOVE THEM BY THE ENGINEER. ALL EXPENSES INCURRED IN REPLACING STAKES THAT HAVE BEEN REMOVED WITHOUT PROPER AUTHORITY SHALL BE PAID FOR BY THE GENERAL CONTRACTOR.
- 13. THESE PLANS HAVE BEEN PREPARED WITH THE INTENT THAT ASSOCIATED ENGINEERING GROUP, INC. WILL PERFORM THE CONSTRUCTION STAKING FOR THE COMPLETE PROJECT. THE CONTRACTOR SHALL PROVIDE ASSOCIATED ENGINEERING GROUP, INC. WITH FORTY-EIGHT HOURS ADVANCE NOTICE OF STAKING NEEDS. ANY STAKING REQUESTED BY THE CONTRACTOR OR THEIR SUBCONTRACTORS THAT IS ABOVE AND BEYOND THE AGREED UPON STAKING REQUEST SHALL BE SUBJECT TO AN EXTRA BACK CHARGE TO THE CONTRACTOR / CLIENT. IF ANOTHER FIRM OR AGENCY IS EMPLOYED TO USE THESE PLANS FOR THE PURPOSE OF CONSTRUCTION STAKING, NOTICE IS HEREBY GIVEN THAT ASSOCIATED ENGINEERING GROUP, INC. WILL NOT ASSUME ANY RESPONSIBILITY FOR ERRORS OR OMISSIONS, IF ANY, WHICH MIGHT OCCUR AND WHICH COULD HAVE BEEN AVOIDED, CORRECTED OR MITIGATED IF ASSOCIATED ENGINEERING GROUP, INC. HAD PERFORMED THE STAKING WORK.
- 14. WHERE THE PLANS OR SPECIFICATIONS DESCRIBE PORTIONS OF THE WORK IN GENERAL TERMS, BUT NOT IN COMPLETE DETAIL, IT IS UNDERSTOOD THAT ONLY THE BEST GENERAL PRACTICE IS TO PREVAIL AND THAT ONLY MATERIALS AND WORKMANSHIP OF THE FINEST QUALITY ARE TO BE USED.
- 15. THE CONTRACTOR SHALL COMPLY WITH THE REQUIREMENTS OF THE STATE OF CALIFORNIA WATER RESOURCES CONTROL BOARD (SMRCB), ORDER NO. 92-06-DMQ, NPDES GENERAL PERMIT NO. CASODODO2. THE CONTRACTOR SHALL IMPLEMENT AND MONITOR THE STORM WATER POLLUTION PREVENTION PLAN (SWPPP) IN ACCORDANCE WITH THE SWRCB REGULATIONS.
- 16. THE CONTRACTOR SHALL COMPLY WITH ALL LOCAL, STATE, AND FEDERAL SAFETY REGULATIONS PERTAINING TO HIS OPERATIONS. HE SHALL PROVIDE ALL LIGHTS, SIGNS, BARRICADES, FLAG MEN OR OTHER DEVICES NECESSARY FOR PUBLIC SAFETY. THE CONTRACTOR'S ATTENTION IS CALLED TO THE REQUIREMENTS OF TITLE 8 OF THE CALIFORNIA ADMINISTRATIVE CODE, SUBCHAPTER 4, ARTICLE 6, "EXCAVATIONS, TRENCHES, EARTHWORK."
- 17. INDEMNITY CLAUSE: CONTRACTOR AGREES TO ASSUME SOLE AND COMPLETE RESPONSIBILITY FOR JOBSITE CONDITIONS DURING THE COURSE OF CONSTRUCTION OF THIS PROJECT, INCLUDING SAFETY OF ALL PERSONS AND PROPERTY: THIS REQUIREMENT SHALL APPLY CONTINUOUSLY AND NOT BE LIMITED TO NORMAL WORKING HOURS; AND THAT THE CONTRACTOR SHALL DEFEND, INDEMNIFY AND HOLD HARMLESS, THE COUNTY OF SAN JOAQUIN, ITS ELECTED OFFICIALS, OFFICERS, EMPLOYEES. AND AGENTS FROM ANY AND ALL CLAIMS, COSTS OF LITIGATION, DAMAGES, AND ATTORNEY'S FEES, FOR PERSONAL INJURY OR PROPERTY DAMAGE OF WHATEVER NATURE WHICH ARE CLAIMED TO HAVE OCCURRED DURING THE TERM OF THIS PROJECT,
- 18. APPROPRIATE DUST CONTROL SHALL BE PROVIDED FOR THE ALLEVIATION OR PREVENTION OF DUST NUISANCE AS REQUIRED BY THE COUNTY OF SAN JOAQUIN, AT THE CONTRACTOR'S EXPENSE. THE CONTRACTOR SHALL IMPLEMENT A DUST CONTROL PROGRAM AS PART OF THE MEASURES REQUIRED BY THE E.I.R. (CHAPTER 4.6) FOR AIR QUALITY CONTROL AND THE REQUIREMENTS OF PM 10 AND THE BEST AVAILABLE CONTROL MEASURES (BACM) APPROVED BY THE BOARD. THE PROGRAM SHALL INSURE THAT, AT THE PUBLIC WORKS DIRECTOR'S DISCRETION, A WATER VEHICLE FOR DUST CONTROL OPERATIONS IS KEPT READILY AVAILABLE AT ALL TIMES DURING CONSTRUCTION. THE CONTRACTOR SHALL PROVIDE THE PUBLIC WORKS DIRECTOR AND BUILDING OFFICIAL WITH THE NAME AND TELEPHONE NUMBER OF THE PERSON DIRECTLY RESPONSIBLE FOR DUST CONTROL AND OPERATION OF THE WATER VEHICLE.
- 19. THE EXISTING UTILITIES ARE PLOTTED FROM AVAILABLE RECORDS OR FIELD LOCATIONS WHEN POSSIBLE. THE CONTRACTOR SHALL LOCATE AND PRESERVE ALL EXISTING FACILITIES INCLUDING GAS, WATER, IRRIGATION, POWER, TELEPHONE, SENER OR OTHERS WHICH MAY BE PRESENT IN THE AREA OF CONSTRUCTION. THE RESPECTIVE UTILITY COMPANIES SHALL BE NOTIFIED PRIOR TO BEGINNING WORK.
- 20. THE EXISTING UTILITIES SHALL NOT BE INTERRUPTED UNTIL THE UTILITY COMPANY HAS PROVIDED ALTERNATIVE SERVICE FACILITIES. THE CONTRACTOR SHALL COOPERATE AND COORDINATE HIS WORK WITH THE APPROPRIATE AGENCIES AND UTILITY COMPANIES.

- 21. ALL CONSTRUCTION STAKING FOR GRADING, CURBS AND GUTTERS, SIDEWALKS, SANITARY SEMERS, STORM DRAINS, WATER LINES, FIRE HYDRANTS, ELECTROLIERS, ETC. SHALL BE DONE BY A REGISTERED CIVIL ENGINEER OR LICENSED LAND
- 22. PRIOR TO TRENCHING FOR ANY SEMER, WATER OR STORM DRAIN PIPE, THE CONTRACTOR SHALL VERIFY, IN THE FIELD, THE SIZE AND LOCATION OF THE EXISTING PIPE AT THE POINT OF CONNECTION. ANY DEVIATION FROM THE PLANS SHALL BE RESOLVED BY THE DESIGN ENGINEER PRIOR TO TRENCHING. ANY DAMAGE CAUSED BY TRENCHING TO EXISTING UNDERGROUND UTILITIES SHALL BE THE SOLE RESPONSIBILITY OF THE CONTRACTOR.
- 23. ALL TRENCHES SHALL BE BACKFILLED IN ACCORDANCE WITH SAN JOAQUIN COUNTY STANDARD DETAILS, COMPACTION SHALL BE ACHIEVED BY MECHANICAL MEANS. NO FLOODING, PONDING, OR JETTING SHALL BE PERMITTED UNLESS APPROVED BY THE DIRECTOR OF PUBLIC WORKS IN WRITING.
- A. ALL INDEPENDENT LABORATORY INSPECTIONS CALLED FOR BY THE DIRECTOR OF PUBLIC WORKS WILL BE PAID FOR BY THE
- B. ROADWAY SUB-GRADE, SUB-BASE, BASE, AND TRENCH BACKFILL COMPACTION TESTING SHALL BE PERFORMED BY A LICENSED SOILS ENGINEER, AT THE DEVELOPERS EXPENSE.
- C. TESTS FOR R-VALUES ARE REQUIRED PRIOR TO THE INSTALLATION OF BASE ROCK.

D. A MINIMUM OF 40 HOURS NOTICE IS REQUIRED TO SCHEDULE ALL SOILS TESTING SERVICES.

26. THE FULL STRUCTURAL SECTION OF THE MAJOR STREET SHALL BE CONTINUED THROUGH THE INTERSECTIONS.

- 25. ASBESTOS CEMENT PIPE (ACP) OR VITRIFIED CLAY PIPE (VCP) OR ITS FITTINGS SHALL NOT BE USED WITHIN SAN JOAQUIN
- TRAFFIC CONTROL DEVICES AND INSTALLATIONS SHALL BE IN CONFORMANCE WITH M.U.T.C.D., SECTION IV BY THE U.S. DEPARTMENT OF TRANSPORTATION AND THE CALIFORNIA SUPPLEMENT TO THE M.U.T.C.D., AND MUST MEET THE COUNTY STANDARDS.
- 28. IF, DURING CONSTRUCTION, ARCHAEOLOGICAL REMAINS ARE ENCOUNTERED, CONSTRUCTION IN THE VICINITY SHALL BE HALTED, AND AN ARCHAEOLOGIST CONSULTED, AND THE COUNTY PUBLIC WORKS DEPARTMENT NOTIFIED. IF, IN THE OPINION OF THE ARCHAEOLOGIST, THE REMAINS ARE SIGNIFICANT, MEASURES AS MAY BE REQUIRED BY THE DIRECTOR OF PUBLIC WORKS, SHALL BE TAKEN TO PROTECT THEM.
- 29. DISPOSAL OF WATER INTO THE SANITARY SEMER SYSTEM IS STRICTLY PROHIBITED.
- 30. THE CONTRACTOR SHALL MAINTAIN ALL STREETS, SIDEWALKS, AND ALL OTHER PUBLIC RIGHTS-OF-WAY IN A CLEAN, SAFE AND USABLE CONDITION THROUGHOUT THE COURSE OF CONSTRUCTION. ALL SPILLS OF SOIL, ROCK, CONSTRUCTION DEBRIS, ETC. SHALL BE REMOVED IMMEDIATELY FROM PUBLICLY OWNED PROPERTY. ALL ADJACENT PROPERTY, PRIVATE OR PUBLIC, SHALL BE MAINTAINED IN A CLEAN, SAFE AND USABLE CONDITION. THE CONTRACTOR SHALL PROVIDE FOR SAFE, UNOBSTRUCTED ACCESS TO PRIVATE PROPERTY ADJACENT TO WORK THROUGHOUT THE PERIOD OF CONSTRUCTION. THE CONTRACTOR SHALL PROVIDE THE PUBLIC MORKS DEPARTMENT THE NAME AND TELEPHONE NUMBER OF PERSON AVAILABLE 24 HOURS A DAY IF PROBLEMS OR CONDITION IS NOT MET.
- 31. ALL TRASH, CONSTRUCTION DEBRIS AND MATERIALS SHALL BE CONTAINED WITHIN THE CONSTRUCTION AREA UNTIL OFF-SITE DISPOSAL CAN BE ARRANGED.
- 32. THE CONTRACTOR SHALL KEEP ADJOINING PUBLIC STREETS AND PARKING AREAS FREE AND CLEAN OF PROJECT DIRT, MUD AND MATERIALS DURING THE CONSTRUCTION PERIOD. THE CONTRACTOR SHALL BE RESPONSIBLE FOR CORRECTIVE MEASURES AS DIRECTED BY THE PUBLIC WORKS INSPECTOR AT NO EXPENSE TO THE COUNTY.
- 33. THE APPLICANT SHALL ALERT CONSTRUCTION PERSONNEL OF THE POSSIBILITY OF BURIED CULTURAL RESOURCES, HUMAN REMAINS AND OTHER SUCH CULTURAL RESOURCES AND SHALL IMMEDIATELY COMPLY WITH ALL REQUIREMENTS CONTAINED IN THE EIR, INCLUDING THE STOPPAGE OF ALL WORK, NOTIFICATION OF THE NATIVE AMERICAN HERITAGE COMMISSION AND THE SAN JOAQUIN COUNTY CORONER, AS APPLICABLE.
- 34. WHEN WIDENING THE PAVEMENT ON AN EXISTING ROAD, THE EXISTING PAVEMENT SHALL BE SANCUT TO A NEAT LINE AND REMOVED BACK TO AN EXISTING SOUND STRUCTURAL SECTION AS DETERMINED BY THE CITY INSPECTOR. AN EXPLORATORY TRENCH, OR POTHOLING, MAY BE REQUIRED TO DETERMINE THE LIMITS OF PAVEMENT REMOVAL. THE CONTRACTOR SHALL OBTAIN AN ENCROACHMENT PERMIT FROM THE CITY OF MANTECA PRIOR TO BEGINNING ANY WORK ON WOODWARD AVENUE.
- 35. STREET STRIPING SHALL INCLUDE STOP BARS, LEGENDS, CENTERLINE STRIPING REFLECTIVE PAVEMENT MARKERS, CROSSWALKS AND ALL OTHER MARKINGS REQUIRED BY THE DIRECTOR OF PUBLIC WORKS. ALL STRIPING SHALL BE DONE WITH THERMOPLASTIC AND REFLECTIVE MARKERS. ALL STRIPING SHALL BE CAT-TRACKED PRIOR TO FINAL INSTALLATION. FINAL INSTALLATION WILL BE ALLONED ONLY AFTER APPROVAL OF THE STRIPING LAYOUT BY THE PUBLIC WORKS CONSTRUCTION INSPECTOR.
- 36. FINAL PAVEMENT WORK SHALL NOT OCCUR WITHIN THE ROAD RIGHT-OF-WAY PRIOR TO THE COMPLETION OF UTILITY RELOCATIONS WITHOUT THE SPECIFIC APPROVAL OF THE DIRECTOR OF PUBLIC WORKS.
- 31. THE THICKNESS OF SUBBASE, BASE, AND SURFACING SHALL BE AS APPROVED ON THE IMPROVEMENT PLANS. SEE THE STREET SECTIONS CHART.
- 38. FOG SEAL AT ASPHALT CONCRETE. THE TYPE OF FOG SEAL USED SHALL BE PER SECTION 37 OF CALTRANS STANDARD SPECIFICATIONS LATEST EDITION AND AS APPROVED BY SAN JOAQUIN COUNTY PRIOR TO USE
- 39. THERE SHALL BE A 2% CROSS SLOPE ON THE CONSTRUCTION OF ALL NEW STREETS.
- 40. ALL TERMINATED STREETS WITHOUT A CUL-DE-SAC SHALL HAVE A BARRICADE INSTALLED IN ACCORDANCE WITH STANDARD DETAIL R-24 OF THE STANDARD DETAILS.
- 41. ALL MANHOLE RIMS, LAMPHOLES, VALVES AND MONUMENT BOXES, ETC. SHALL BE ADJUSTED TO FINISH GRADE AFTER STREET PAVING BY THE UNDERGROUND CONTRACTOR AFTER THE FINAL PAVING COURSE IS PLACED, UNLESS OTHERWISE NOTED. COST FOR THIS WORK SHALL BE INCLUDED IN THE UNIT PRICES FOR MANHOLES.
- 42. UTILITY BOXES SET IN PAVED STREETS SHALL HAVE H-20 LIDS.

GRADING NOTES

- 43. ALL GRADING SHALL BE INSPECTED AND TESTED BY A QUALIFIED SOILS ENGINEER OR UNDER THEIR DIRECTION. THE SOILS ENGINEER SHALL INSPECT AND TEST THE PLACEMENT OF FILLS. THE SOILS ENGINEER SHALL SUBMIT A SOILS REPORT AND REQUIREMENTS AND WILL DETERMINE THE SUITABILITY OF ANY FILL MATERIAL, UPON COMPLETION OF GRAPING OPERATIONS THE SOILS ENGINEER SHALL STATE IN A REPORT TO THE COUNTY OF SAN JOAQUIN THAT INSPECTIONS AND TESTS WERE MADE BY HIM OR UNDER HIS SUPERVISION AND THAT IN HIS OPINION ALL FILLS ARE COMPACTED TO THE REQUIRED RELATIVE DENSITY AND ARE ACCEPTABLE FOR THEIR INTENDED USE.
- 44. THE CONTRACTOR SHALL LIMIT TRAFFIC SPEEDS ON ANY UNPAVED SURFACES TO 15 MILES PER HOUR TO LOWER THE AMOUNT OF DUST CREATED.
- 45. THE CONTRACTOR SHALL SUSPEND EXCAVATION AND GRAPING ACTIVITIES WHEN THE WINDS EXCEED 20 MILES PER HOUR.
- 46. DEVELOPER/CONTRACTOR'S WORK SHALL BE IN ACCORDANCE WITH THE S.NAPCD GUIDELINES, INCLUDING S.NAPCD REGULATION VIII AND IMPLEMENT CONTROL MEASURES BASED ON S.NAPCD'S COMPLIANCE ASSISTANT BULLETIN FOR SHORT TERM IMPACTS. S.NAPCD SHALL BE CONTACTED TO DISCUSS MITIGATION MEASURES AND IMPLEMENT MEASURES FROM TABLE 6-4 OF THE GUIDE FOR ASSESSING AND MITIGATING AIR QUALITY IMPACTS.

UTILITIES

- 47. ALL WORK SHALL BE DONE IN ACCORDANCE WITH THE COUNTY OF SAN JOAGUIN'S STANDARD SPECIFICATIONS, THE OAKWOOD LAKE WATER DISTRICT AND THE LATEST EDITION OF THE UNIFORM PLUMBING CODE.
- 48. THE CONTRACTOR SHALL COMPLY WITH THE REQUIREMENTS OF CHAPTER 9, SECTION 6705, 6706, AND 6707 OF THE STATE LABOR
- 49. THE CONTRACTOR SHALL SUBMIT FOR APPROVAL A DETAILED PLAN SHOWING THE DESIGN OF SHORING, BRACING, SLOPING, OR OTHER PROVISIONS TO BE MADE FOR WORKER PROTECTION FOR ALL AREAS TO BE EXCAVATED TO A DEPTH OF FIVE FEET OR MORE. IF THE PLAN VARIES FROM THE SHORING SYSTEM STANDARDS, THE PLANS SHALL BE PREPARED BY A REGISTERED CIVIL OR STRUCTURAL ENGINEER.
- 50. ALL TRENCHES SHALL BE BACKFILLED IN ACCORDANCE WITH SAN JOAQUIN COUNTY STANDARD DETAILS. COMPACTION SHALL BE ACHIEVED BY MECHANICAL MEANS. NO FLOODING, PONDING, OR JETTING SHALL BE PERMITTED UNLESS APPROVED BY THE OAKMOOD LAKE WATER DISTRICT ENGINEER IN WRITING, REFER TO THE P.V.C. SANITARY SENER TRENCH SECTION ON SHEET 3 FOR ADDITIONAL REQUIREMENTS FOR THE EMBEDMENT ZONE BACKFILL.
- 51. ALL PLASTIC PIPES INSTALLED SHALL HAVE TRACE WIRE INSTALLED AS PER THE SAN JOAQUIN COUNTY STANDARDS.
- 52. R.C.P. STORM DRAIN LINES AS SHOWN ON THE PLANS SHALL BE CLASS III OR HIGHER REINFORCED CONCRETE PIPE. USE RUBBER GASKETED JOINTS CONFORMING TO THE REGUIREMENTS OF ASTM DESIGNATIONS C-16 AND C-443 AND CHAPTER 3 OF THE COUNTY STANDARD SPECIFICATIONS. WHERE THE PLANS SHOW R.C.P. STORM DRAINS, 18 INCHES OR SMALLER IN DIAMETER, THE CONTRACTOR MAY USE POLYVINYL CHLORIDE PIPE CONFORMING TO ASTM D-3034, SDR 35, WITH RUBBER SEALING RINGS MEETING ASTM D-3212 "JOINTS FOR DRAINS AND SEMER PIPES USING FLEXIBLE ELASTOMERIC SEALS" AS PER THE SAN JOAQUIN COUNTY STANDARDS. BACKFILL OF P.V.C. STORM DRAIN LINES SHALL BE IN ACCORDANCE WITH THE BACKFILL REQUIREMENTS OF THE P.V.C. SANITARY SEMER LINES, AS PER THE DETAIL ON SHEET 4 OF THESE PLANS. UNLESS NOTED ALL STORM DRAIN MANHOLES ARE TYPE I (STANDARD DETAIL CW-57) AND ALL CURB INLETS ARE TYPE I (STANDARD DETAIL D-13). A SADDLE-TYPE MANHOLE (STANDARD DETAIL D-18) SHALL BE USED FOR ALL PIPES GREATER THAN 33" IN DIAMETER.
- 53. ALL ON-SITE STORM DRAIN INLETS MUST BE LABELED "NO DUMPING DRAING TO DELTA" USING AN APPROVED METHOD.
- 54. THE CONTRACTOR IS TO BE RESPONSIBLE FOR ALL TESTING OF STORM DRAIN FACILITIES. NATER
- 55. WATER LINES SHALL BE A MINIMUM OF 10 FEET FROM SENER MAINS, CROSSINGS SHALL MEET STATE HEALTH STANDARDS. SENER LINE NEEDS TO BE BELOW WATER LINE.

- 56. THE CONTRACTOR IS TO BE RESPONSIBLE FOR ALL TESTING AND DISINFECTION OF WATER LINES IN CONFORMANCE WITH THE REQUIREMENTS OF THE OAKHOOD LAKE WATER DISTRICT PRIOR TO FINAL ACCEPTANCE. ALL WATER LINES SHALL BE PRESSURE TESTED, DISINFECTED, FLUSHED AND TESTED FOR BACTERIA IN CONFORMANCE WITH SECTION 4, OF THE SAN JOAQUIN COUNTY STANDARDS PRIOR TO FINAL ACCEPTANCE BY THE WATER DISTRICT.
- 57. ACTUAL CONNECTIONS TO EXISTING WATER DISTRICT WATER LINES WILL NOT BE PERMITTED PRIOR TO THE COMPLETION OF STERILIZATION AND TESTING OF WATER MAINS. ALL EXISTING WATER VALVES ARE TO BE OPERATED UNDER THE DIRECTION OF THE WATER DISTRICT ONLY.
- 58. WATER SERVICES SHALL BE 1" DIAMETER PLASTIC PIPE AS PER SAN JOAQUIN COUNTY STANDARD SPECIFICATIONS AND STANDARD
- 59. THE LOCATION OF WATER SERVICES IN NEW SUBDIVISIONS SHALL BE MARKED BY THE CONCRETE CONTRACTOR WITH THE LETTER "W" STAMPED ON THE BACK OF SIDEMALK OR ON THE TOP OF CURB. THE UNDERGROUND CONTRACTOR SHALL PROVIDE SUFFICIENT RECORDS AND SHALL LEAVE ADEQUATE MARKS IN THE FIELD FOR THE CONCRETE CONTRACTOR TO ACCURATELY STAMP THE LETTER "H" FOR ALL MATER SERVICES, PRIOR TO PLACING ANY SIDEMALK OR CURB AND GUTTER. THE CONCRETE CONTRACTOR SHALL MERIFY THE LOCATIONS OF ALL DRIVENAYS, AND WATER SERVICES BEFORE POURING THE CURB, AND FURNISH TO THE SAN JOAGUIN COUNTY FIELD INSPECTOR SHOWING HE HAS ADEQUATE INFORMATION TO ACCURATELY FIELD LOCATE AND MARK THE LETTER "W" TO BE
- 60. FIRE HYDRANTS SHALL BE FURNISHED AND INSTALLED BY THE CONTRACTOR IN ACCORDANCE WITH THE SAN JOAQUIN COUNTY STANDARD SPECIFICATIONS AND STANDARD DETAIL CH-WIB. HYDRANTS SHALL BE LONG BEACH 425 OR EQUAL WITH 1 ~ 4 1/2" AND

SANITARY SEMER

- 61. GRAVITY SEMER PIPE: P.V.C. PIPE AS SHOWN ON THE PLANS SHALL BE POLYVINYL CHLORIDE PIPE CONFORMING TO ASTM D-3034, SDR 35, WITH RUBBER SEALING RINGS MEETING ASTM D-3212 "JOINTS FOR DRAINS AND SEMER PIPES USING FLEXIBLE ELASTOMERIC SEALS" OR AN APPROVED EQUAL.
- 62. SEMER LATERALS SHALL BE 4" IN DIAMETER, AND SHALL INCLUDE A CLEAN-OUT AT 1 FOOT MINIMUM TO 2 FEET MAXIMUM BEHIND THE BACK OF SIDEMALK. SEE PLANS FOR LOCATIONS AND DRAWING NO. S-7A.
- 63. THE LOCATION OF SENER SERVICES IN NEW SUBDIVISIONS SHALL BE MARKED BY THE CONCRETE CONTRACTOR WITH THE LETTER "S" STAMPED ON THE BACK OF SIDEMALK OR ON THE TOP OF CURB. THE UNDERGROUND CONTRACTOR SHALL PROVIDE SUFFICIENT RECORDS AND SHALL LEAVE ADEQUATE MARKS IN THE FIELD FOR THE CONCRETE CONTRACTOR TO ACCURATELY STAMP THE LETTER "S" FOR ALL SENER SERVICES, PRIOR TO PLACING ANY SIDENALK OR CURB AND GUTTER. THE CONCRETE CONTRACTOR SHALL VERIFY THE LOCATIONS OF ALL DRIVENAYS, AND SENER LATERALS BEFORE POURING THE CURB, AND FURNISH TO THE SAN JOAQUIN COUNTY FIELD INSPECTOR SHOWING HE HAS ADEQUATE INFORMATION TO ACCURATELY FIELD LOCATE AND MARK THE LETTER "S" TO BE STAMPED IN HIS WORK.
- 64. SEMER FORCE MAINS 4" AND LARGER SHALL BE POLYVINYL CHLORIDE CLASS 200 CONFORMING TO ANNA C-900. DUCTILE IRON FITTINGS INCLUDING TEES, CROSSES, CAPS, ETC. SHALL BE FLANGE, MECHANICAL JOINT OR COMBINATION THEREOF. MECHANICAL JOINT COUPLINGS SHALL CONFORM TO ANSI A21.10 (ANNA C110-77). ALL COUPLINGS SHALL BE CEMENT MORTAR LINED IN ACCORDANCE WITH ANNA C104-80, AND SHALL BE FURNISHED WITH RUBBER RING SEAL JOINTS DESIGNED TO BE USED WITH CLASS 200 P.V.C. PIPE, ANNA C-900.
- 65. SENER FORCE MAIN LINES SHALL BE INSTALLED WITH 36" MINIMUM COVER FROM FINISH GRADE.
- 66. SEMER FORCE MAINS SHALL BE INSTALLED WITH THRUST BLOCKS IN ACCORDANCE WITH THE SAN JOAQUIN COUNTY STANDARDS, DRAMING NO. CW-W4.

EROSION CONTROL NOTES

- 67. ALL WORK TO BE DONE SHALL BE DONE IN ACCORDANCE WITH THE COUNTY OF SAN JOAQUIN STANDARDS AND THE STATE OF CALIFORNIA, DEPARTMENT OF TRANSPORTATION, CONSTRUCTION SITE BEST MANAGEMENT PRACTICES (BMPs) MANUAL. THE CONTRACTOR SHALL BE RESPONSIBLE FOR ENSURING THAT ALL SUBCONTRACTORS, AND SUPPLIERS ARE AWARE OF, AND IMPLEMENT ALL STORM WATER QUALITY MEASURES. FAILURE TO COMPLY WITH THE APPROVED CONSTRUCTIONS BMPS WILL RESULT IN THE ISSUANCE OF CORRECTION NOTICES, CITATIONS AND/OR A PROJECT STOP ORDER.
- 68. THIS EROSION CONTROL PLAN WAS PREPARED AS AN EXHIBIT TO THE STORM WATER POLLUTION PREVENTION PLAN (S.W.P.P.P.) FOR THE OAKNOOD LAKE SUBDIVISION, AS REGUIRED BY THE STATE WATER RESOURCES CONTROL BOARD. THE FACILITIES SHOWN ON THIS PLAN ARE DESIGNED TO CONTROL SEDIMENT DURING THE RAINY SEASON AFTER ROUGH GRADING HAS BEEN COMPLETED. EROSION CONTROL MEASURES ARE TO BE OPERABLE PRIOR TO OCTOBER 15TH THROUGH APRIL 15TH OF ANY YEAR THAT GRAPING OPERATIONS HAVE LEFT AREAS UNPROTECTED FROM EROSION. NO GRADING WILL OCCUR BETWEEN OCTOBER 15TH AND APRIL 15TH, UNLESS AUTHORIZED BY THE DIRECTOR OF PUBLIC WORKS. DESIGN OF THESE FACILITIES MUST BE APPROVED OR UPDATED EACH YEAR PRIOR TO SEPTEMBER 30, AND SHALL BE SIGNED BY THE COUNTY ENGINEER. DAILY MAINTENANCE OF THESE FACILITIES SHALL BE MONITORED AND INSPECTED BY THE PROJECT COORDINATOR.
- 69. DURING THE RAINY SEASON ALL PAVED AREAS SHALL BE KEPT CLEAR OF EARTH MATERIALS AND DEBRIS. THE SITE SHALL BE MAINTAINED SO AS TO MINIMIZE SEDIMENT LADEN RUNOFF TO ANY STORM DRAINAGE SYSTEM.
- 70. CONSTRUCTION ENTRANCES CONSISTING OF AGGREGATE ON GEOTEXTILE FABRIC, AS PER THE DETAIL, SHALL BE PROVIDED AT EACH VEHICLE ACCESS POINT TO EXISTING PAVED ROADS.
- 71. ALL EROSION CONTROL MEASURES SHALL BE MAINTAINED UNTIL DISTURBED AREAS ARE STABILIZED. THIS PLAN MAY NOT COVER ALL THE SITUATIONS THAT ARISE DURING CONSTRUCTION DUE TO UNANTICIPATED FIELD CONDITIONS. REVISIONS MAY BE MADE TO THE PLAN IN THE FIELD SUBJECT TO THE APPROVAL OF THE DIRECTOR OF PUBLIC WORKS.
- 72. BORROW AREAS AND TEMPORARY STOCKPILES SHALL BE PROTECTED WITH APPROPRIATE EROSION CONTROL MEASURES TO THE SATISFACTION OF THE DIRECTOR OF PUBLIC WORKS.
- -73. CONSTRUCTION OPERATIONS SHALL BE CARRIED OUT IN SUCH A MANNER THAT EROSION AND WATER POLLUTION WILL BE MINIMIZED. STATE AND LOCAL LAWS CONCERNING POLLUTION SHALL BE COMPLIED WITH.
- 74. PRIOR TO THE COMMENCEMENT OF ANY CLEARING, GRADING OR EXCAVATION, THE CONTRACTOR/DEVELOPER SHALL PROVIDE EVIDENCE THAT A NOTICE OF INTENT (NOI) HAS BEEN SUBMITTED TO THE CALIFORNIA STATE WATER RESOURCES CONTROL BOARD. A COPY OF THE SWPPP SHALL BE KEPT AT THE CONSTRUCTION SITE AT ALL TIMES.

TACKIFIER

- 75. IF POSSIBLE, SILT FENCE FABRIC SHALL BE CUT FROM A CONTINUOUS ROLL TO AVOID THE USE OF JOINTS. WHEN JOINTS ARE NECESSARY, FILTER FABRIC SHALL BE SPLICED AT A SUPPORT POST, WITH A MINIMUM OF 6" OVERLAP AND BOTH ENDS SECURELY FASTENED TO THE POST.
- 16. SILT FENCES SHALL BE REMOVED WHEN THEY HAVE SERVED THEIR USEFUL PURPOSE, BUT NOT BEFORE THE UPSLOPE AREA HAS BEEN PERMANENTLY STABILIZED.
- 77. FILTER FABRIC SHALL BE NO. 2125 AS MANUFACTURED BY AMOCO CONSTRUCTION FABRICS, OR APPROVED EQUAL.
- 78. SEED AND MULCH SHALL BE APPLIED BY SEPTEMBER 15TH TO ALL DISTURBED SLOPES STEEPER THAN 2% AND HIGHER THAN 3 FEET, AND TO ALL CUT AND FILL SLOPES WITHIN OR ADJACENT TO PUBLIC RIGHT-OF-WAYS, OR AS DIRECTED BY THE DIRECTOR OF PUBLIC WORKS.
- 79. SEED AND PERTILIZER WILL BE APPLIED HYDRAULICALLY OR BY HAND AT THE RATES SPECIFIED BELOW. ON SLOPES STRAW SHALL POUNDS PER ACRE

ZORRO ANNUAL FESCUE 10 LBS. ROSE CLOVER 8 LBS. HYDROMULCH FIBER 1500 LBS. 16-20-0 FERTILIZER (AMMONIUM PHOSPHATE)

300 LBS.

Date 3/12/2008 Any Percon Using This Drawing Should Verity. All information By inspecting The Site Of World Book of the Original Application. If

AFTER THE INITIAL PLANTING. 61. ALTERNATIVE EROSIONS CONTROL TECHNIQUES MUST BE USED IN THE EVENT ADEQUATE VEGETATION IS NOT ESTABLISHED PRIOR TO THE FIRST ANTICIPATED SIGNIFICANT RAIN EVENT OF THE SEASON.

THE GROWTH IS OVER 60% DAMAGED, REPLANT USING THE ORIGINAL SPECIFICATIONS. THIS SHOULD BE DONE 14 TO 21 DAYS

- WASH OUT AREA 82. TEMPORARY CONCRETE MASH OUT AREAS SHALL BE LOCATED A MINIMUM OF 50 FEET FROM STORM DRAIN INLETS, OPEN DRAINAGE FACILITIES OR WATERCOURSES. TEMPORARY CONCRETE WASHOUT AREAS SHALL BE CONSTRUCTED WITH A PIT OR BERMED AREA AND
- BE MAINTAINED IN SUFFICIENT QUANTITY AND SIZE TO CONTAIN ALL LIQUID AND CONCRETE WASTE GENERATED BY WASHOUT OPERATIONS. WASH OUT AREAS SHALL BE CONSTRUCTED WITH A 10 FOOT MINIMUM WIDTH. 83. ONCE CONCRETE WASTES ARE WASHED INTO THE DESIGNATED AREA AND ALLOWED TO HARDEN, THE CONCRETE SHALL BE BROKEN UP, REMOVED, AND DISPOSED OF PER BMP MM-5, "SOLID WASTE MANAGEMENT", AND IN CONFORMANCE WITH THE PROVISIONS IN THE
- 84. TEMPORARY WASH OUT AREAS SHALL BE LINED WITH POLYETHYLENE PLASTIC LINING MATERIAL THAT IS A MINIMUM OF 60 MIL THICKNESS, FREE FROM HOLES, TEARS OR OTHER DEFECTS THAT WOULD COMPROMISE THE IMPERMEABILITY OF THE MATERIAL.

STATE STANDARD SPECIFICATIONS, SECTION 15-3.02, "REMOVAL METHODS". DISPOSE OF HARDENED CONCRETE ON A REGULAR

05. WHEN TEMPORARY WASH OUT FACILITIES ARE NO LONGER REQUIRED FOR THE WORK. THE HARDENED CONCRETE SHALL BE REMOVED AND DISPOSED OF AS NOTED ABOVE. MATERIALS USED TO CONSTRUCT TEMPORARY WASH OUT FACILITIES SHALL BECOME THE PROPERTY OF THE CONTRACTOR AND SHALL BE REMOVED FROM THE SITE AND BE DISPOSED OF IN ACCORDANCE WITH STATE STANDARD SPECIFICATIONS, SECTION 7-1.13.


NOTICE OF INTENT


86. THE STATE WATER RESOURCES CONTROL BOARD HAS RECEIVED AND PROCESSED THE NOTICE OF INTENT TO COMPLY WITH THE TERMS OF THE GENERAL PERMIT TO DISCHARGE STORM WATER ASSOCIATED CONSTRUCTION ACTIVITY. THE WOLD IDENTIFICATION NUMBER IS 5539C330037, FOR ANY COMMUNICATIONS REGARDING THIS PERMIT.

CI. ERII Pesig



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DRAWN BY: J.S.H. DATE: AUG. 14, 2006 SCALE: _1 "=500' _{DWG:} 2966-CVR CHECKED: KW

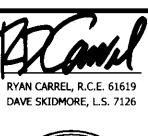JOB # <u>296</u>H-04 SHEET

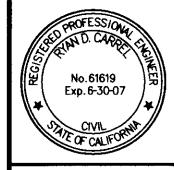STREET IMPROVEMENT PLANS FOR OAKMOOD LAKE SUBDIVISION, UNIT 4 TRACT NO. 3477


SUBDIVISIONS OF SAN JOAQUIN COUNTY

MAJOR SUBDIVISION APPLICATION NO. PA-02-98 874 EAST WOODWARD AVENUE, MANTECA

BEING A DIVISION OF A PORTION OF SECTION 10, TOWNSHIP 2 SOUTH, RANGE 6 EAST, MOUNT DIABLO MERIDIAN

SAN JOAQUIN COUNTY

CALIFORNIA

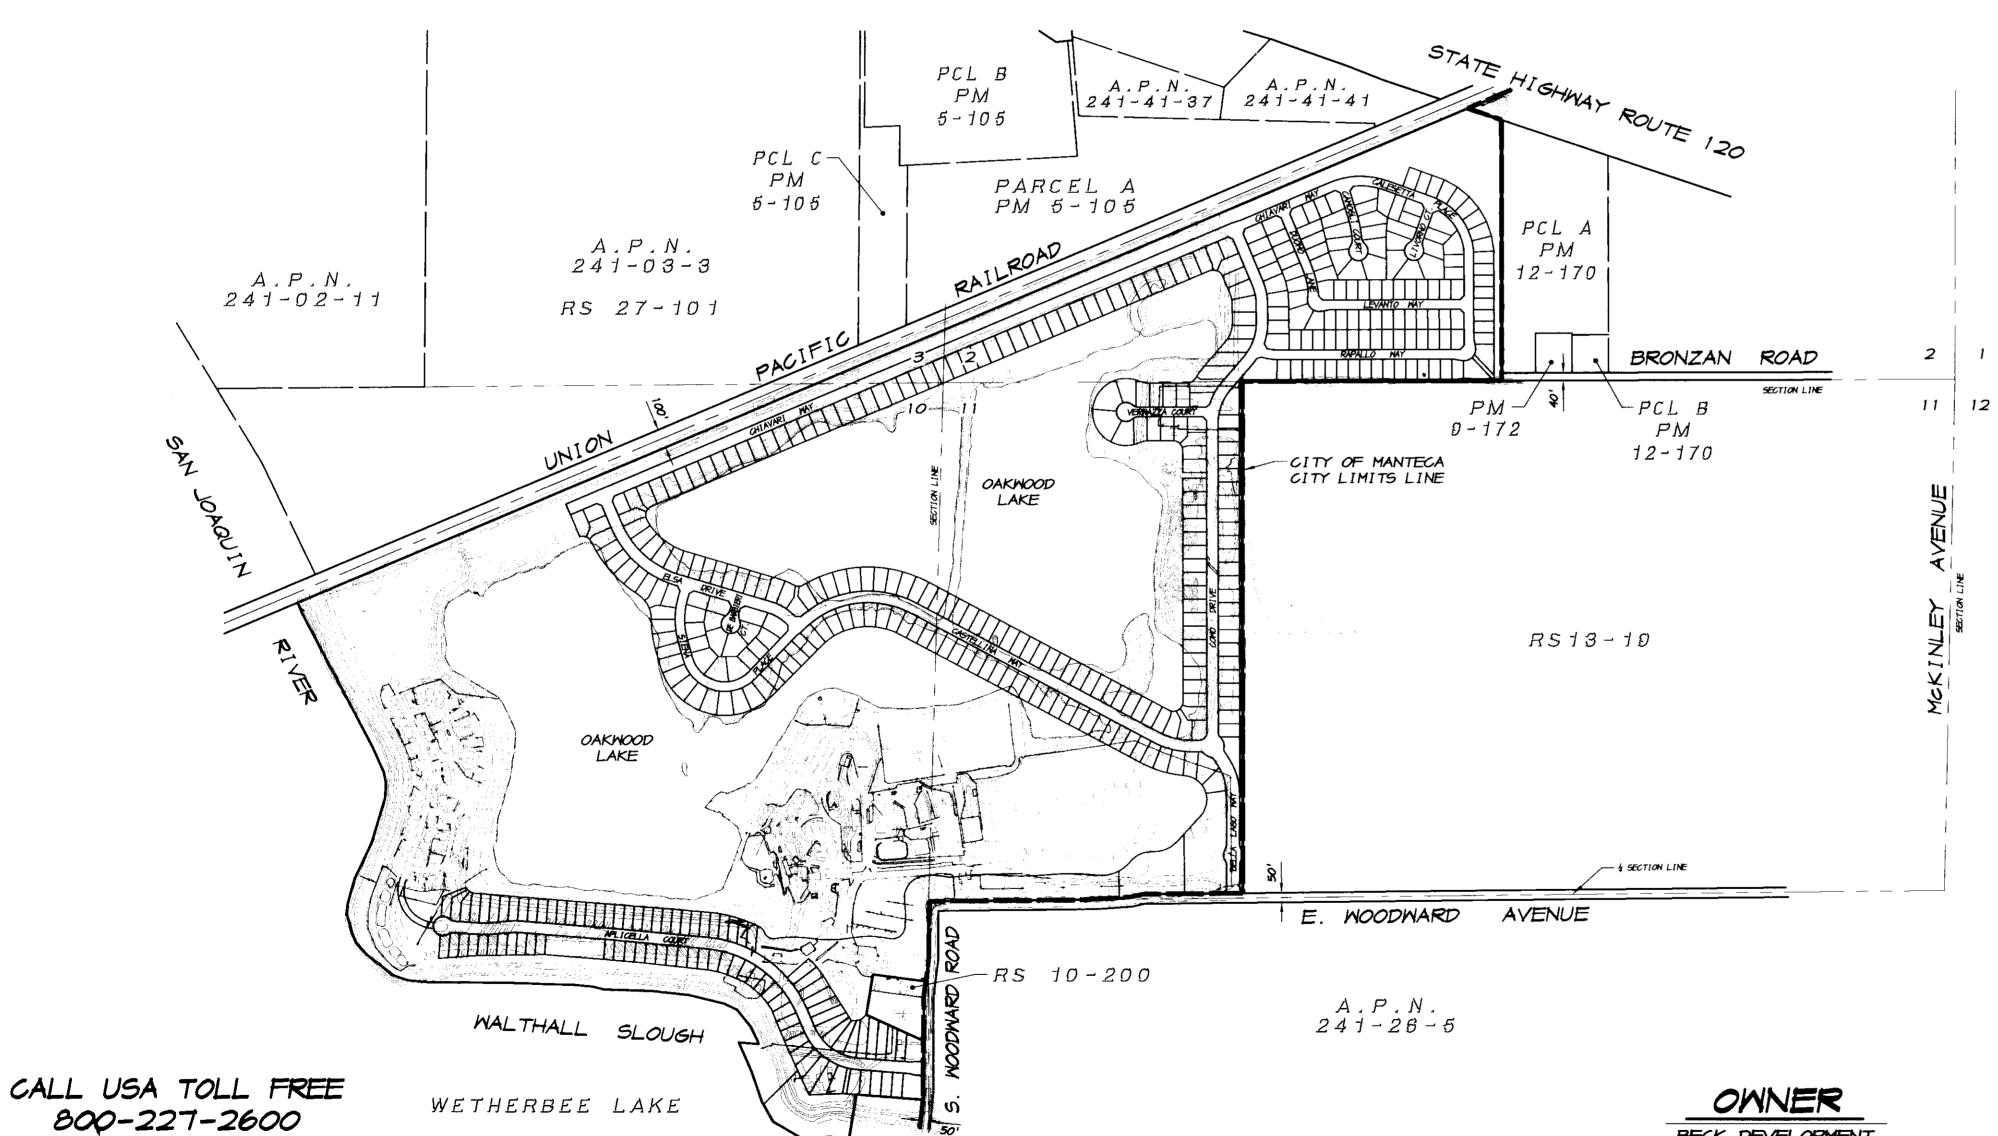

BECK DEVELOPMENT 3114 WEST HAMMER LANE PHONE (209) 957-0331 ATTN.: KEN FRITZ

STOCKTON, CALIFORNIA 95209

VICINITY MAP

DESCRIPTION YICINITY MAP & INDEX SPECIFICATIONS

STREET SECTIONS AND DETAILS SECTIONS AND DETAILS

SANITARY SEWER & STORM DRAIN PLAN WATER PLAN

STRIPING & SIGNAGE PLAN

PLAN & PROFILE SHEETS APLICELLA COURT, STA. 1+00 TO STA. 6+00 APLICELLA COURT, STA. 6+00 TO STA. 12+00 APLICELLA COURT, STA. 12+00 TO STA. 22+50 APLICELLA COURT, STA. 22+50 TO STA. 29+19

MOBILE HOME PARK ENTRANCE STORM DRAIN OUTFALL LINES

CONCRETE "Y" DITCH & S.D. CONNECTION CONCRETE "Y" DITCH & S.D. CONNECTION

CONCRETE "Y" DITCH 23 STORM DRAIN CONNECTION EROSION CONTROL PLAN

EROSION CONTROL PLAN EROSION CONTROL DETAILS

BENCHMARK

CITY OF MANTECA BENCHMARK NO. 71, 2" BRASS CAP LOCATED 25 FEET ± NORTH OF THE NORTHEAST CORNER OF SECTION 11. TOWNSHIP 2 SOUTH, RANGE 6 EAST, MOUNT DIABLO MERIDIAN, AT THE INTERSECTION OF MCKINLEY AVENUE AND BRONZAN ROAD. ELEVATION = 16.703, U.S.G.S. DATUM



RECORD DRAWING

Corrections By Date 3/12/2008 Any Person Using This Drawing Should Verity All information By inspecting The Site Of Work

LATHROP - MANTECA FIRE DISTRICT APPROVED BY THE DISTRICT ENGINEER OF THE OAKWOOD LAKE WATER DISTRICT, MANTECA, CALIFORNIA. DATE: 8-23-06 DATE: 8-24-06 / FIRE MARSHAL COUNTY OF SAN JOAQUIN DEPARTMENT OF PUBLIC WORKS MICHAEL GILTON, R.C.E. 25853

GEOTECHNICAL REPORT

THESE IMPROVEMENT PLANS CONFORM TO THE APPROVED GEOTECHNICAL REPORT FOR THE OAKWOOD LAKE DEVELOPMENT LOCATED IN SAN JOAQUIN COUNTY, CALIFORNIA.


KLEINFELDER, YNC.

8-23-06

SENIOR CIVIL ENGINEER. RCE NO: 46533

EXP. DATE: 6/30/07 APPROVED

DIRECTOR OF PUBLIC WORKS

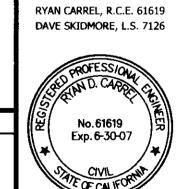

DRAWN BY: J. S. H. DATE: AUG. 14, 2006 SCALE: 1 "=500' DWG: 2966-CVR CHECKED: KW OOB # 296H-04

SHEET

PUSHING, ETC., CALL UNDERGROUND SERVICE ALERT FOR UNDERGROUND CLEARANCE. USA WILL PROVIDE INFORMATION ABOUT, OR LOCATE AND MARK UNDERGROUND FACILITIES FOR YOU.

BEFORE PLANTING TREES, TRENCHING,

DIGGING FENCE POST HOLES, BLASTING

GRADING, EXCAVATING, DRILLING, PIPÈ

PROJECT LAYOUT MAP