
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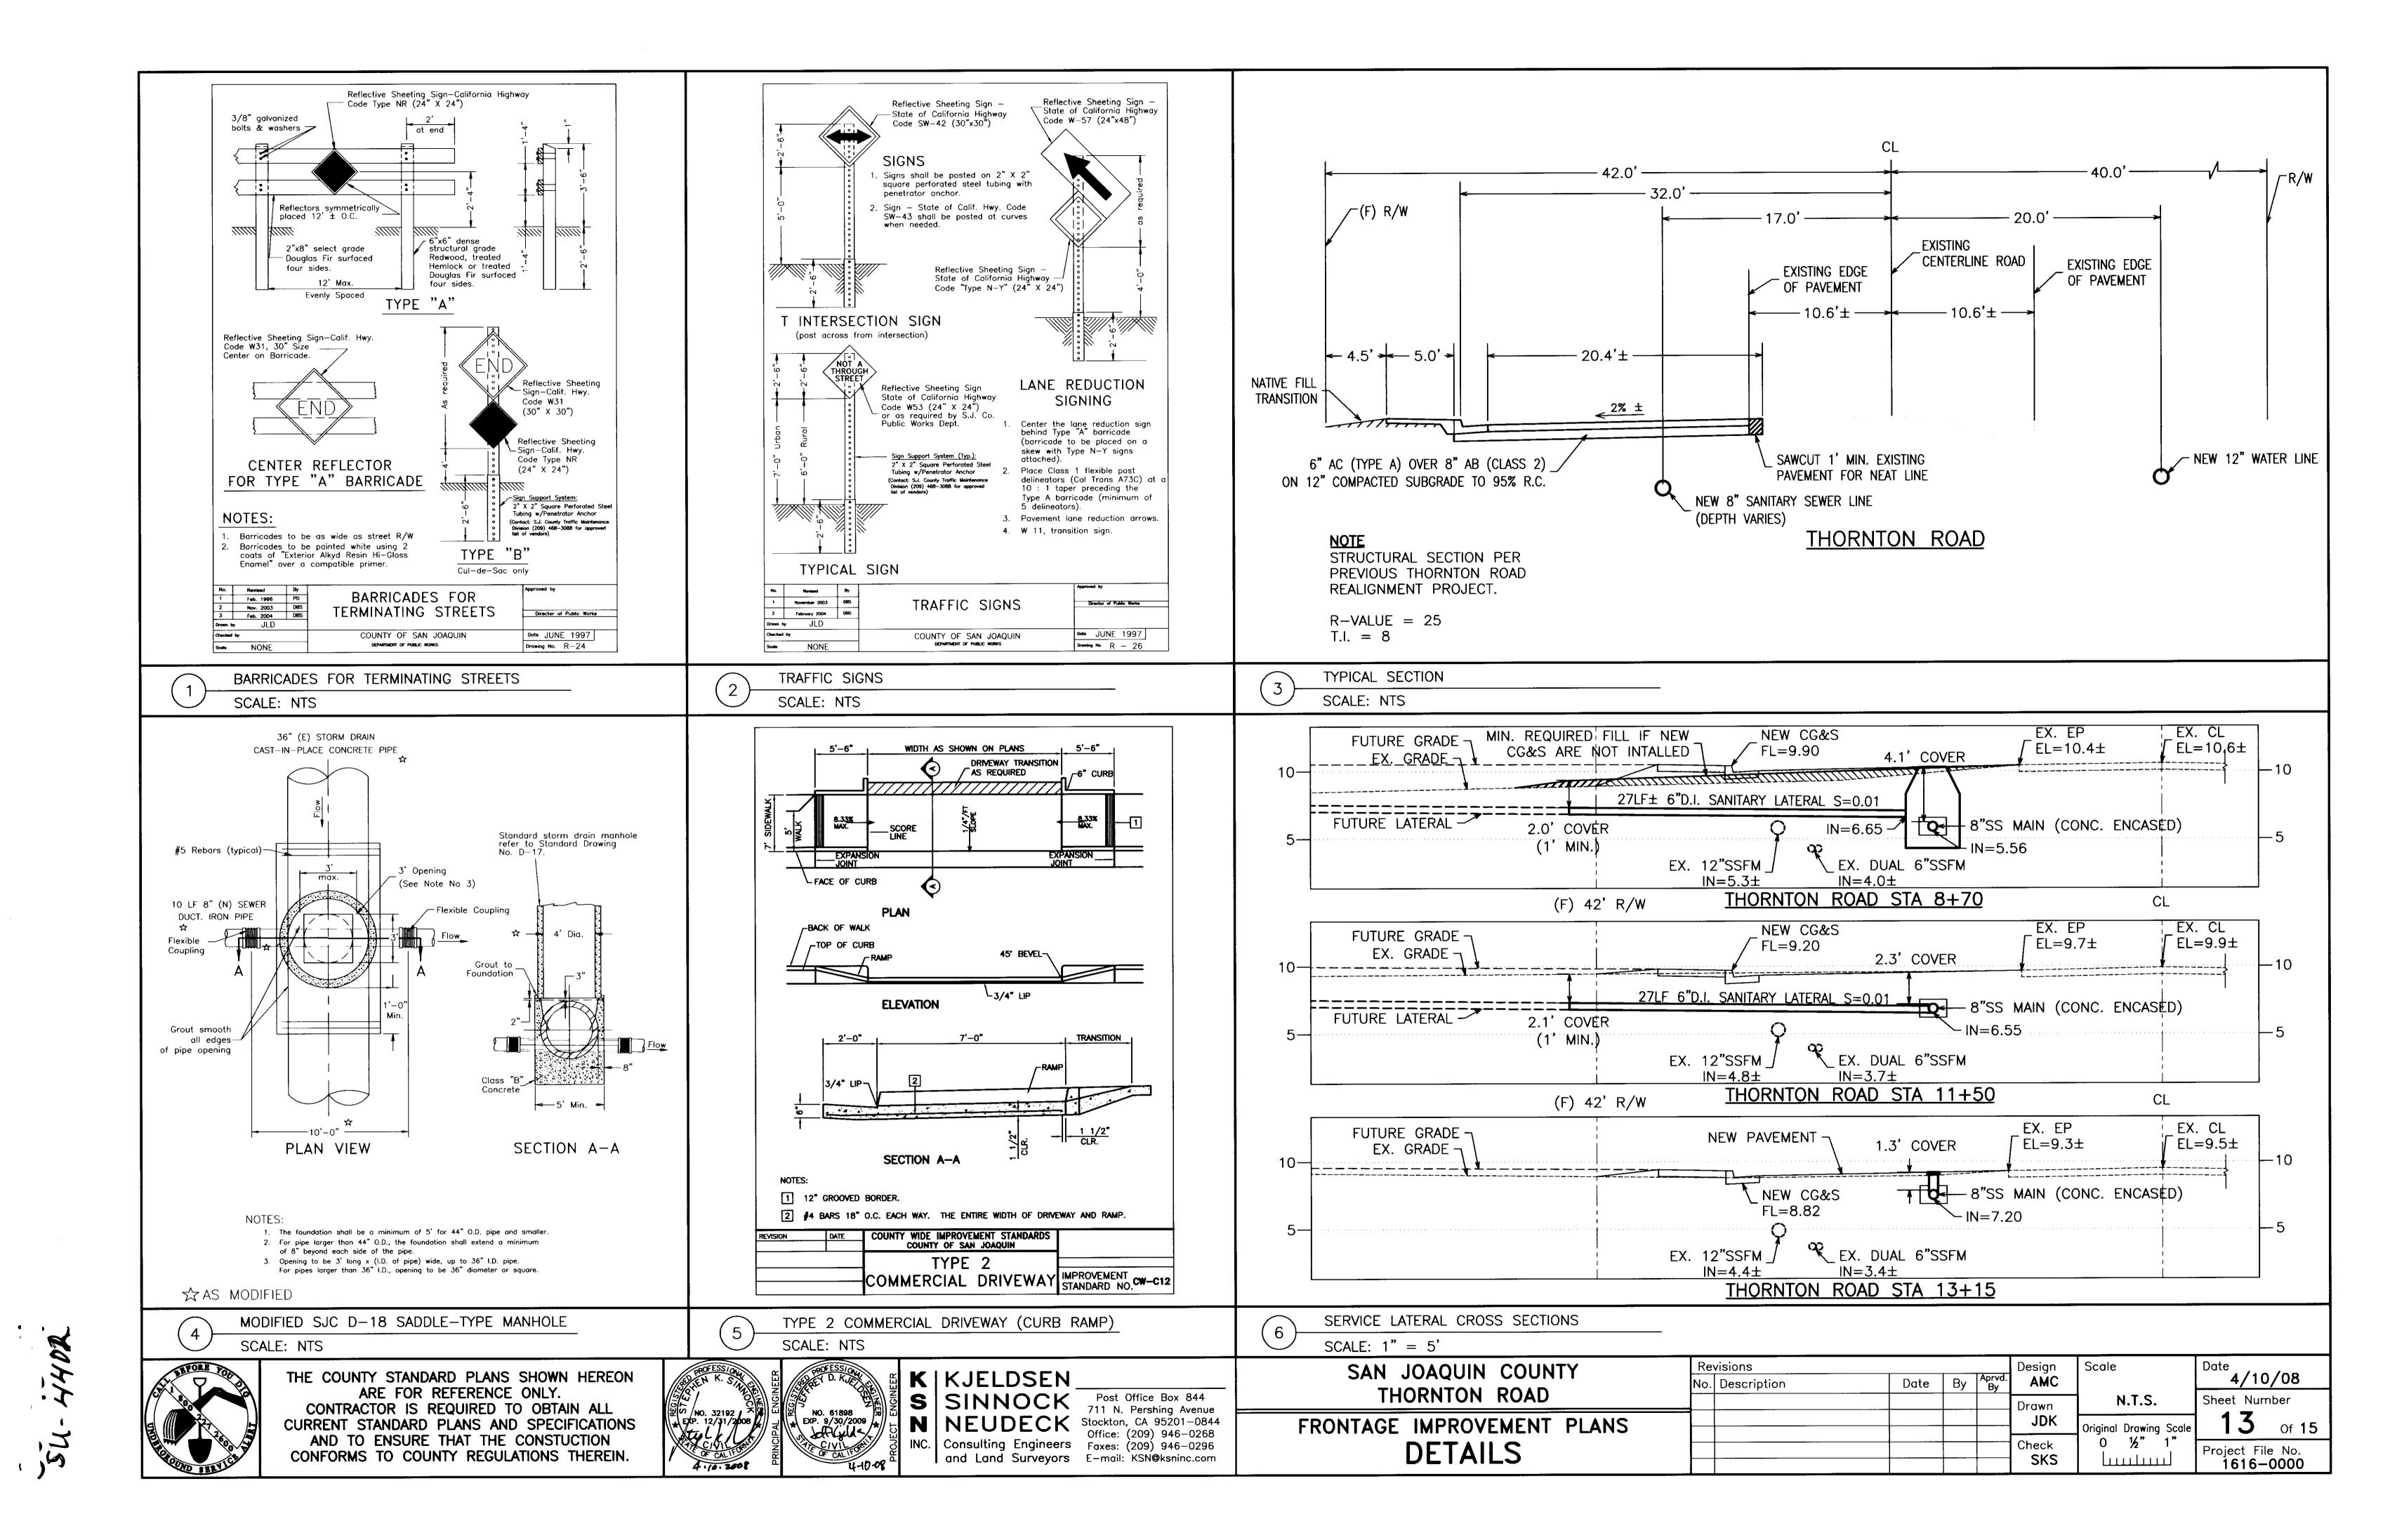
/ STRAW BALES

4 INCH MAX.
2 INCH MIN.


FIBER ROLL


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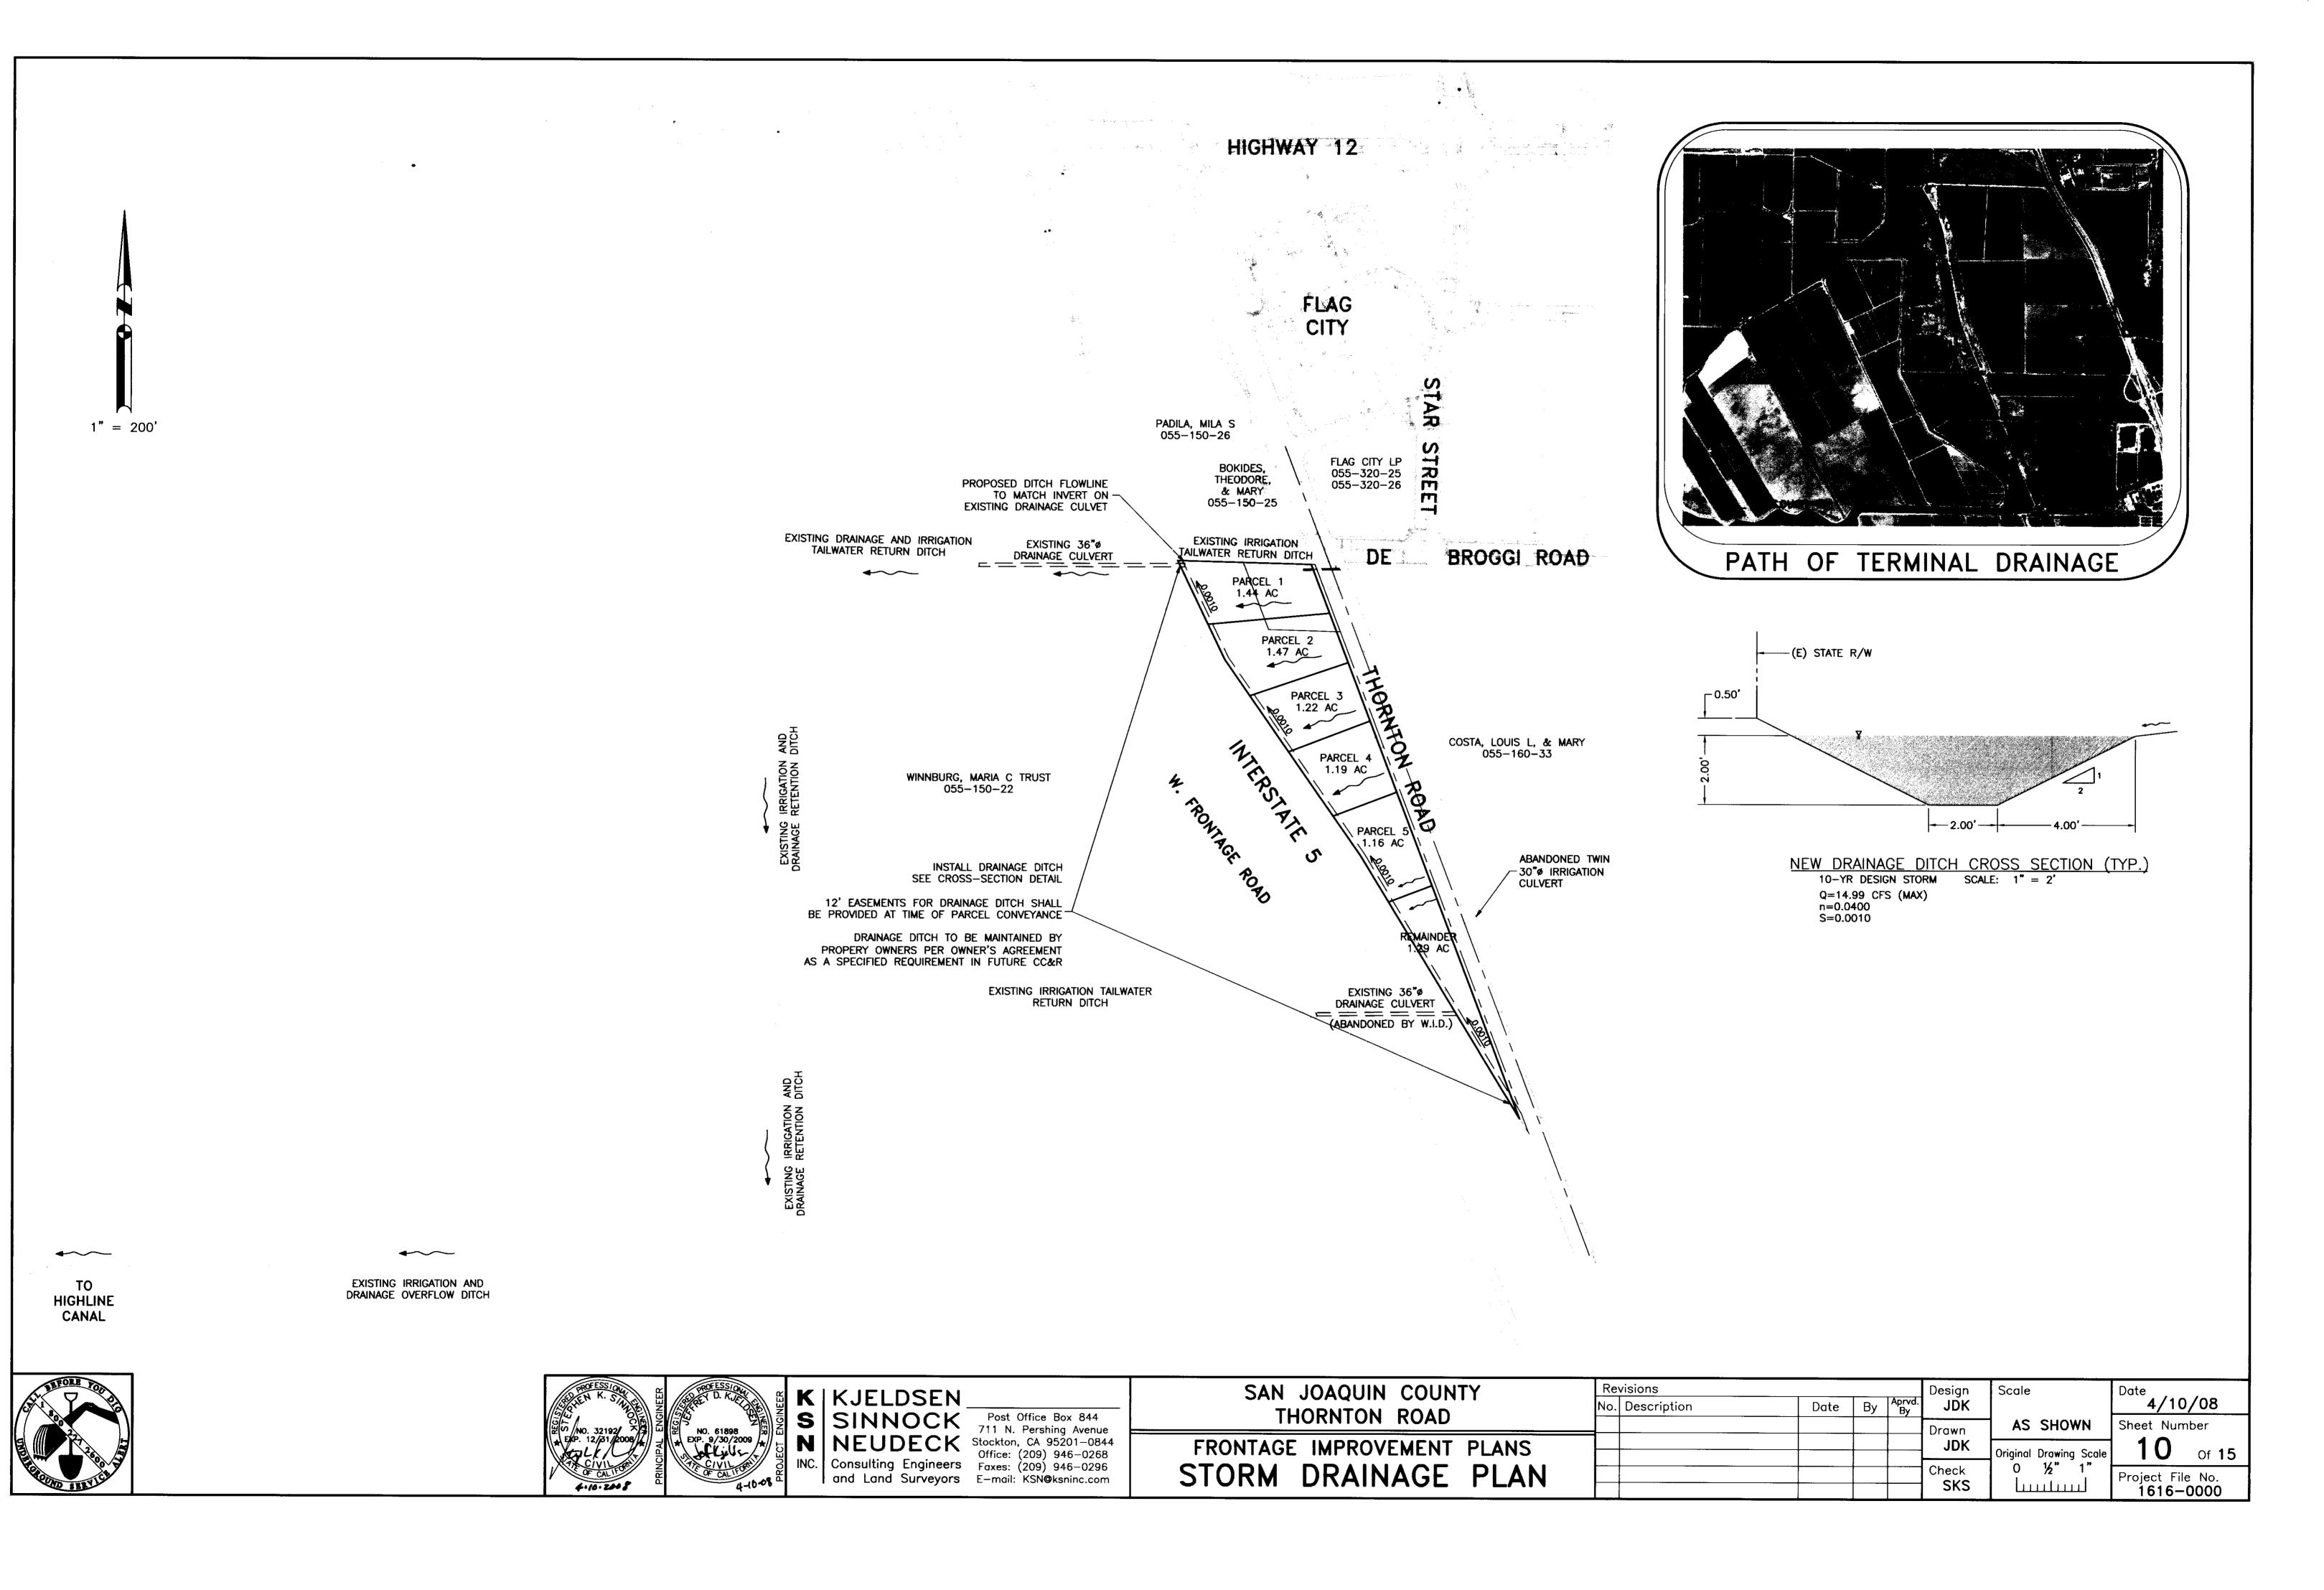


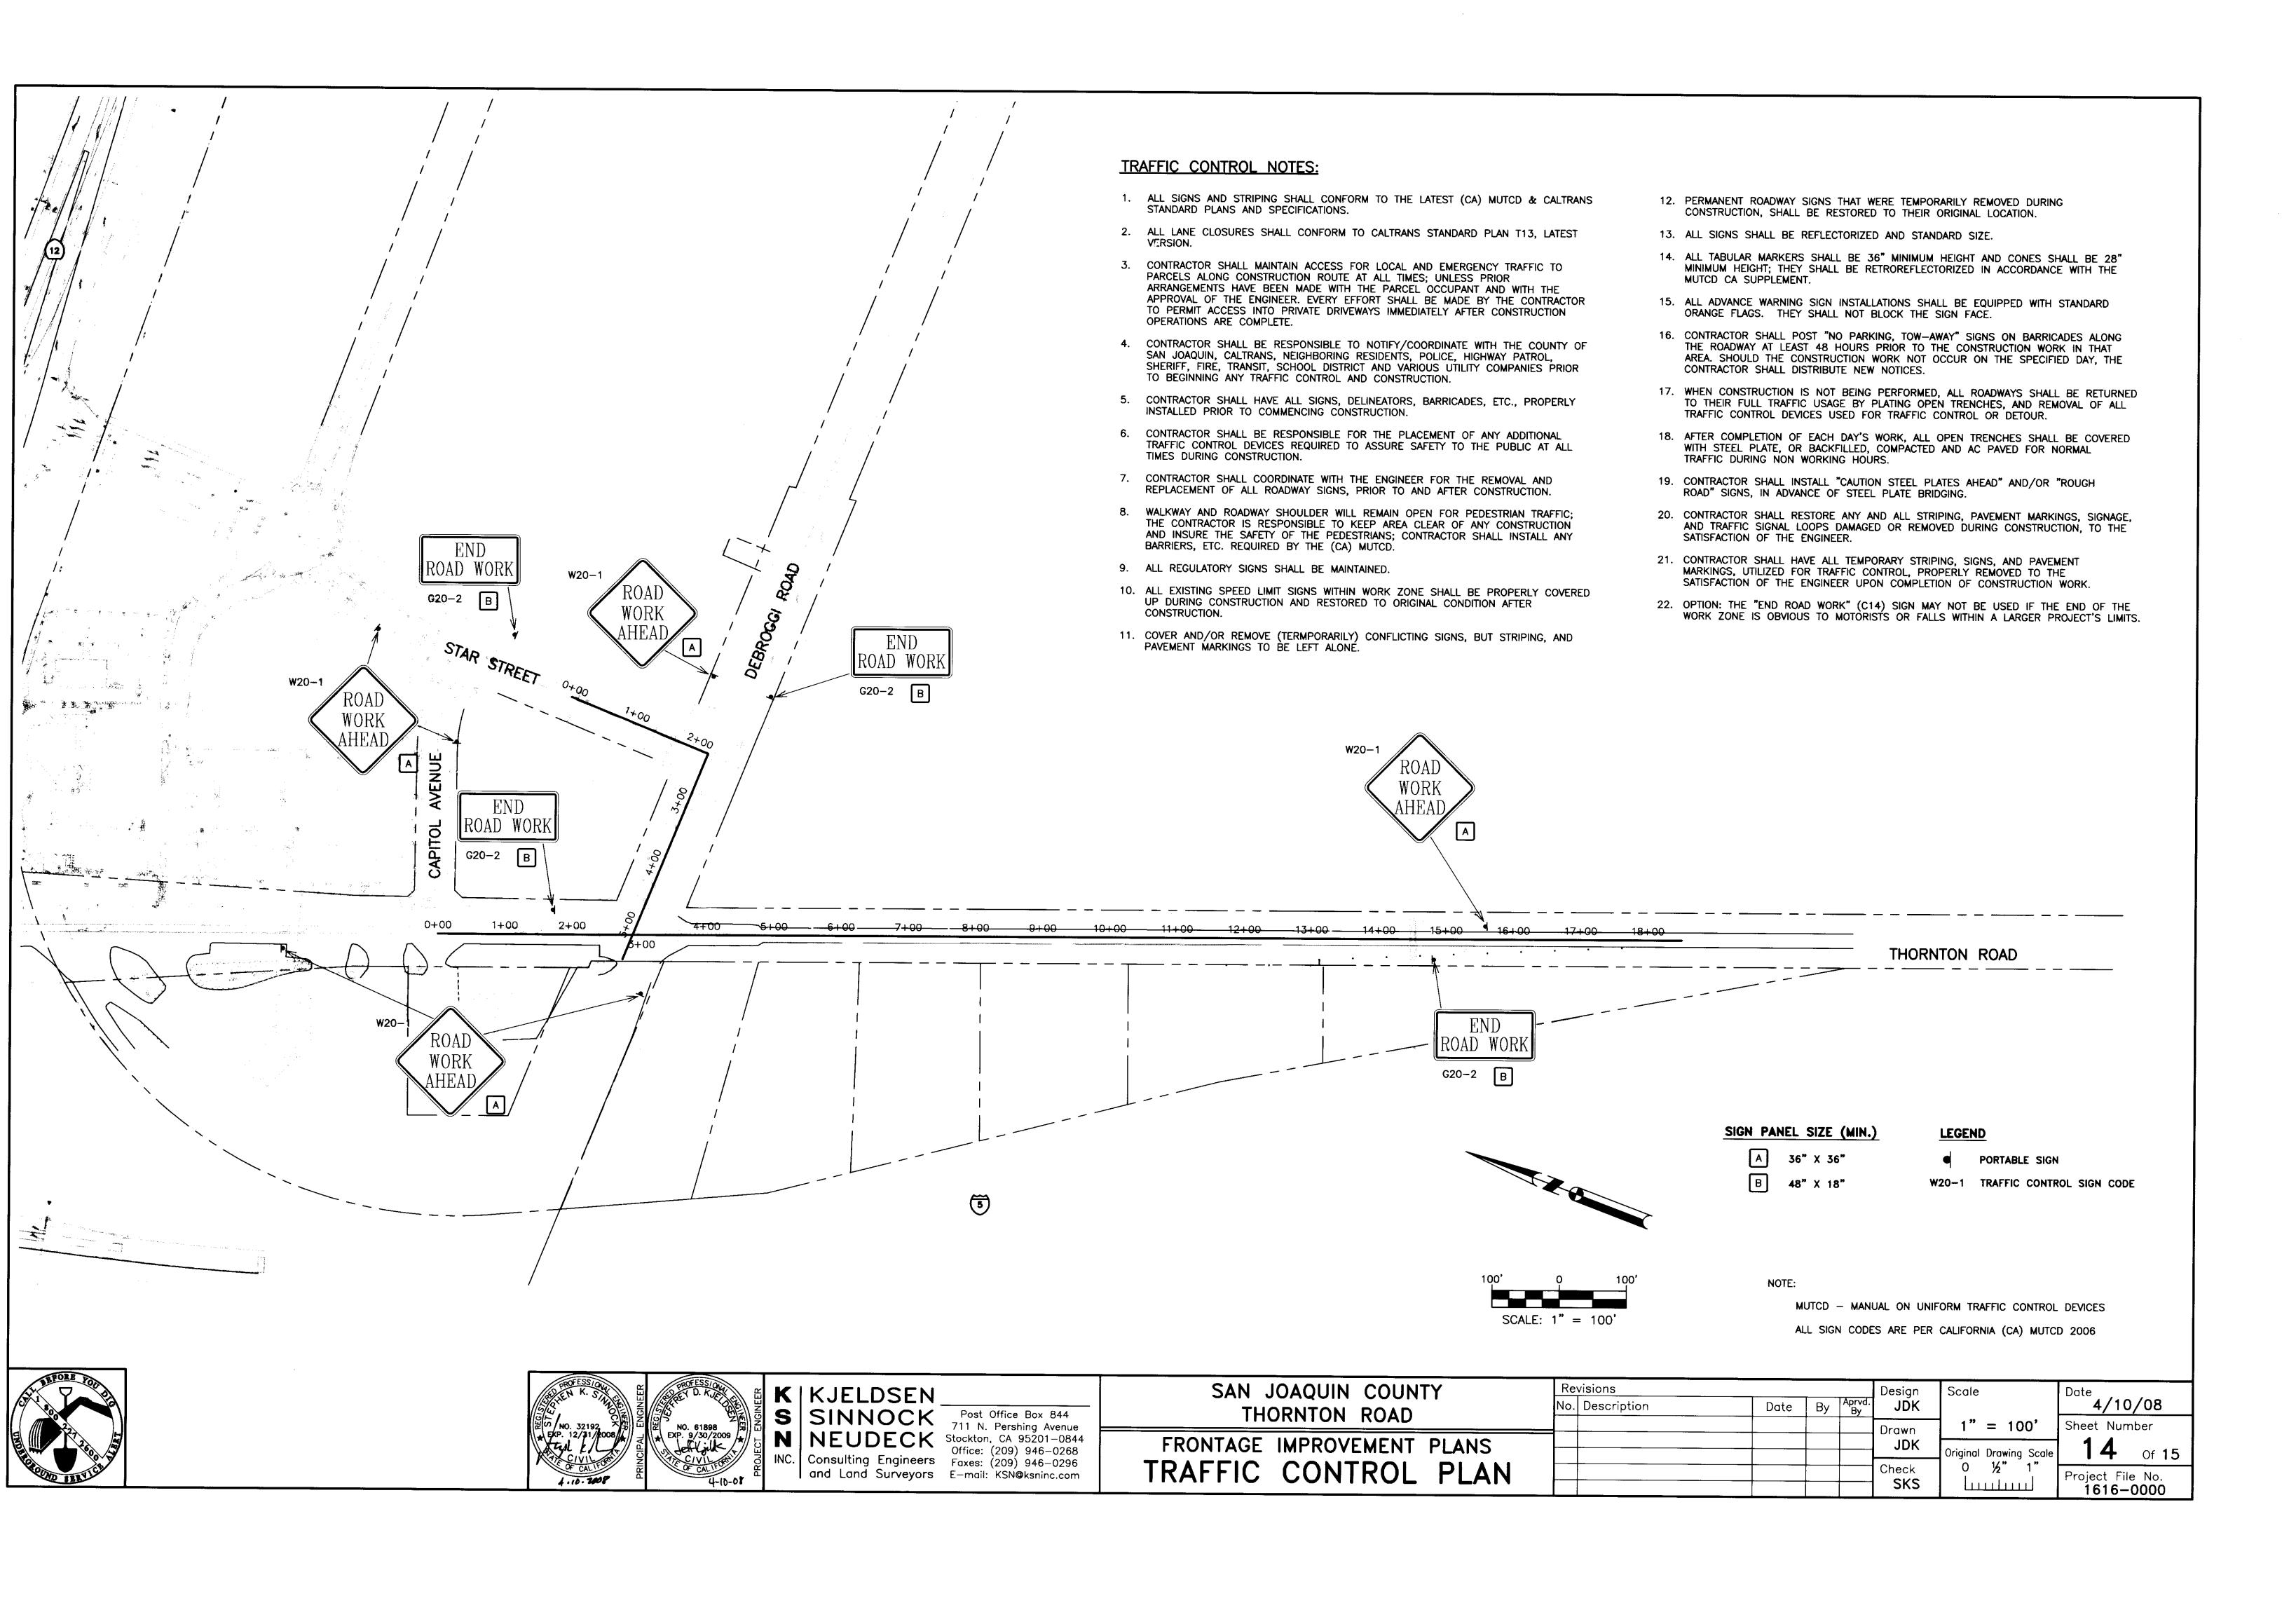








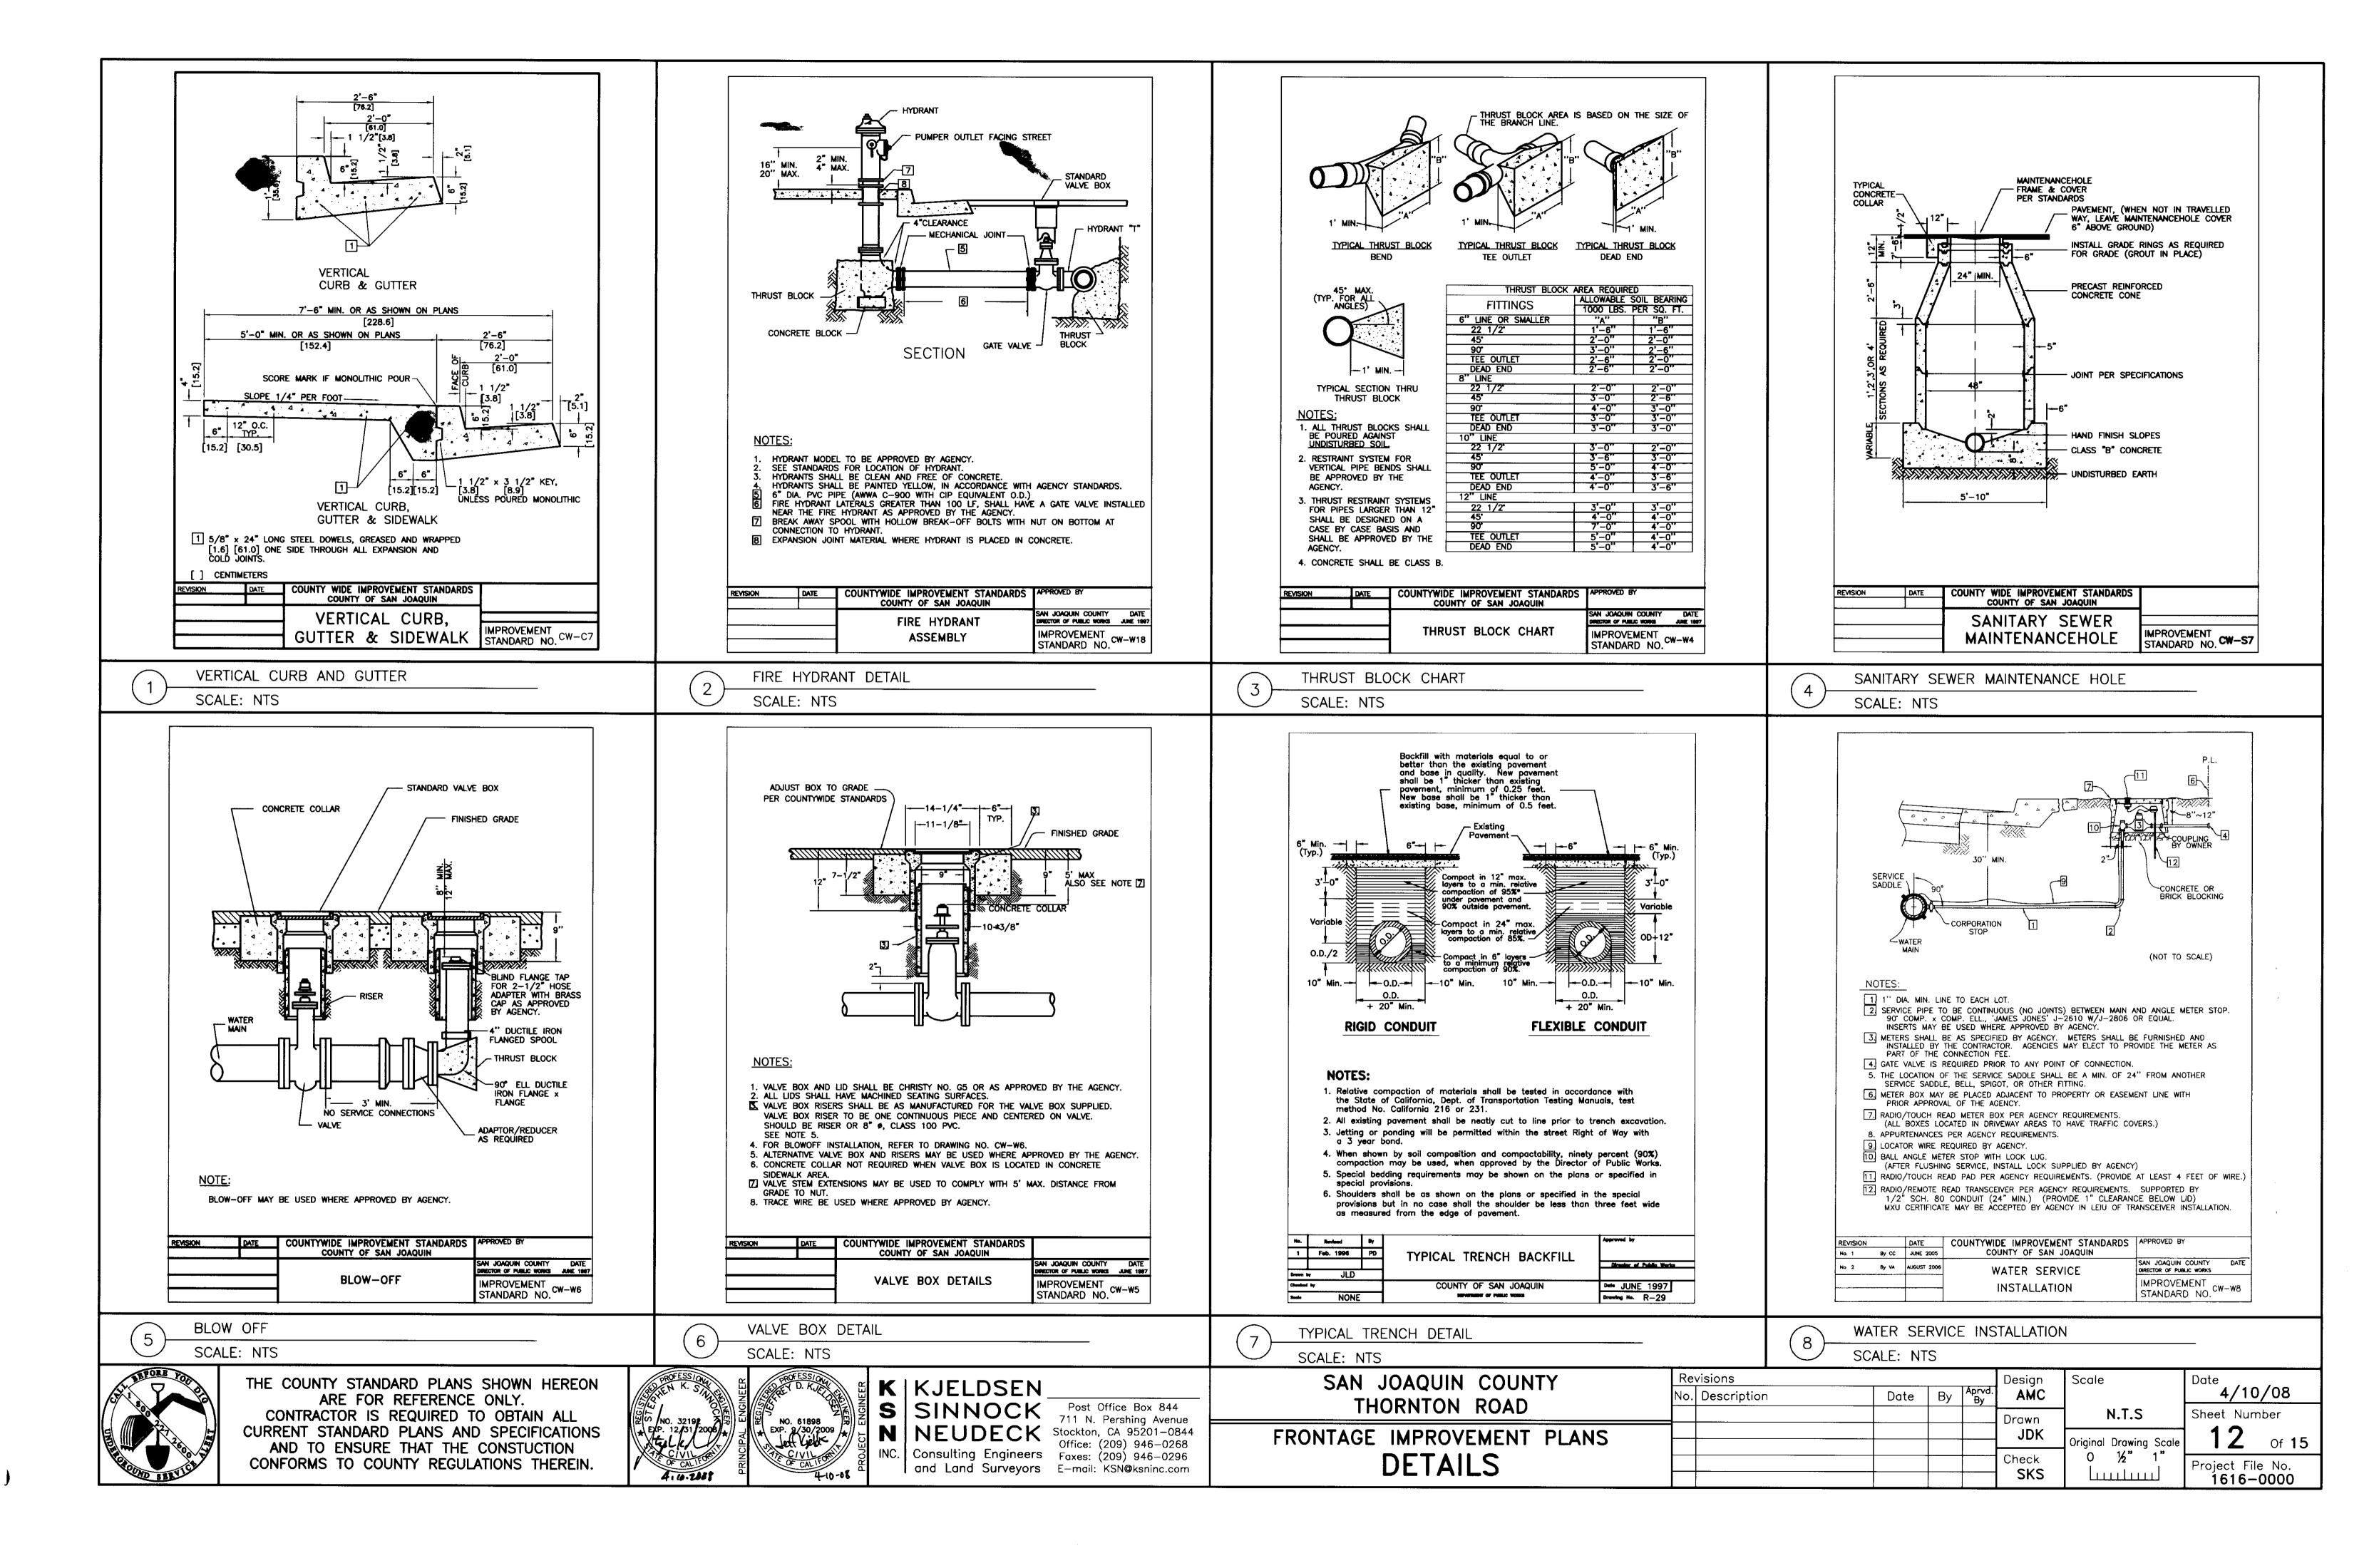


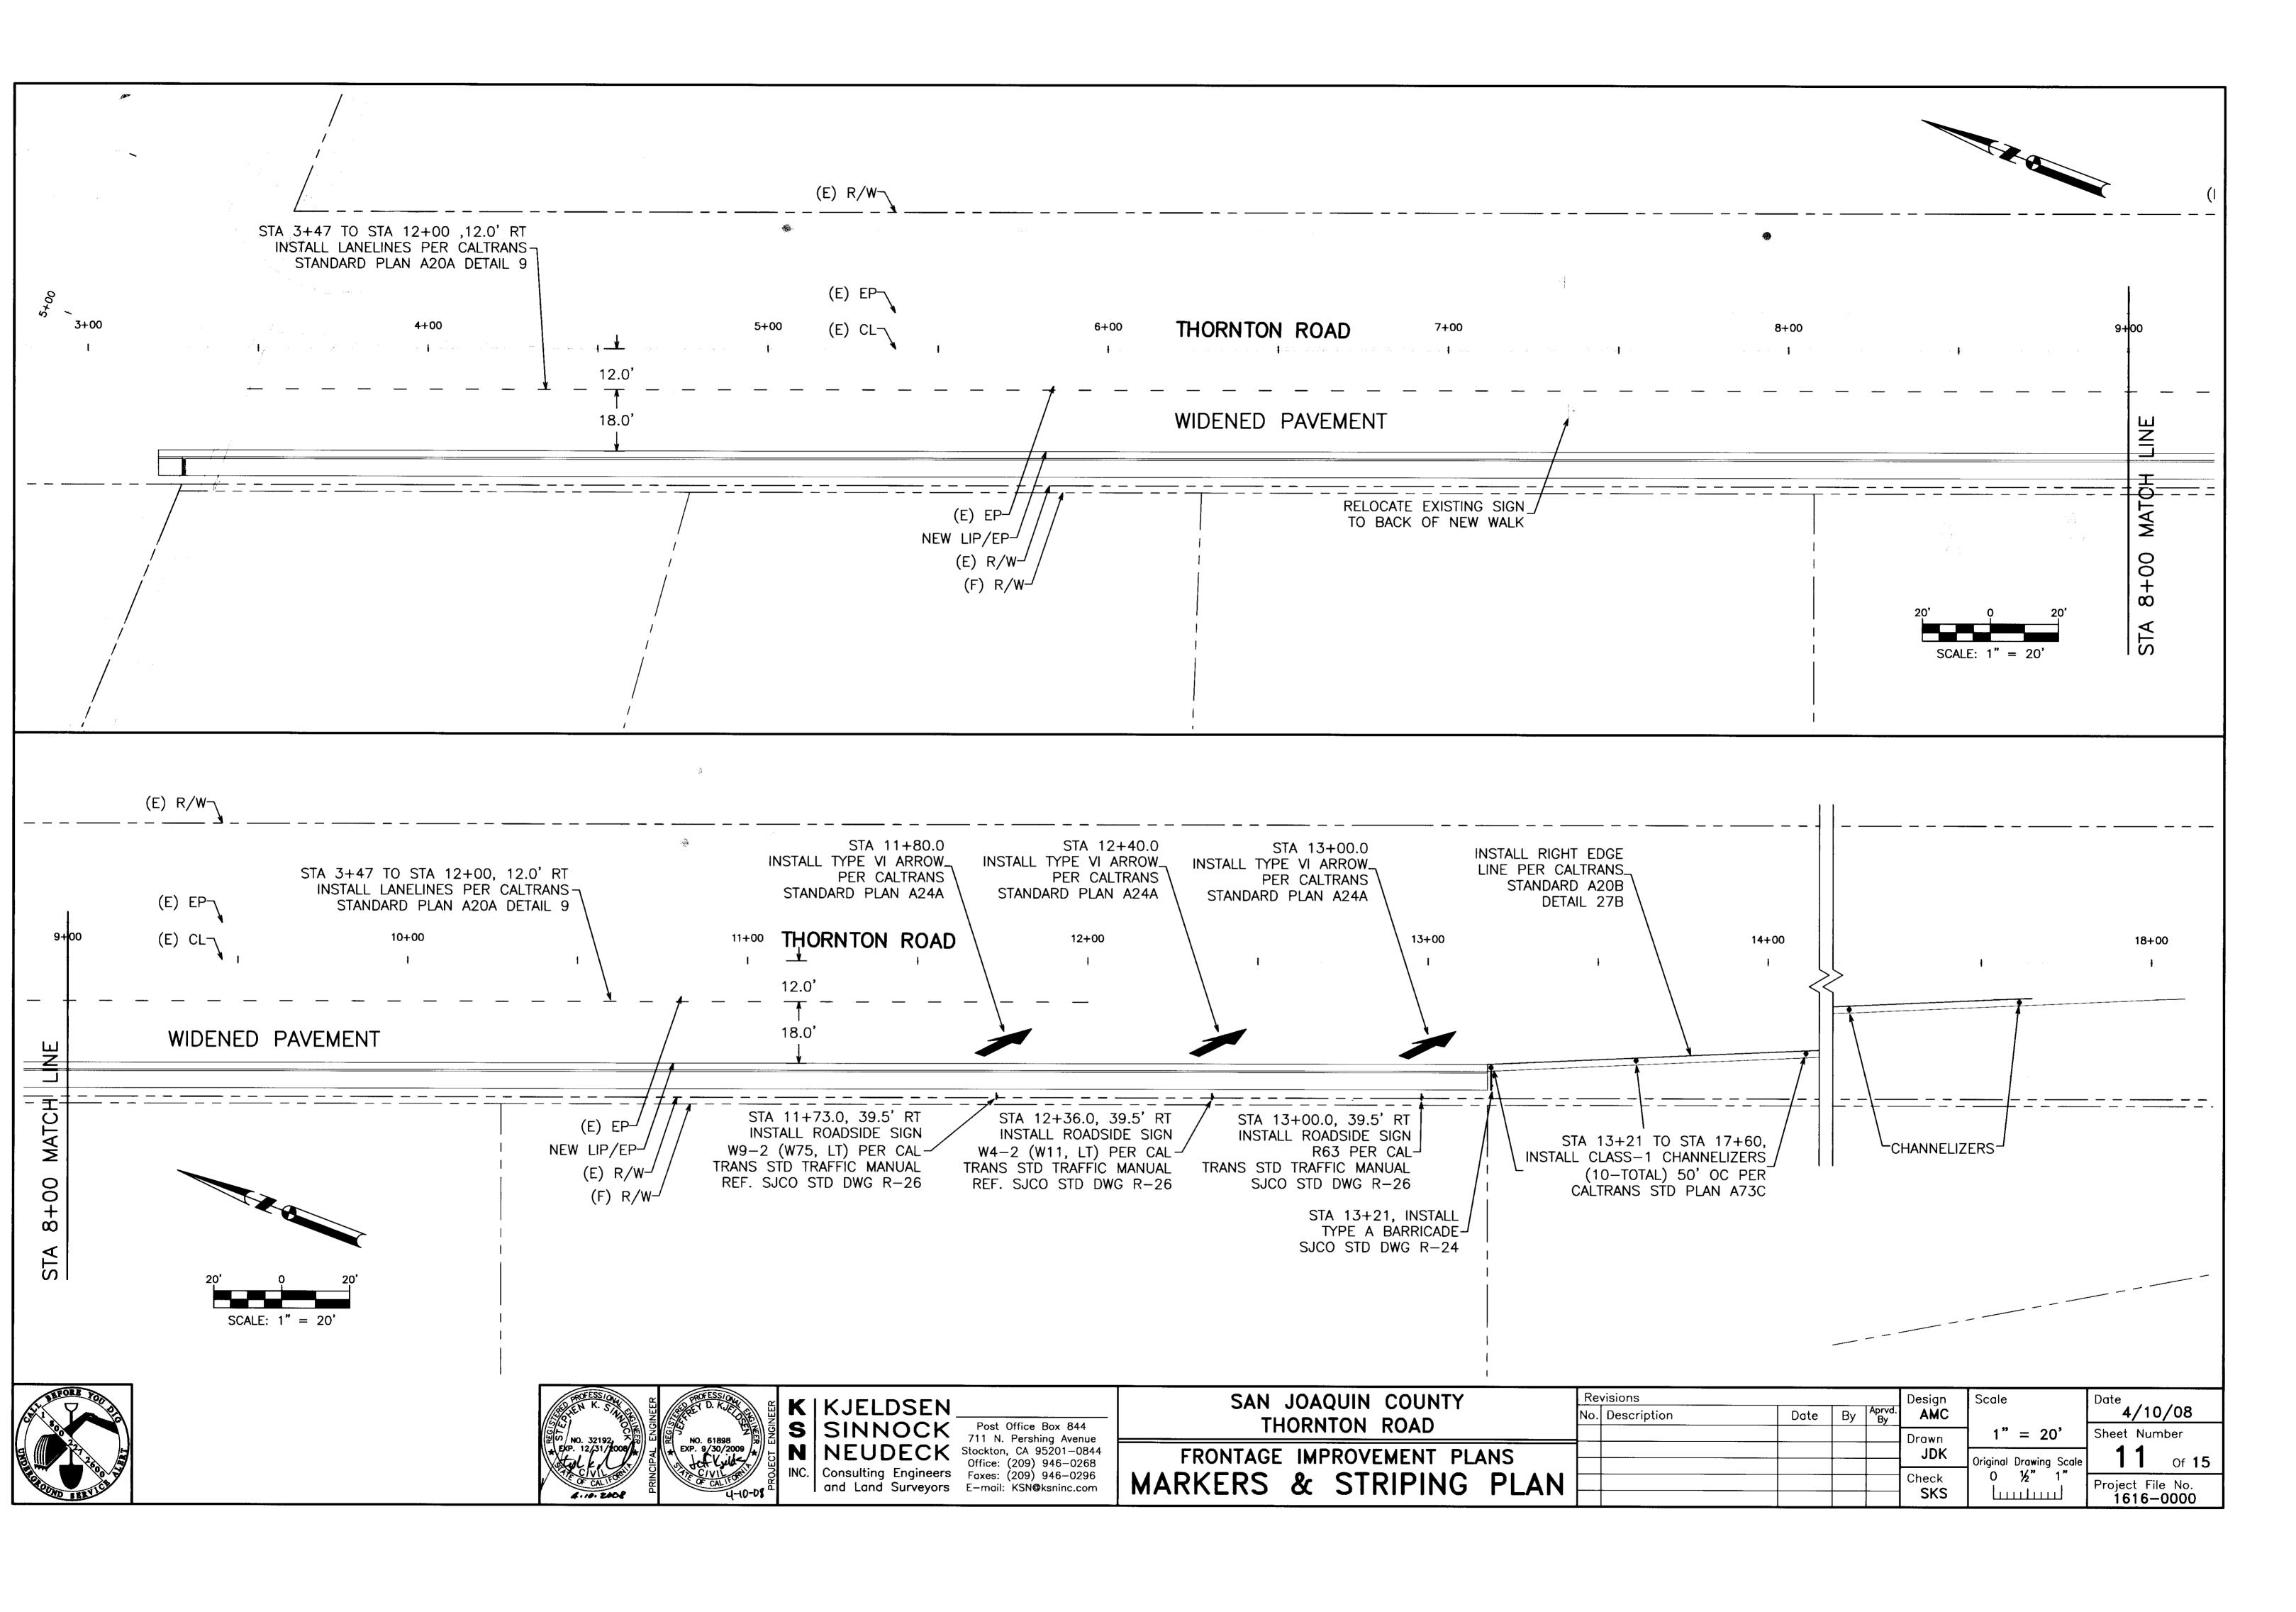

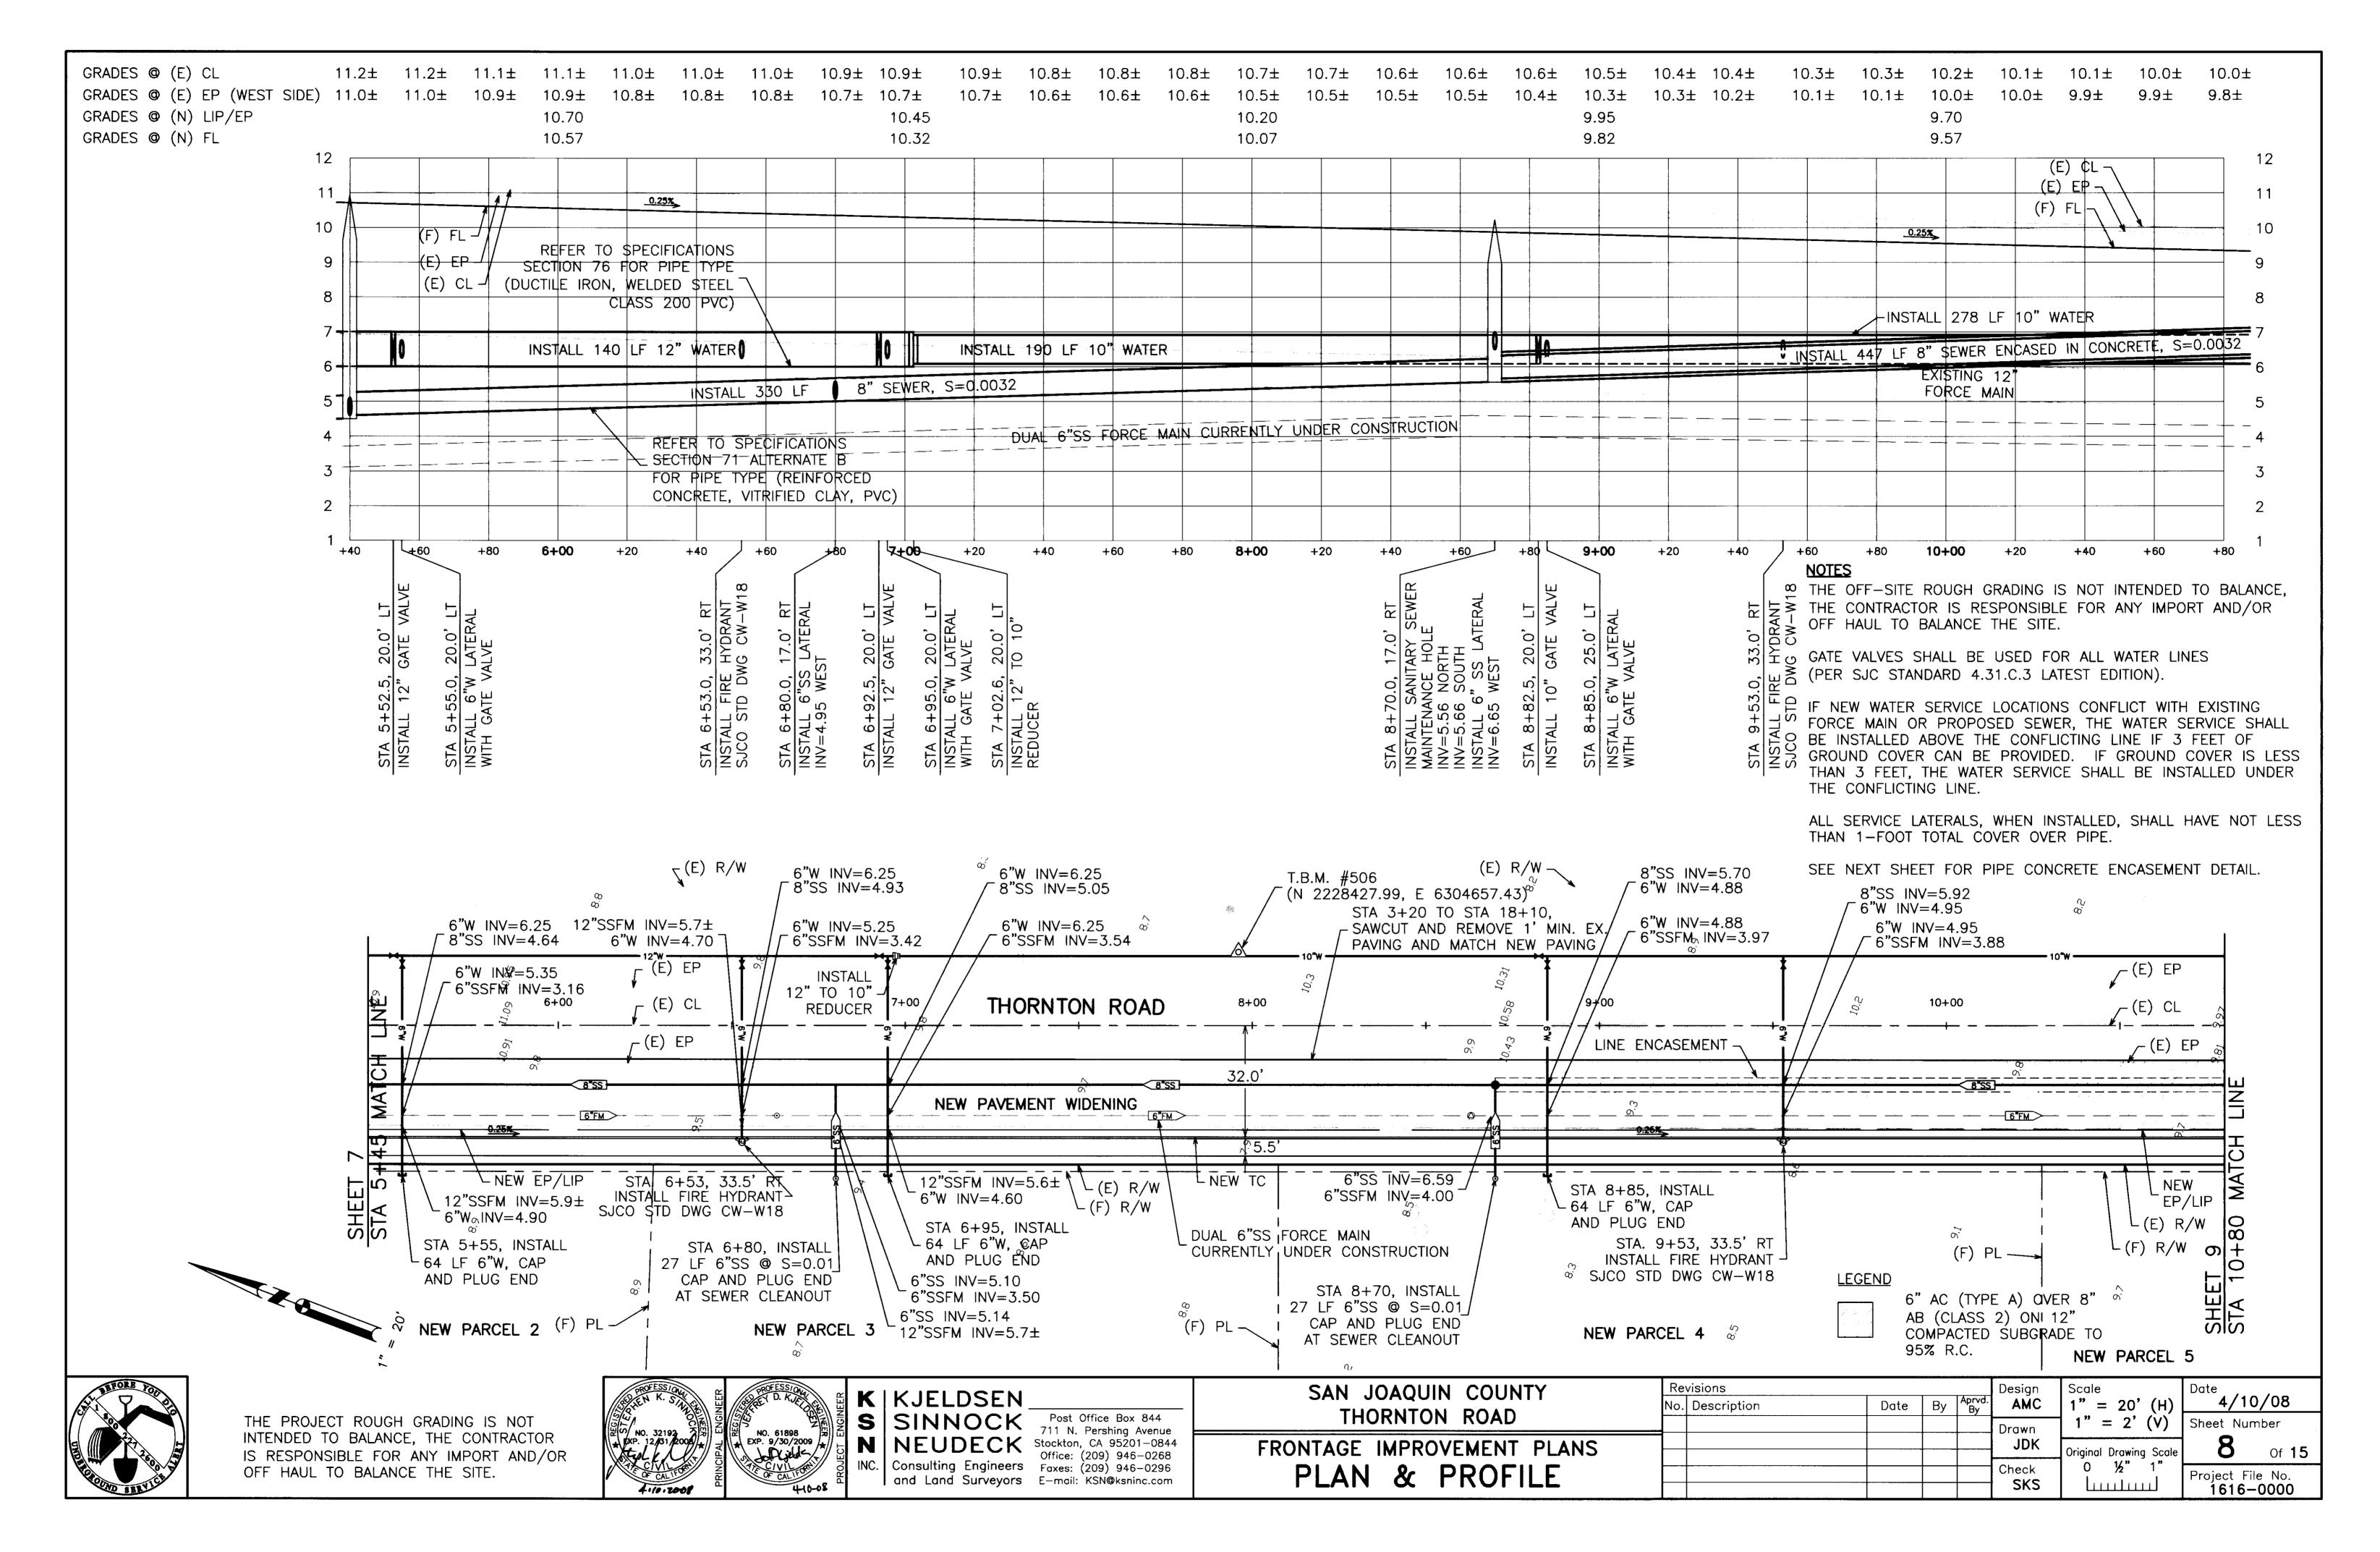

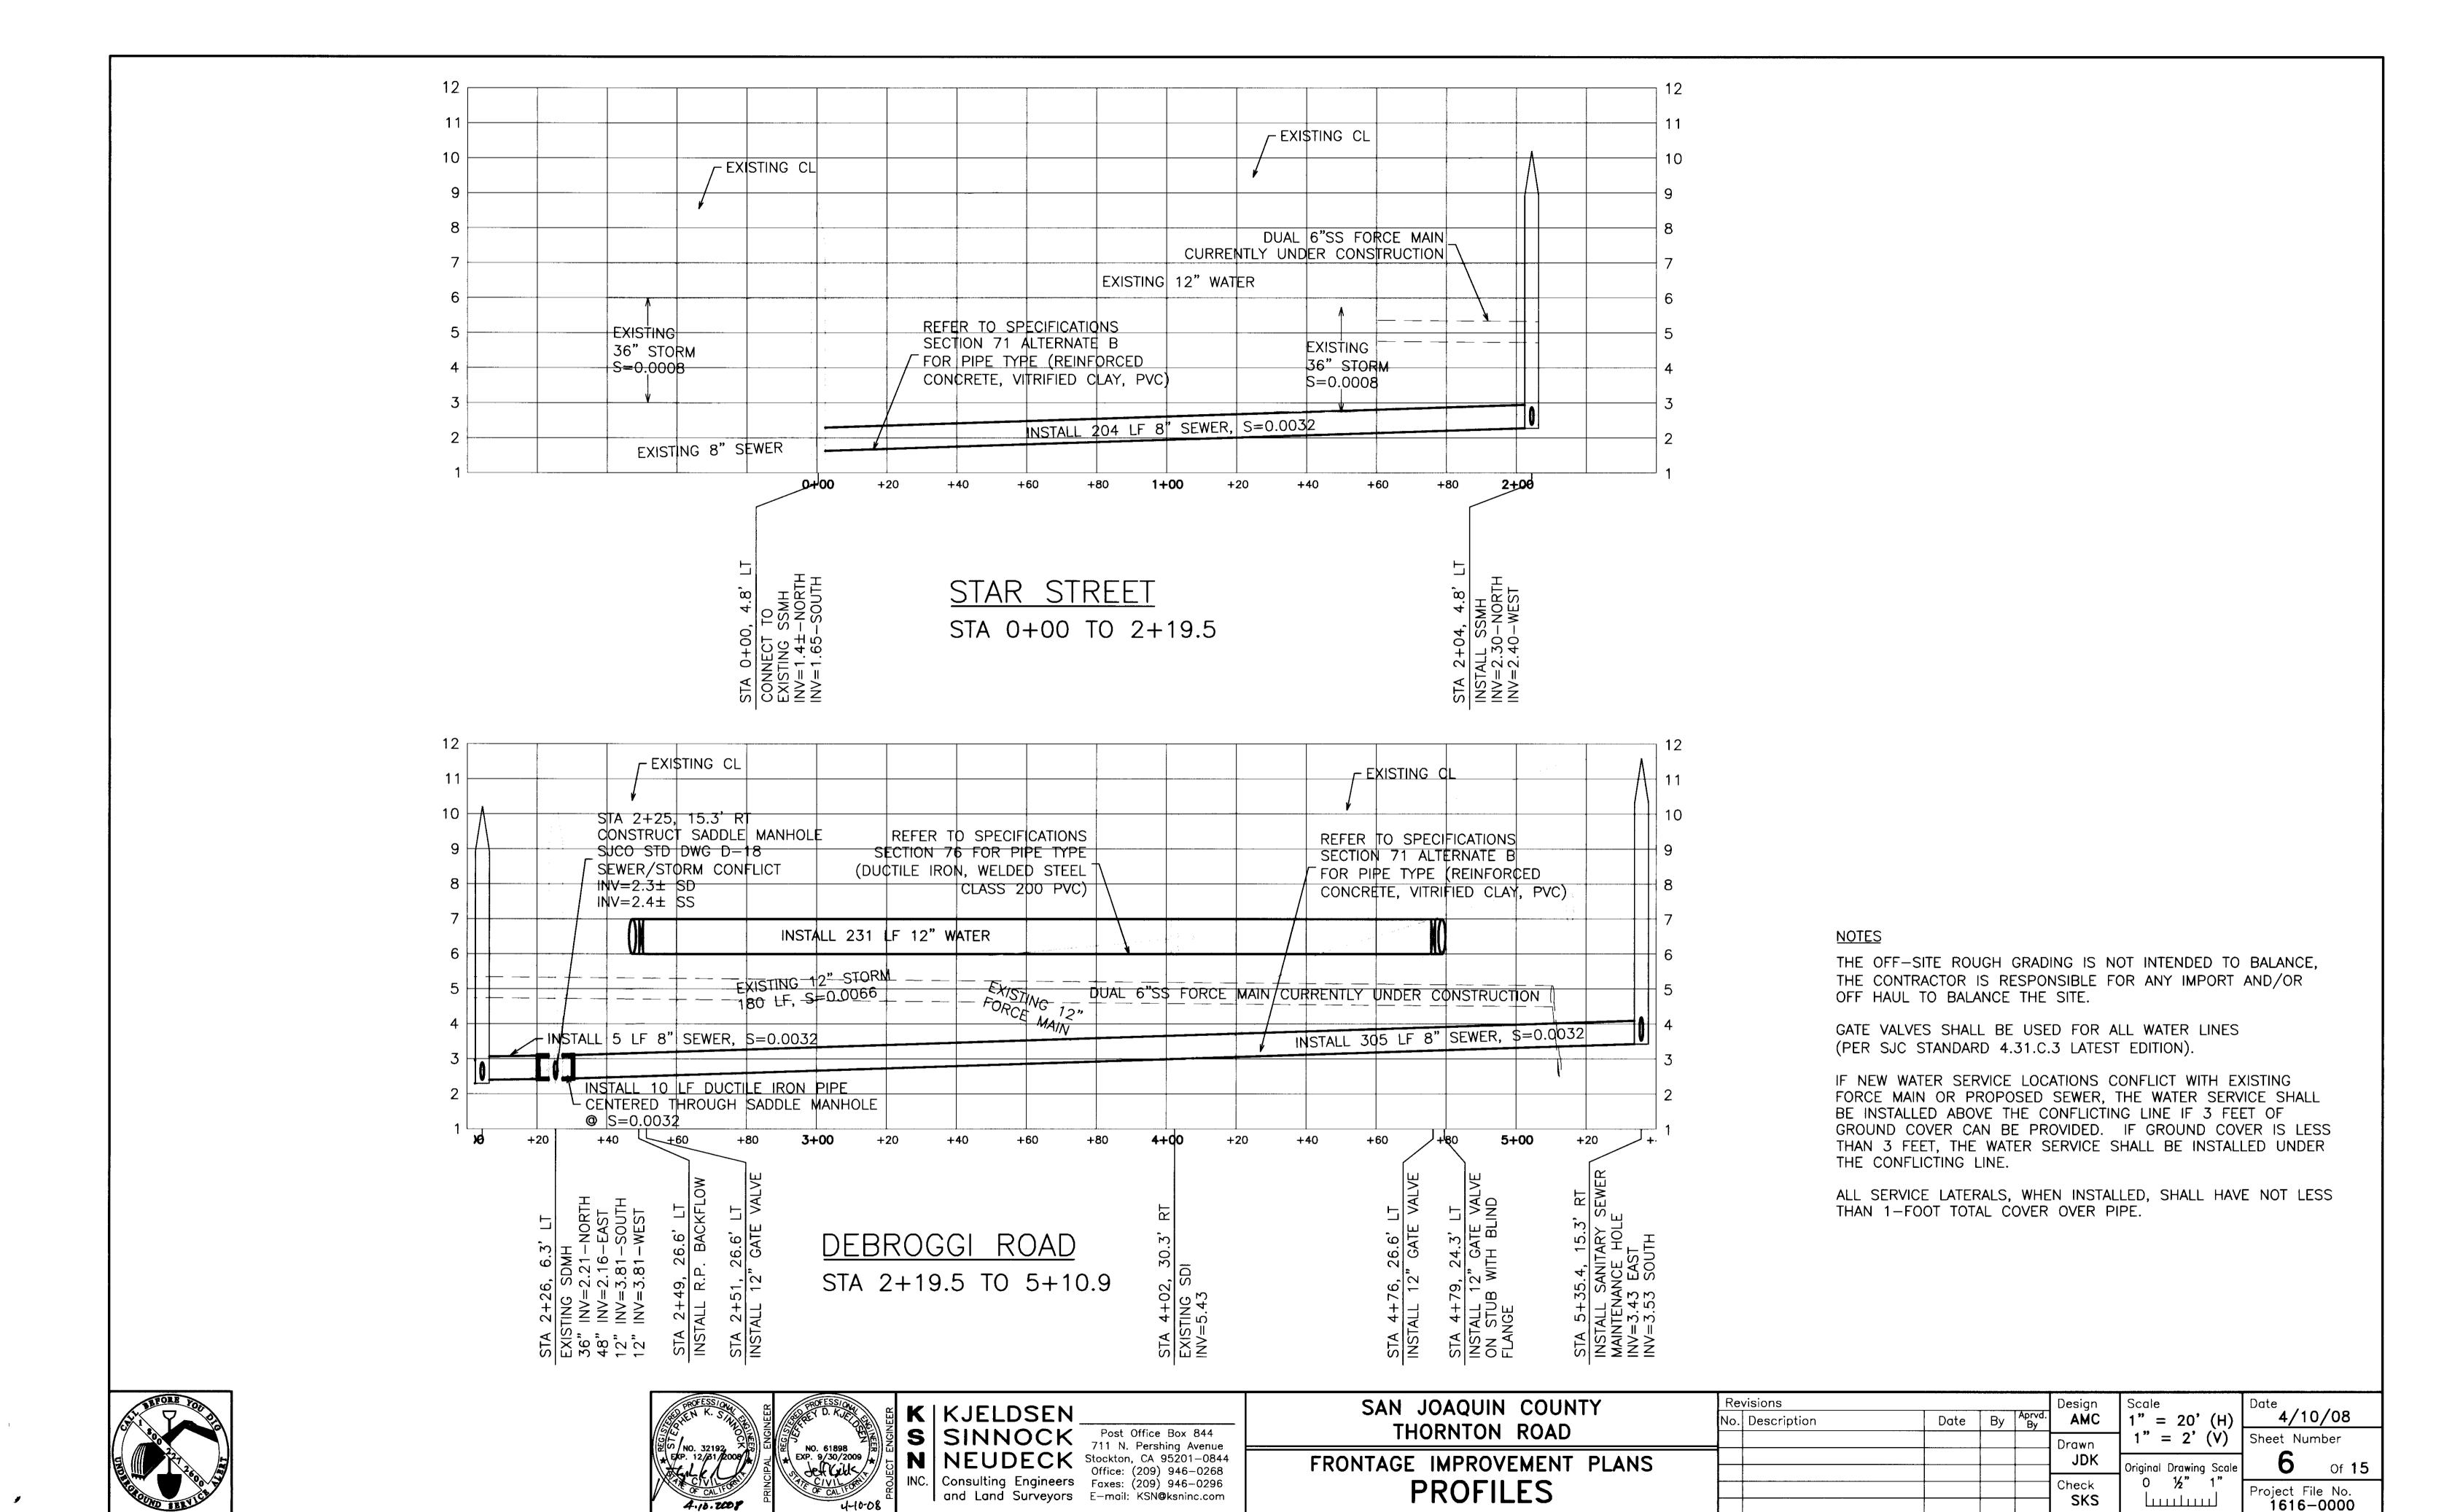


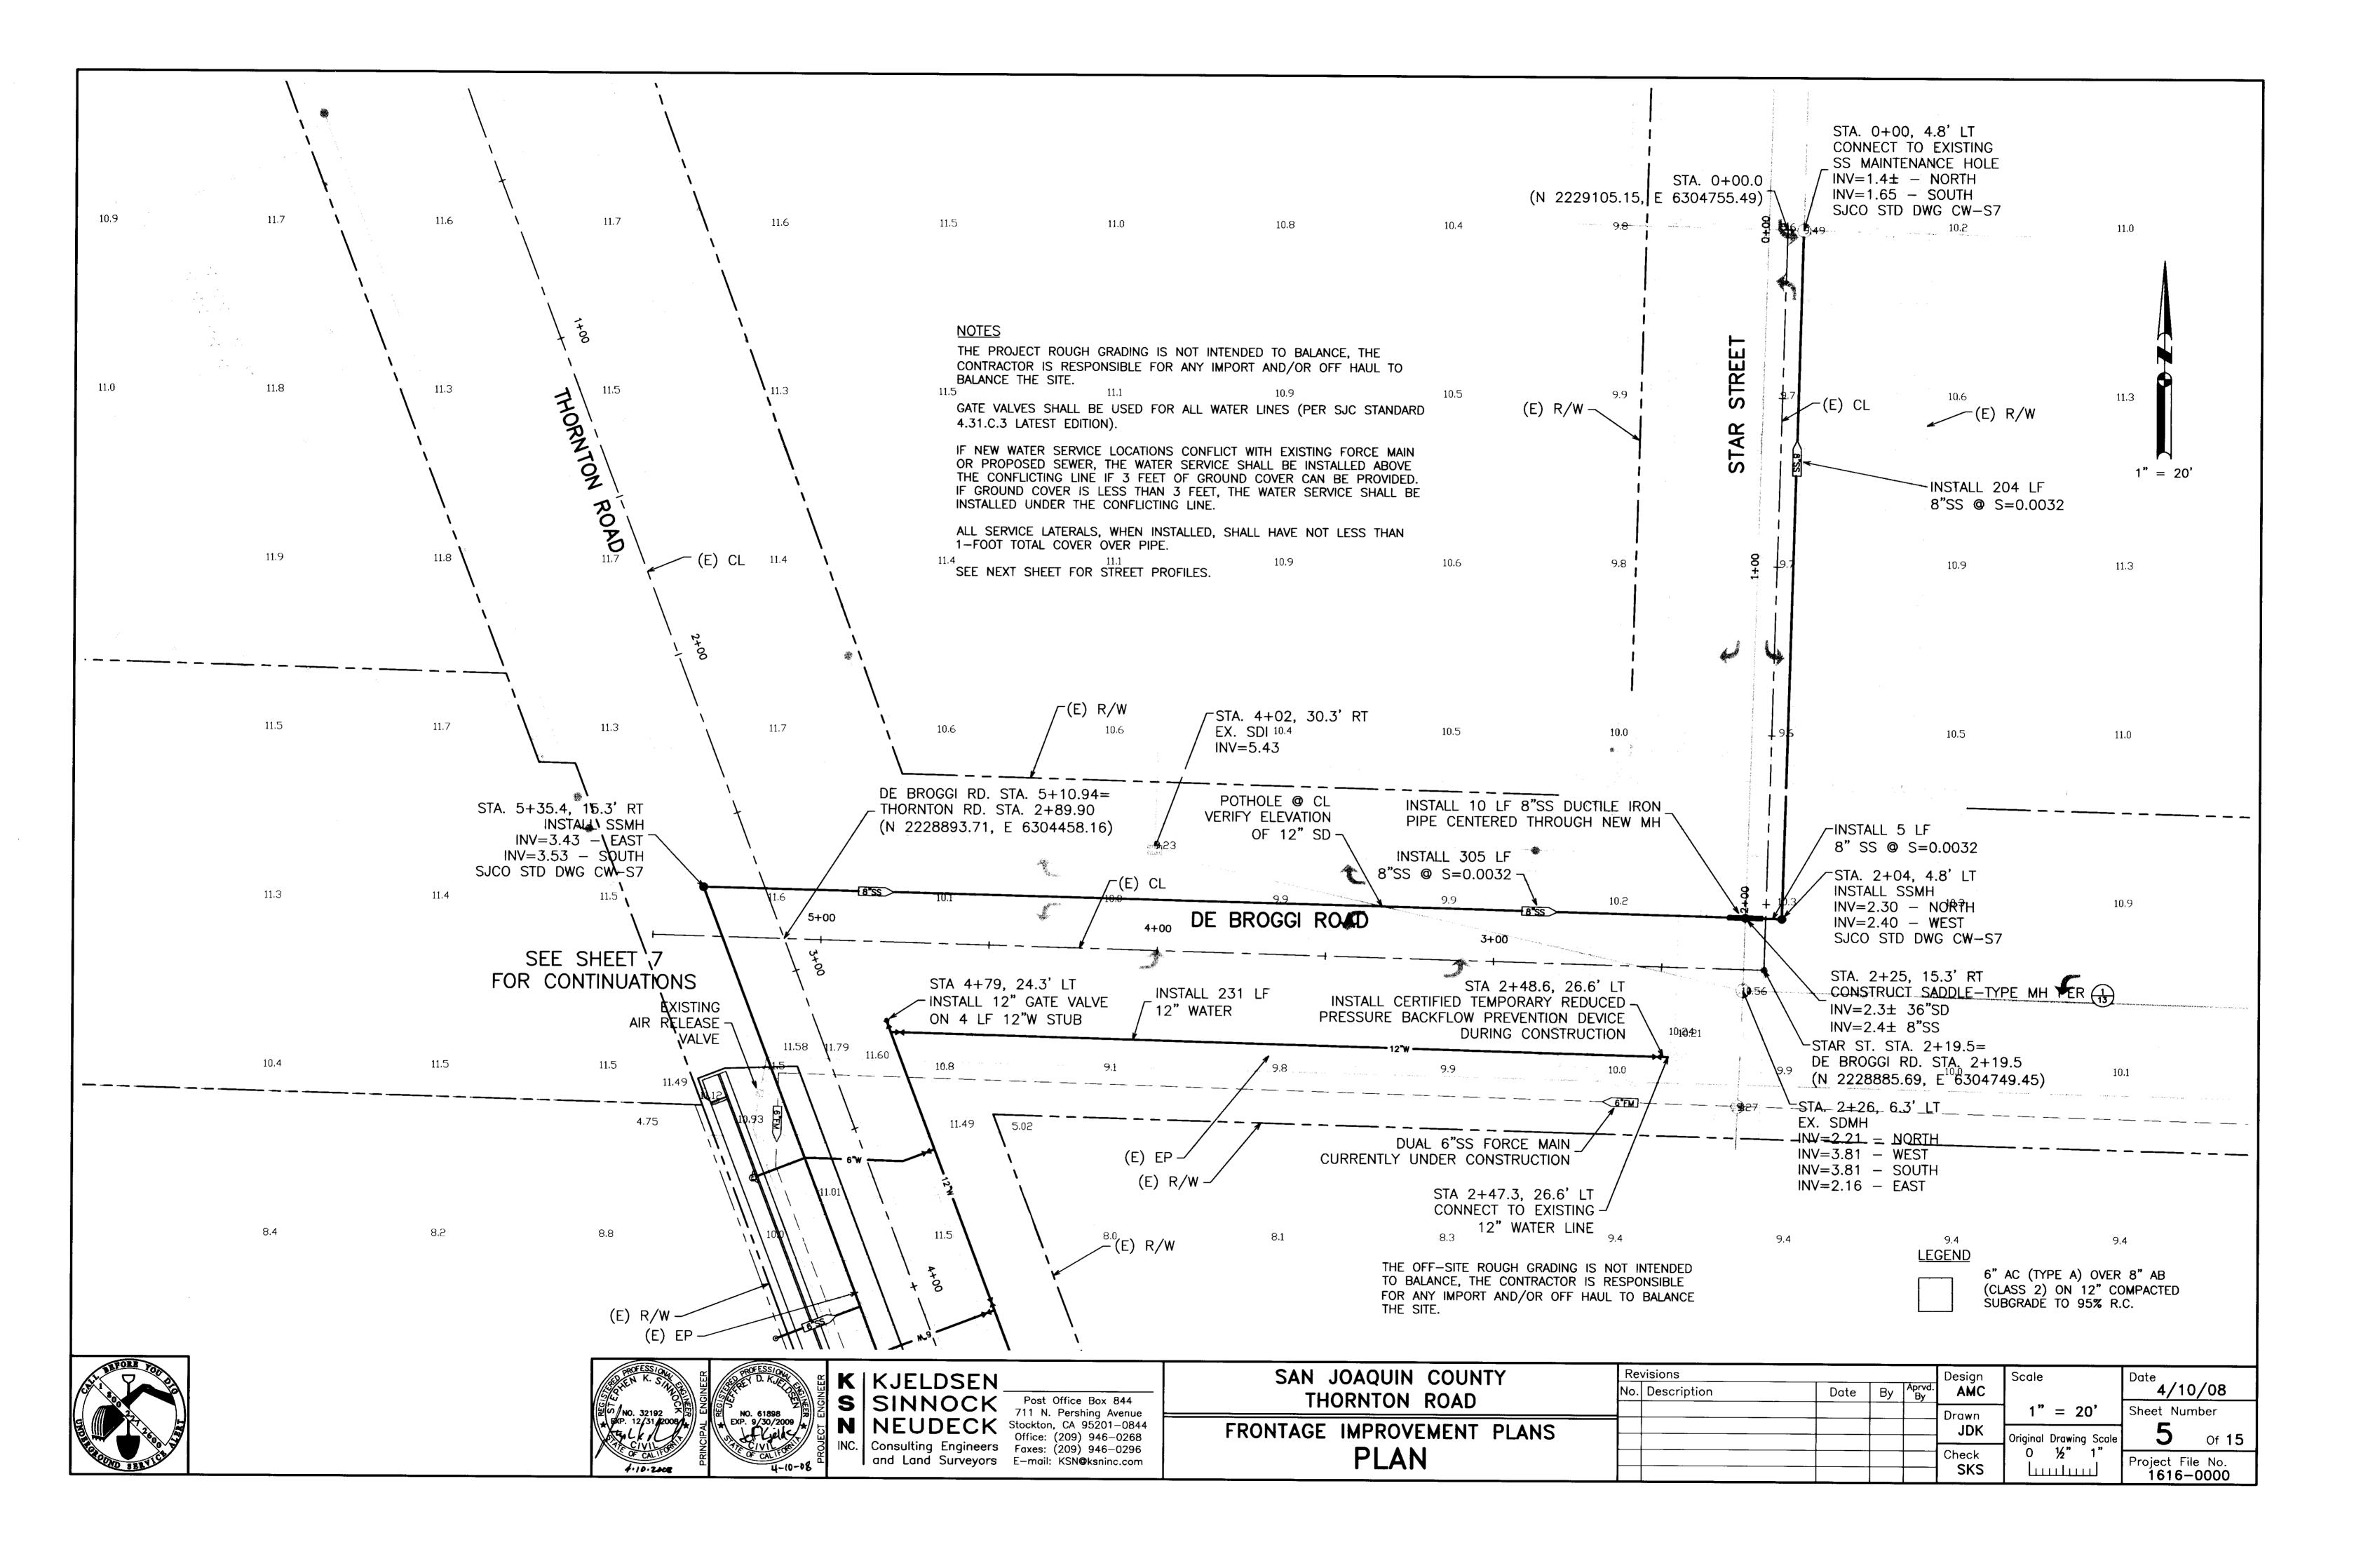

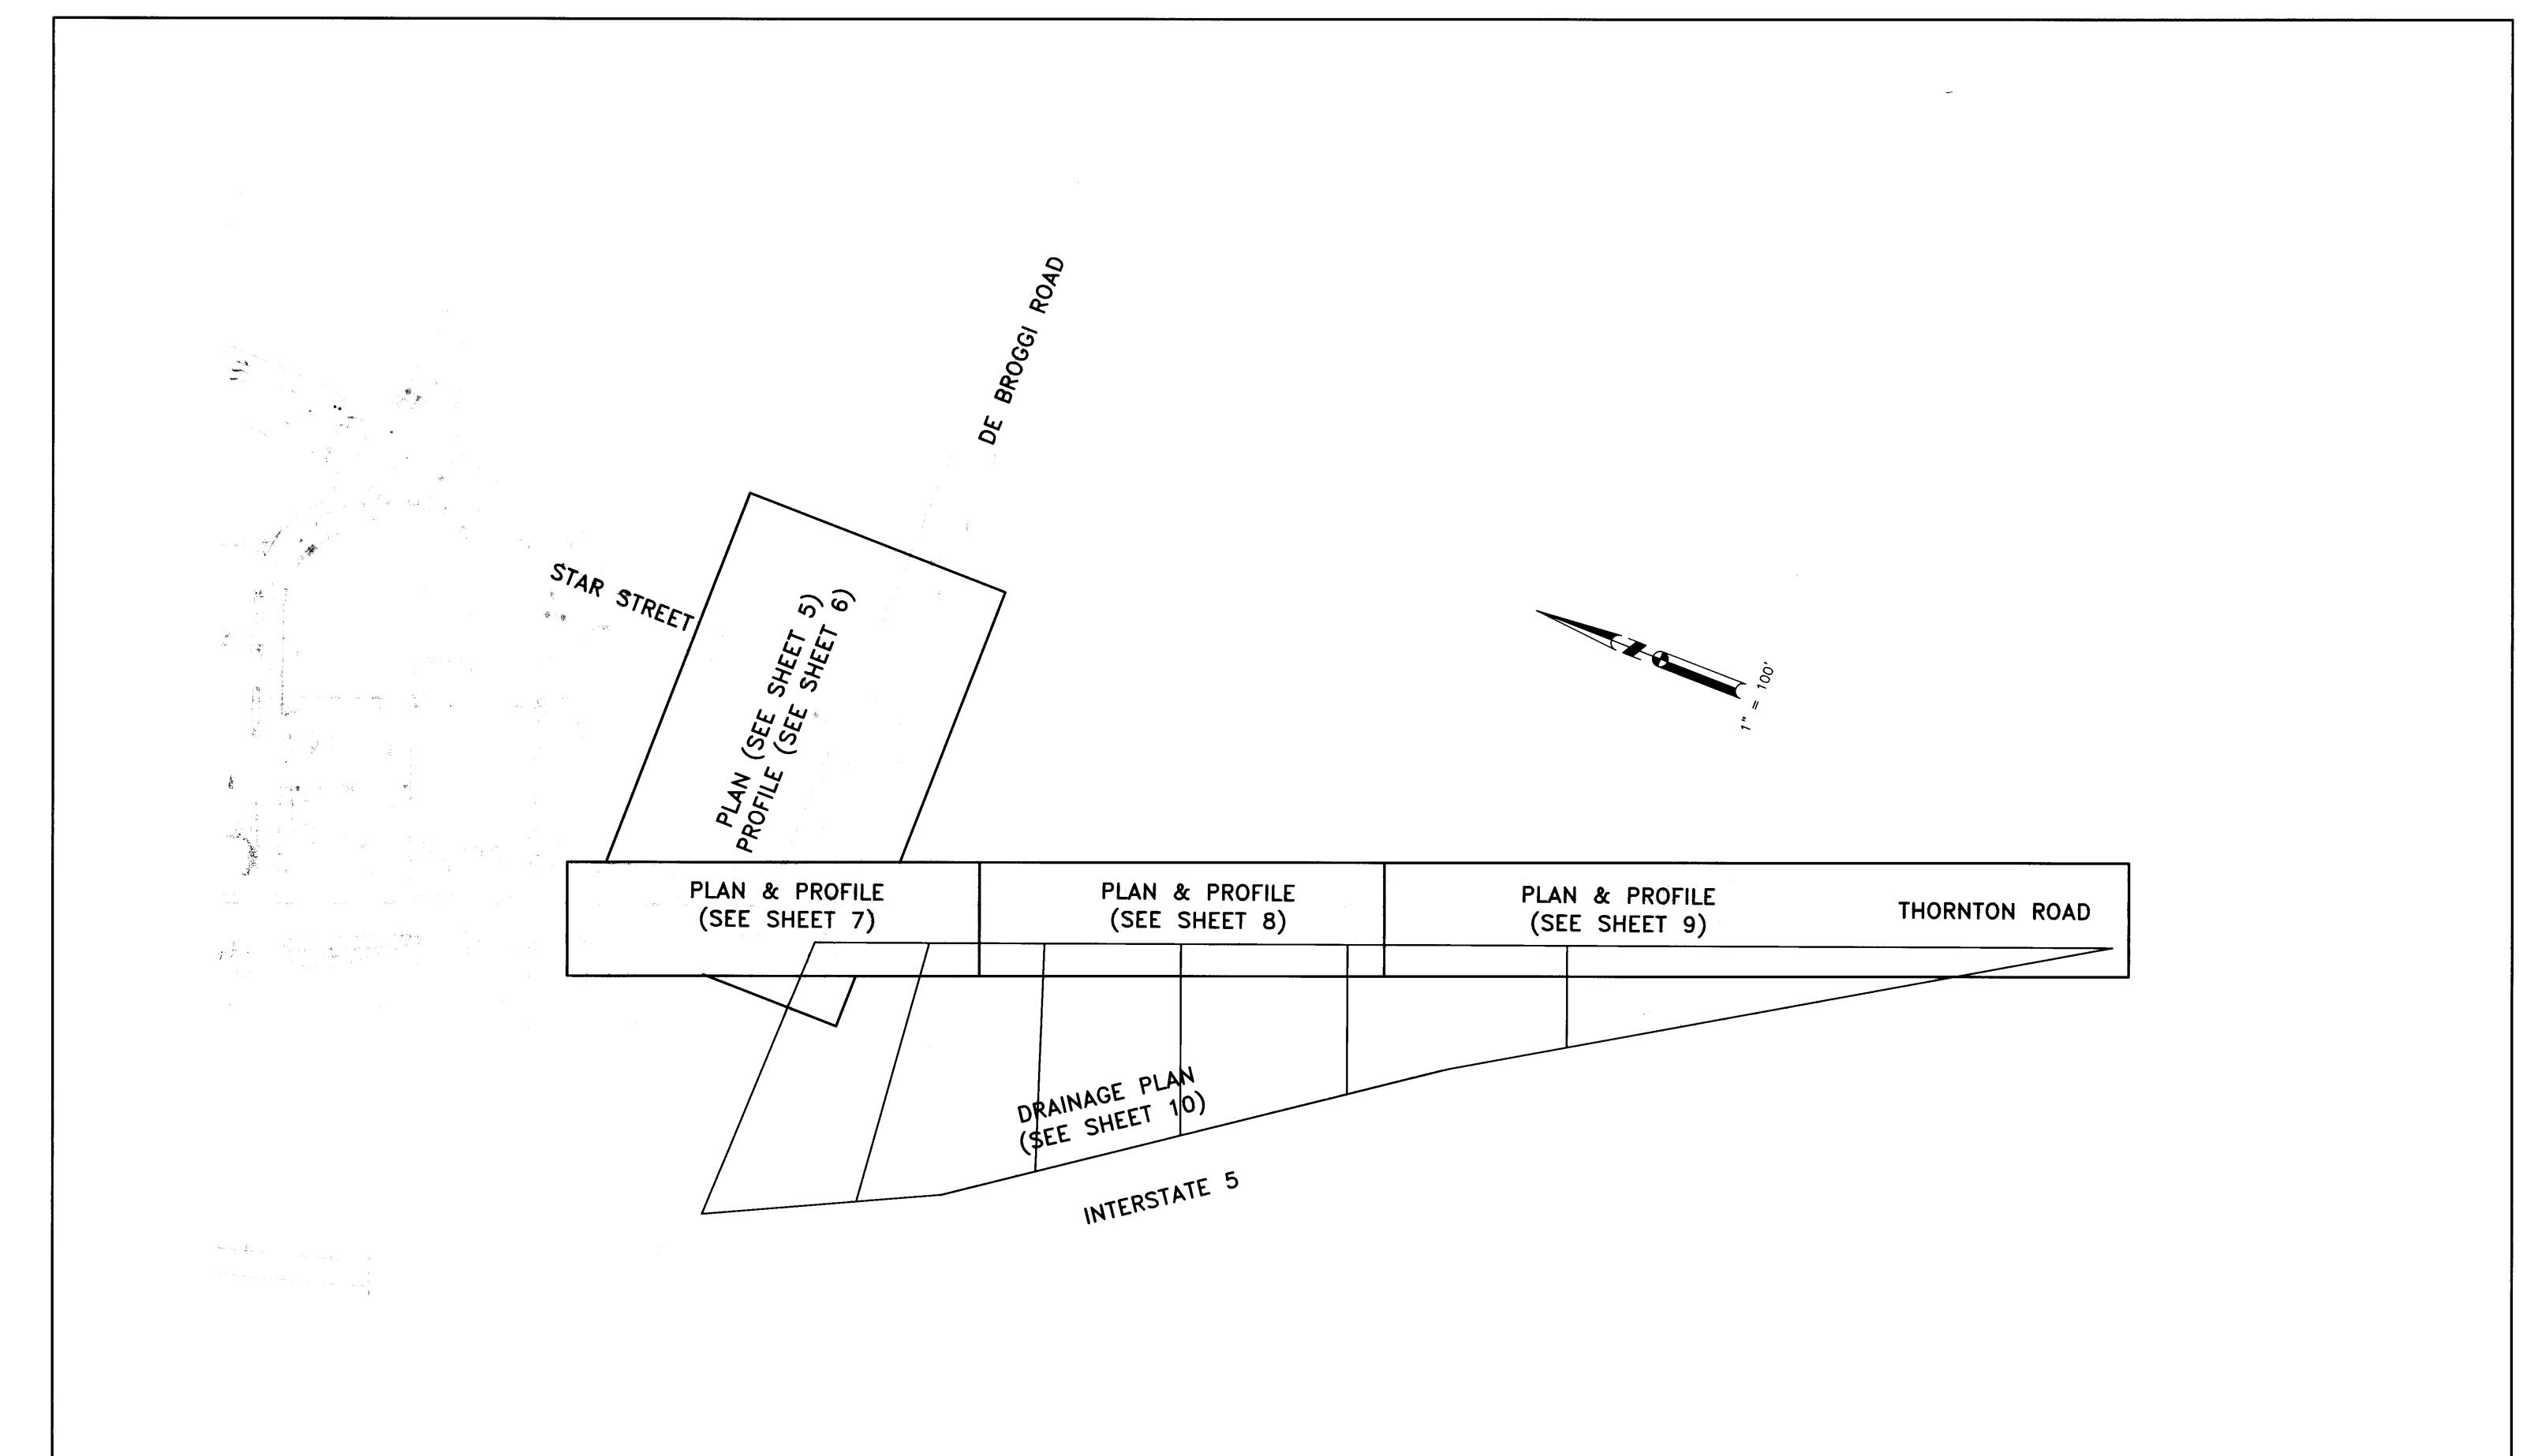



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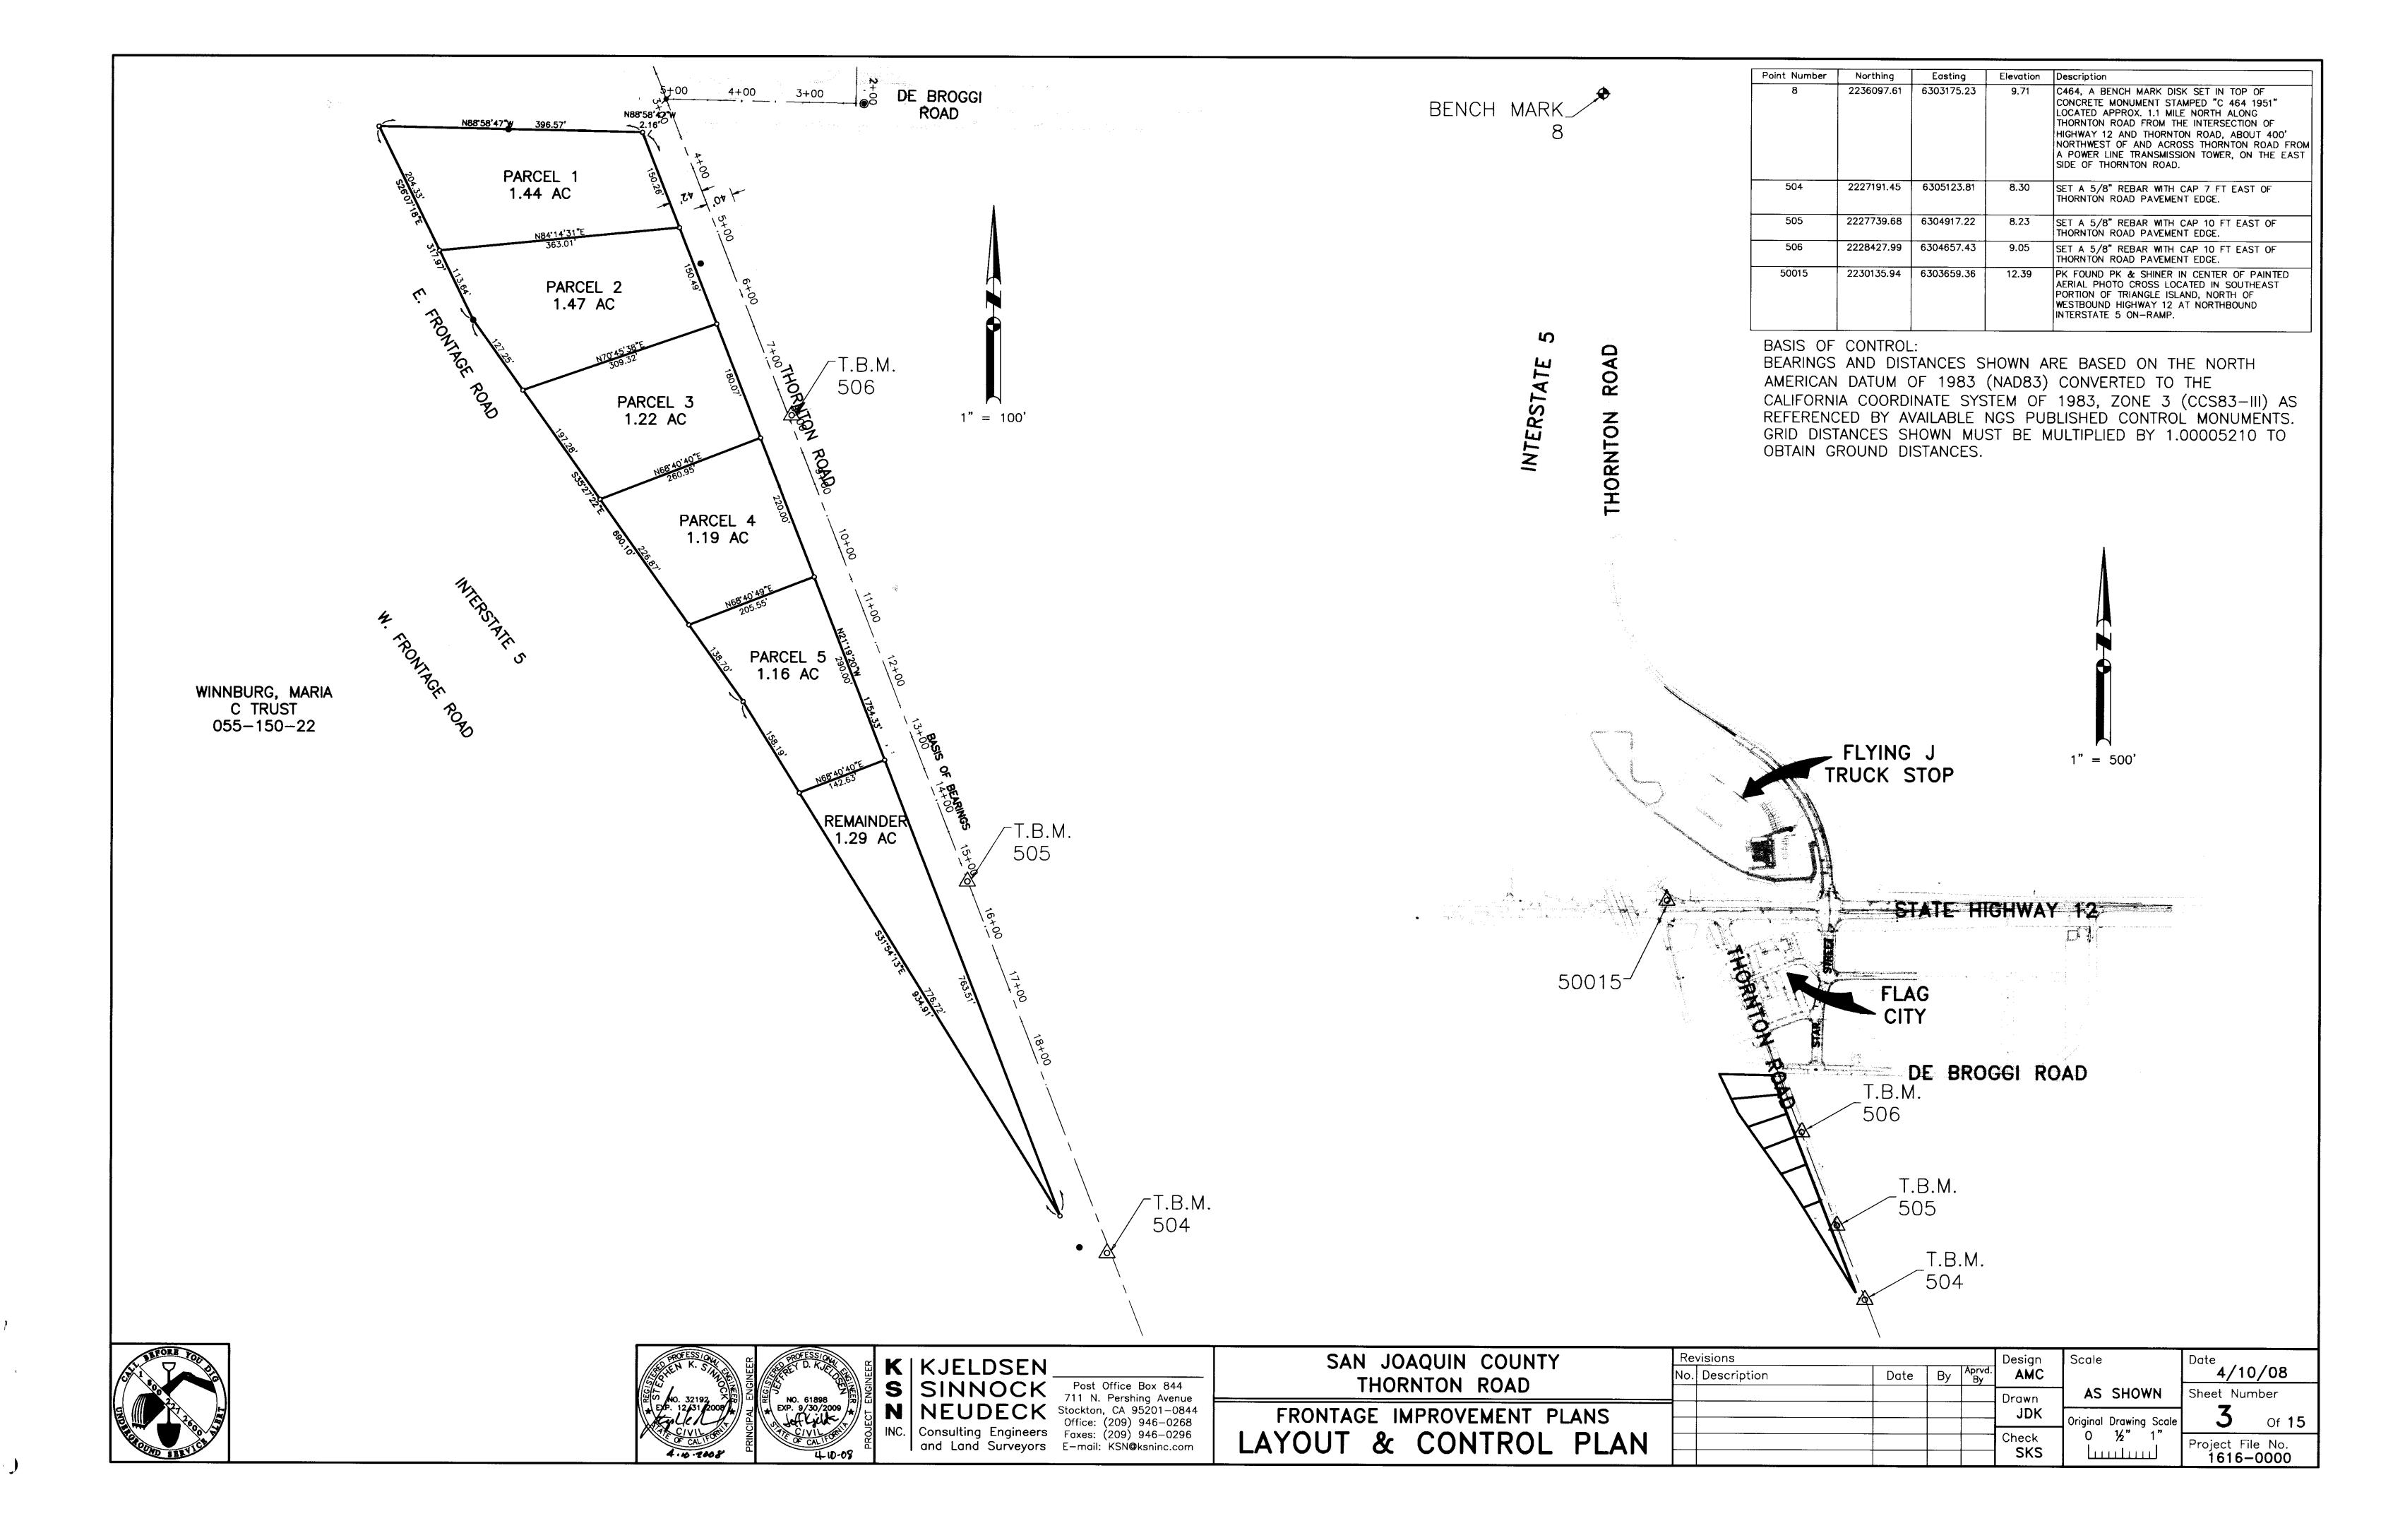
SINNOCK
SINNOCK
NEUDECK
Stockton, CA 95201-0844
Office: (209) 946-0268
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and Land Surveyors
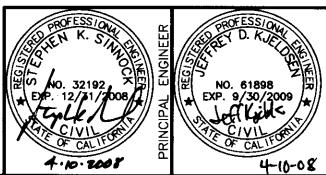
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SAN JOAQUIN COUNTY THORNTON ROAD FRONTAGE IMPROVEMENT PLANS KEY SHEET

Revisions
No. Description Design **AMC** Scale Date By Aprvd. 1" = 100' Original Drawing Scale
O ½" 1" Check SKS

Date **4/10/08** Sheet Number Project File No. 1616-0000



GENERAL NOTES (CIVIL):

- 1. ALL NEW IMPROVEMENTS SHALL BE IN ACCORDANCE WITH THE REQUIREMENTS OF THESE PLANS AND SPECIFICATIONS, AND THE LATEST EDITION OF SAN JOAQUIN COUNTY STANDARD SPECIFICATIONS AND PLANS AND THE 2006 STATE OF CALIFORNIA DEPARTMENT OF TRANSPORTATION STANDARD SPECIFICATIONS (WITH EXCEPTION THAT ENGLISH UNITS ARE TO BE USED IN PLACE OF METRIC)
- 2. THE INTENT IS THAT THESE PLANS REQUIRE ALL LABOR AND MATERIALS (EXCEPT AS SPECIFIED IN THE SPECIFICATIONS) NECESSARY AND PROPER FOR THE WORK CONTEMPLATED AND THAT THE WORK BE COMPLETED IN ACCORDANCE WITH THEIR TRUE INTENT AND PURPOSE. THE CONTRACTOR SHALL NOTIFY THE ENGINEER IMMEDIATELY REGARDING ANY DISCREPANCIES AND AMBIGUITIES WHICH MAY EXIST IN THE PLANS OR SPECIFICATIONS. IF THE PLANS DESCRIBE PORTIONS OF THE WORK IN GENERAL TERMS BUT NOT IN COMPLETE DETAIL, IT IS UNDERSTOOD THAT ONLY THE BEST GENERAL PRACTICE IS TO PREVAIL AND THAT ONLY MATERIALS AND WORKMANSHIP OF THE FIRST QUALITY ARE TO BE USED.
- 3. THE TYPES, LOCATION, SIZES AND/OR DEPTHS OF EXISTING UNDERGROUND UTILITIES AS SHOWN ON THESE PLANS WERE OBTAINED BY THE DESIGN ENGINEER FROM "OUTSIDE SOURCES," BELIEVED TO BE RELIABLE. HOWEVER, THE CONTRACTOR IS CAUTIONED THAT ONLY ACTUAL EXCAVATION WILL REVEAL THE TYPES, EXTENT, SIZES, LOCATION, AND DEPTHS OF SUCH UNDERGROUND UTILITIES. KJELDSEN, SINNOCK & NEUDECK ASSUMES NO RESPONSIBILITY FOR THE COMPLETENESS OR ACCURACY OF ITS DELINEATION OF SUCH UNDERGROUND UTILITIES WHICH MAY BE ENCOUNTERED BUT WHICH ARE NOT SHOWN ON THESE DRAWINGS.
- 4. THE CONTRACTOR SHALL BE RESPONSIBLE FOR VERIFYING THE LOCATION OF ALL EXISTING UNDERGROUND UTILITIES AND SHALL CONTACT THE RESPECTIVE UTILITY COMPANIES PRIOR TO COMMENCEMENT OF WORK. HE SHALL BE RESPONSIBLE FOR THE LOCATION AND PRESERVATION OF ALL SUCH FACILITIES IN THE AREA OF CONSTRUCTION, AND SHALL NOTIFY UTILITY COMPANIES TWENTY-FOUR HOURS IN ADVANCE OF ANY CONSTRUCTION (UNDERGROUND SERVICE ALERT 1-800-642-2444).
- 5. THE CONTRACTOR'S ATTENTION IS DIRECTED TO SECTION 1540 (A)(1) OF THE CONSTRUCTION SAFETY ORDERS (TITLE 8 CALIFORNIA ADMINISTRATION CODE SECTION 1540), ISSUED BY THE OCCUPATIONAL SAFETY AND HEALTH STANDARDS BOARD PURSUANT TO THE CALIFORNIA OCCUPATIONAL SAFETY AND HEALTH ACT OF 1973, AS AMENDED, WHICH STATES: PRIOR TO OPENING AN EXCAVATION, EFFORT SHALL BE MADE TO DETERMINE WHETHER UNDERGROUND INSTALLATION: I.E., SEWER, WATER, FUEL, ELECTRIC LINES, ETC.. WILL BE ENCOUNTERED AND, IF SO, WHERE SUCH UNDERGROUND INSTALLATIONS ARE LOCATED. WHEN THE EXCAVATION APPROACHES THE APPROXIMATE LOCATION OF SUCH AN INSTALLATION, THE EXACT LOCATION SHALL BE DETERMINED BY CAREFUL PROBING OR AND DIGGING; AND WHEN IT IS UNCOVERED, ADEQUATE PROTECTION SHALL BE PROVIDED FOR THE EXISTING INSTALLATION. ALL KNOWN OWNERS OF UNDERGROUND FACILITIES IN THE AREA CONCERNED SHALL BE ADVISED OF PROPOSED WORK AT LEAST 48 HOURS PRIOR TO THE START OF ACTUAL EXCAVATION.
- 6. THE CONTRACTOR SHALL PROVIDE SHORING, BRACING, SLOPING OR PROVISIONS TO PROTECT WORKMEN FOR ALL AREAS TO BE EXCAVATED TO A DEPTH OF FIVE FEET OR MORE. SAID PROTECTION TO BE DONE IN ACCORDANCE WITH THE REQUIREMENTS OF LOCAL, STATE, AND FEDERAL REGULATIONS (CAL-OSHA, OSHA).
- 7. CONTRACTOR SHALL BE RESPONSIBLE FOR COORDINATION OF THE REMOVAL AND/OR RELOCATION OF ALL EXISTING UTILITIES WITH RESPECTIVE UTILITY
- 8. FINAL PAVEMENT WORK SHALL NOT OCCUR WITHIN THE ROAD RIGHT-OF-WAY PRIOR TO COMPLETION OF UTILITY RELOCATION WITHOUT SPECIFIC APPROVAL OF THE SAN JOAQUIN COUNTY PUBLIC WORKS DEPARTMENT.
- 9. ALL TRENCHES AND CROSS TRENCHES WITHIN EXISTING STREETS SHALL BE BACK FILLED AND PAVED WITH TEMPORARY PAVING THE SAME DAY THE PAVEMENT CUT IS MADE OR COVERED WITH STEEL PLATES AS DIRECTED BY SAN JOAQUIN COUNTY PUBLIC WORKS DEPARTMENT.
- 10. ASBESTOS CEMENT MATERIALS SHALL NOT BE USED IN THE CONSTRUCTION OF ANY FACILITIES WITHIN THIS PROJECT.
- 11. THE CONTRACTOR SHALL EXPOSE ALL EXISTING SEWERS, STORM DRAINS. AND CLEARANCES OF KNOWN CROSSINGS WITH OTHER UTILITIES BEFORE INSTALLING NEW PIPELINES. IF THE CONTRACTOR DETERMINES THE EXISTING INVERTS ARE NOT IN CONFORMANCE WITH THE PLANS, HE SHALL NOTIFY THE ENGINEER BEFORE PERFORMING ANY WORK.
- 12. PRIOR TO PLACEMENT OF ANY FINISH ASPHALT CONCRETE OR CONCRETE. THE CONTRACTOR SHALL VERIFY ALL FINISH GRADES AND SLOPES FOR COMPLIANCE WITH THE AMERICANS WITH DISABILITIES ACT (ADA).
- 13. THE CONTRACTOR SHALL BE RESPONSIBLE FOR ANY FIELD CHANGES MADE WITHOUT WRITTEN AUTHORIZATION FROM THE OWNER REPRESENTATIVE.
- 14. THE CONTRACTOR SHALL BE RESPONSIBLE FOR ANY DAMAGE TO THE SITE AND SURROUNDING AREAS RESULTING FROM OPERATIONS PRIOR TO ACCEPTANCE OF HIS WORK.
- 15. DURING CONSTRUCTION THE CONTRACTOR SHALL MAINTAIN THE INTEGRITY OF EXISTING FACILITIES. THE CONTRACTOR IS RESPONSIBLE TO REPAIR, TO THE SATISFACTION OF SAN JOAQUIN COUNTY, ANY FACILITIES DAMAGED DURING CONSTRUCTION AT NO COST TO THE OWNER.
- 15. A TRAFFIC CONTROL PLAN (TCP) SHALL BE SUBMITTED TO AND DEEMED ACCEPTABLE BY COUNTY PRIOR TO START OF WORK. THIS SHALL ADDRESS ALL PHASES OF WORK WHICH IMPACT PUBLIC TRAFFIC. CONFORMANCE WITH THE TCP SHALL BE MAINTAINED AT ALL TIMES. A MINIMUM OF ONE 10' TRAFFIC LANE SHALL BE MAINTAINED AT ALL TIMES, WITH TRAFFIC DELAYS LIMITED TO A MAXIMUM OF 15 MINUTES. A MINIMUM OF TWO 10' TRAFFIC LANES SHALL BE MAINTAINED DURING NON-WORKING HOURS. TRAFFIC CONTROL SHALL BE IN ACCORDANCE WITH SECTION 12 OF THE CALTRANS STANDARD SPECIFICATIONS. ALL PAVEMENT CUTS SHALL BE NEATLY LINE CUT. PAVEMENT RESTORAL FOR LONGITUDINAL TRENCHES SHALL NOT RESULT IN A "COLD JOINT" WITHIN THREE FEET OF AN EXISTING EDGE OF PAVEMENT (i.e. NO "RIBBON PATCHES")
- 16. CONTRACTOR TO REFERENCE AND RESTORE ALL "RECORDED" EXISTING MONUMENTS AND/OR PROPERTY CORNER REFERENCES DESTROYED. REMOVED OR DISTURBED DURING THE COURSE OF CONSTRUCTION.

- 16. CONTRACTOR TO REFERENCE AND RESTORE ALL "RECORDED" EXISTING MONUMENTS AND/OR PROPERTY CORNER REFERENCES DESTROYED, REMOVED OR DISTURBED DURING THE COURSE OF CONSTRUCTION.
- 17. WHERE EXISTING FENCES ARE TO BE REMOVED FOR CONSTRUCTION PURPOSES CONTRACTOR SHALL REMOVE AND REPLACE THE FENCING IN KIND. WHERE THE EXISTING FENCE IS USED FOR PROPERTY SECURITY AND/OR CONTAINMENT, CONTRACTOR SHALL ERECT TEMPORARY FENCING DURING (NOT SHOWN ON PLANS) CONSTRUCTION AS DIRECTED BY THE OWNER'S REPRESENTATIVE.
- 18. ALL WORK IN COUNTY RIGHT-OF-WAY SUBJECT TO THE APPROVAL AND ACCEPTANCE OF SAN JOAQUIN COUNTY PUBLIC WORKS DEPARTMENT.
- 19. CONTRACTOR AGREES TO ASSUME SOLE AND COMPLETE RESPONSIBILITY FOR JOBSITE CONDITIONS DURING THE COURSE OF CONSTRUCTION OF THIS PROJECT, INCLUDING SAFETY OF ALL PERSONS AND PROPERTY; THIS REQUIREMENT SHALL APPLY CONTINUOSLY AND NOT TO BE LIMITED TO NORMAL WORKING HOURS; AND THAT THE CONTRACTOR SHALL DEFEND, INDEMNIFY AND HOLD HARMLESS, THE COUNTY OF SAN JOAQUIN. ITS ELECTED OFFICIALS, OFFICERS, EMPLOYEES, AND AGENTS FROM ANY AND ALL CLAIMS, COSTS OF LITIGATION, DAMAGES, AND ATTORNEY'S FEES, FOR PERSONAL INJURY OR PROPERTY DAMAGE OF WHATEVER NATURE WHICH ARE CLAIMED TO HAVE OCCURED DURING THE TERM OF THIS PROJECT.
- 20. TRAFFIC SIGNS AND MARKINGS SHALL CONFORM TO THE LATEST EDITION OF THE MANUAL ON UNIFORM TRAFFIC CONTROL DEVICES, MUTCD, AND CALIFORNIA SUPPLEMENT TO MUTCD AND SAN JOAQUIN COUNTY STANDARDS AND AS SHOWN ON THE PLANS.
- 21. EXISTING TOPOGRAPHIC INFORMATION SHOWN MAY DIFFER FROM ACTUAL CONDITIONS DUE TO ONGOING CONSTRUCTION IN THE AREA.
- 22. CONTRACTOR SHALL PROVIDE DUST CONTROL MEASURES AT ALL TIMES DURING CONSTRUCTION AS PER SECTION 10 OF THE STANDARD SPECIFICATIONS OF THE STATE OF CALIFORNIA AND PER SAN JOAQUIN COUNTY DEPARTMENT OF PUBLIC WORKS REQUIREMENTS.
- 23. ANY CHANGES TO THE APPROVED IMPROVEMENT PLANS AND SPECIFICATIONS MUST BE PREPARED AND CERTIFIED BY THE "CIVIL ENGINEER", AND SHALL BE SUBMITTED TO THE DIRECTOR OF PUBLIC WORKS FOR APPROVAL PRIOR TO IMPLEMENTATION.

CONSTRUCTION NOTES:

- 1. THE CONTRACTOR SHALL LAYOUT IMPROVEMENTS FROM THE DIMENSIONS SHOWN ON THE PLANS. ANY CLARIFICATION ON CONFLICTS, DISCREPANCIES OR AMBIGUITIES SHOULD BE DIRECTED TO THE DESIGN ENGINEER PRIOR TO THE CONSTRUCTION OF THE IMPROVEMENTS.
- 2. THE CONTRACTOR SHALL BE RESPONSIBLE FOR MATCHING EXISTING SURROUNDING LANDSCAPE AND OTHER IMPROVEMENTS WITH A TRANSITION IN PAVING, CURBS, GUTTERS. SIDEWALKS, GRADES, ETC., AND TO AVOID ANY ABRUPT OR APPARENT CHANGES IN CROSS SLOPES, LOW SPOTS OR HAZARDOUS CONDITIONS.
- 3. WHERE PAVEMENT IS TO BE EXTENDED, EXISTING PAVEMENT SHALL BE
- 4. ALL NEW CONCRETE FLATWORK SHALL BE DRILLED AND DOWELED AND/OR KEYED INTO EXISTING FLATWORK IN ACCORDANCE WITH SAN JOAQUIN COUNTY STANDARD PLANS AND SPECIFICATIONS.
- 5. THE CONTRACTOR SHALL PROVIDE AND MAINTAIN TEMPORARY SIGNS FOR ALL REGULATORY TRAFFIC SIGN REMOVED DURING THE CONSTRUCTION.
- 6. ALL GRADING AND EARTHWORK TO BE DONE SHALL COMPLY WITH 2001 U.B.C. CHAPTER 18 AND APPENDIX CHAPTER 33.
- 7. CUT/FILL SLOPES SHALL BE NO STEEPER THAN TWO HORIZONTAL TO ONE
- 8. THE PROJECT ROUGH GRADING IS NOT INTENDED TO BALANCE, THE CONTRACTOR IS RESPONSIBLE FOR ANY IMPORT AND/OR OFF HAUL TO BALANCE THE SITE.
- 9. DRAINAGE FACILITIES SHALL BE MAINTAINED DURING PERIODS OF INCLEMENT WEATHER, AND RESTORED TO THEIR ORIGINAL CONDITIONS UPON COMPLETION OF THE WORK.
- 10. ALL TRAFFIC DELINEATIONS (SIGNS, STRIPING, RAISED PAVEMENT MARKERS) SHALL BE RESTORED TO THEIR ORIGINAL CONDITION UPON COMPLETION OF THE WORK.
- 11. THE CONTRACTOR SHALL NOTIFY THE SAN JOAQUIN COUNTY DEPARTMENT OF PUBLIC WORKS 24 HOURS IN ADVANCE OF PERFORMING ANY WORK REQUIRED IN THE PLANS. PHONE: (209) 468-3022.
- 12. EXCAVATION OF 5-FEET OR GREATER IN DEPTH REQUIRES AN EXCAVATION PERMIT FROM THE STATE OF CALIFORNIA DEPARTMENT OF INDUSTRIAL
- 13. WHENEVER PAVEMENT IS BROKEN OR CUT IN THE INSTALLATION OF THE WORK COVERED BY THE SPECIFICATIONS, THE PAVEMENT SHALL BE REPLACED AFTER PROPER BACKFILLING WITH PAVEMENT MATERIALS EQUAL TO OR BETTER THAN THE MATERIALS USED IN THE ORIGINAL PAVING.
- 14. NO EARTHEN GRADES OR SLOPES SHALL BE STEEPER THAN 2 HORIZONTAL TO 1 VERTICAL.


EROSION AND SEDIMENT CONTROL NOTES:


- 1. A STATE NATIONAL POLLUTANT DISCHARGE ELIMINATION SYSTEM (NPDES) CONSTRUCTION PERMIT NOTICE OF INTENT (NOI) SHALL BE FILED WITH THE STATE WATER RESOURCES CONTROL BOARD.
- 2. IMPLEMENTATION OF THE RECOMMENDED EROSION CONTROL MEASURES AS SHOWN ON THESE PLANS DOES NOT ENSURE COMPLIANCE WITH FEDERAL, STATE AND LOCAL LAWS, REGULATIONS AND ORDINANCES. THE BURDEN OF COMPLIANCE RESTS SOLELY WITH THE OWNER AND DEVELOPER OF THE


			İ			
NEW	EXISTING	DESCRIPTION	AB AC	ANCHOR BOLT/AGGREGATE BASE ASPHALTIC CONCRETE	JP	JOINT POLE
	****	DROP INLET			KV	KILOVOLT
<u> </u>	— •	CATCH BASIN	BC BC	BEGINNING OF CURVE		
•	8	AGRICULTURAL IRRIGATION VALVES	BM	BENCH MARK	LF.	LINEAL FEET
•	o	STORM DRAIN MANHOLE	BOC BOW/BW	BACK OF CURB BACK OF WALK	LIN	LINEAR
•	0	ROOF DRAIN	50m/5m	DACK OF WALK	LP	LOW POINT
•			C8	CATCH BASIN	MAX	MAXIMUM
	0	STAND PIPES	, c	CENTER TO CENTER	MB	MACHINE BOLT
0	•	OLEANOLT.	CIP	CAST IRON PIPE	MH	MAINTENANCE HOLE
⊙	©	CLEANOUT) a	CENTERLINE	MIN	MINIMUM
•	S	SANITARY SEWER MANHOLE	CMP	CORRUGATED METAL PIPE	MON	MONUMENT
	_		CMU	CONCRETE MASONRY UNIT	44	
●	®	WATER METER	CONC	CONCRETE	(N) NIC	NEW
•	٥	BLOWOFF VALVE	CR	CONTINUOUS CURB RETURN	NTS	NOT IN CONTRACT
→	Þ	FIRE HYDRANT ASSEMBLY	CTR	CENTER	МІЭ	NOT TO SCALE
Ħ	M	WATER VALVE	l cr	CUBIC YARD	oc	ON CENTER
Å.		POST INDICATOR VALVE	1		õõ	OUTSIDE DIAMETER
€;	\$	FIRE DEPARTMENT CONNECTION	D	STORM DRAIN	ÖĞ	ORIGINAL GROUND
	8	IRRIGATION CONTROL VALVE	DI	DROP INLET		
	•	PRESSURE VACUUM BREAKER	DIA	DIAMETER	PAV	PAVEMENT
	8	BACKFLOW PREVENTER	DIM DW	DIMENSION	PB	PULL BOX
			· · · · · · · · · · · · · · · · · · ·	DOMESTIC WATER	PC	PRIMARY CONTROL
•		PULL BOX	Ε	ELECTRIC	PIV	POST INDICATOR VALVE PROPERTY LINE OR PLATE
•	0	UTILITY POLE	ĔA	EACH	PL POC	POINT OF CONNECTION
D•O	\$	LIGHT	EB	ELECTRICAL BOX	PP	POWER POLE
0•0	· Y ·	TEMPORARY LIGHT	EC	END OF CURVE	PR	PAIR
		TEMI OVAN LIGHT	<u>ម</u>	EXPANSION JOINT	PRC	POINT OF REVERSE
	®	GAS REGULATOR	ELEV	ELEVATION		CURVATURE
©			EP .	EDGE OF PAVEMENT	PSF	POUNDS PER SQUARE FOOT
	© N	GAS METER	ESCP	EXTRA STRENGTH CONCRETE PIPE	PSI (B)	POUNDS PER SQUARE INCH
H	×	GAS VALVE	EW EVIST //E)	EACH WAY EXISTING	(P) PUE	PROPOSED PUBLIC UTILITIES EASEMENT
			5451/(5)	EXISTING	PVCP	POLYVINYLCHLORIDE PIPE
	_	P007 00 D0111P0	(F)	FUTURE		OCT WITEON COMOC THE
•	0	POST OR BOLLARD	j FDC	FIRE DEPARTMENT CONNECTION	R	RADIUS
•	q	SIGN POST LOCATION	FDN	FOUNDATION	RCP	REINFORCED CONCRETE PIPE
		_	Į FF	FINISHED FLOOR	REINF	REINFORCED
S=0.003		PIPE SLOPE, GUTTER SLOPE	FG	FINISH GRADE	RWD	REDWOOD
St.	. 4.k	ODOX SUBJECTION	FH FIN	FIRE HYDRANT FINISH	R/W	RIGHT OF WAY
7,85 ft	* 6.3*	SPOT ELEVATION	FL FL	FLOW LINE	s	SLOPE
			FLR	FLOOR	SD	STORM DRAIN
			FM	FORCE MAIN	SPEC	SPECIFICATION
			FOC/FC	FACE OF CURB	SQ	SQUARE
			ਜ ਜ	FEET	SQFT	SQUARE FEET
			FW	FIRE WATER	SQYD	SQUARE YARD
			GA .	GAUGE	<u>ss</u>	SANITARY SEWER
			G	GAS	STA STD	STATION STANDARD
			GAL	GALLON	310	STANUARU
			GALV	GALVANIZED	T.B.M.	TEMPORARY BENCH MARK
			GPM	GALLONS PER MINUTE	TEL	TELEPHONE
			GR	GRATE	TC	TOP OF CURB
					TOG	TOP OF GRATE
			HORIZ	HORIZONTAL	TOW	TOP OF WALK
			HP	HIGH POINT	TP TPB	TELEPHONE POLE TELEPHONE PULL BOX
			D	INSIDE DIAMETER (DIM)	TFR	TRANSFORMER
			Ĭ	INTERRUPTABLE GAS	TYP	TYPICAL
			i in	INCH	• • •	-
			IN	INVERT	W	WATER
			P	IRON PIPE		
			IRRI NOV	IRRIGATION	YD	YARDS
			INTX	INTERSECTION		
					•	
SYMBOLS			ABBREVIATION	NC		
	"		AUDINETIATION	10		

• —	BENCH MARK	PROPOSED	EXISTING	DESCRIPTION
A	CONTROL POINT OR T.B.M.	40700	/ college	CTORU PRAIN ME
5	DETAIL INDICATOR DETAIL IDENTIFICATION NUMBER	12*SD	12*SD	STORM DRAIN LINE
C1.01	DRAWING WHERE DETAIL IS SHOWN		<u>- ₹8*SS</u>	Sanitary Sewer Lin
	DETAIL INDICATOR			FORCE MAIN
(5)	NOTE: DRAWING NOTE WILL IDENTIFY WHERE DETAIL IS SHOWN	10"W	10 "W	WATER LINE
•	REVISION	—— GAS ——	———GAS———	GAS LINE
<u></u>	REVISION NUMBER	—— TEL——	——— TEL ———	COMMUNICATION LINE
A	SECTION INDICATOR	12KV	12KV	ELECTRICAL LINE
5 C2.0	DETAIL IDENTIFICATION NUMBER DRAWING WHERE DETAIL IS DRAWN	1 °C	1*C	ELECTRICAL CONDUIT
MATCH	MATCH LINE			
	SHADED PORTION IS THE SIDE CONSIDERED NUMBER INDICATES ADJACENT DRAWING			
5	NOTE INDICATOR			

GENERAL NOTES

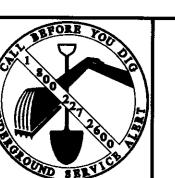

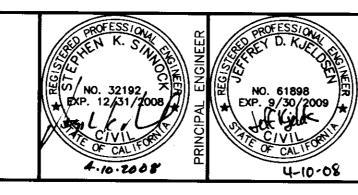

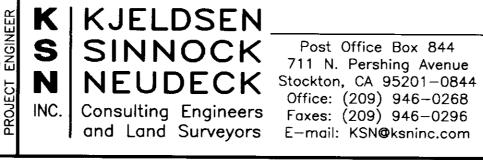

Office: (209) 946-0268 and Land Surveyors E-mail: KSN@ksninc.com

SAN JOAQUIN COUNTY THORNTON ROAD FRONTAGE IMPROVEMENT PLANS

CIVIL NOTES & LEGEND

CONVENTIONS

No. Description Date By

Revisions

LINETYPES

Scale **AMC** NO SCALE Drawn riginal Drawing Scale Check

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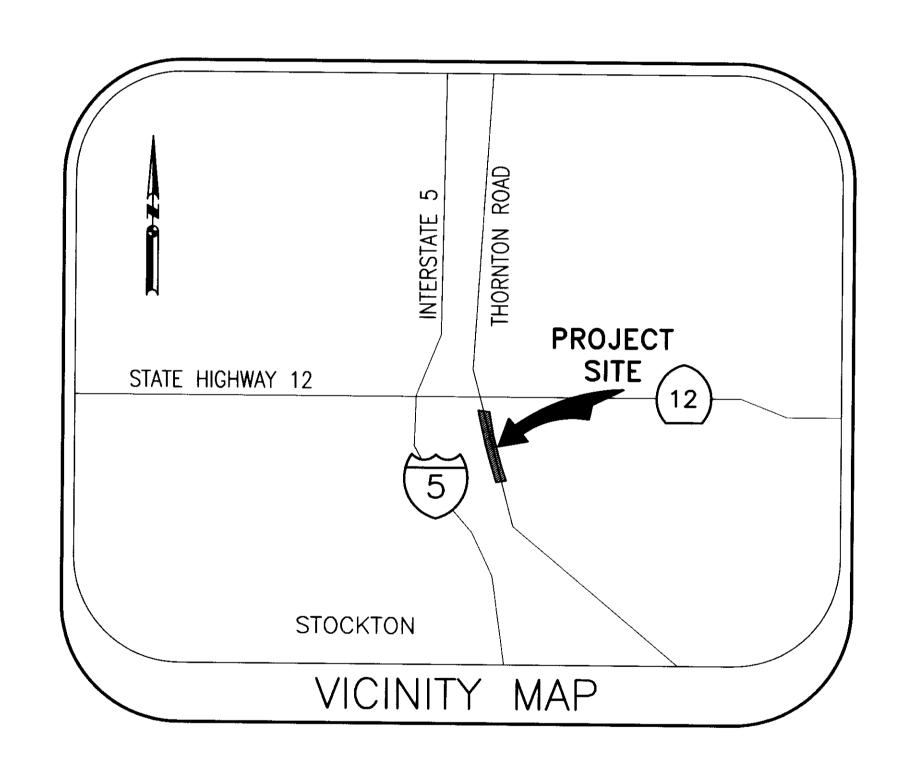
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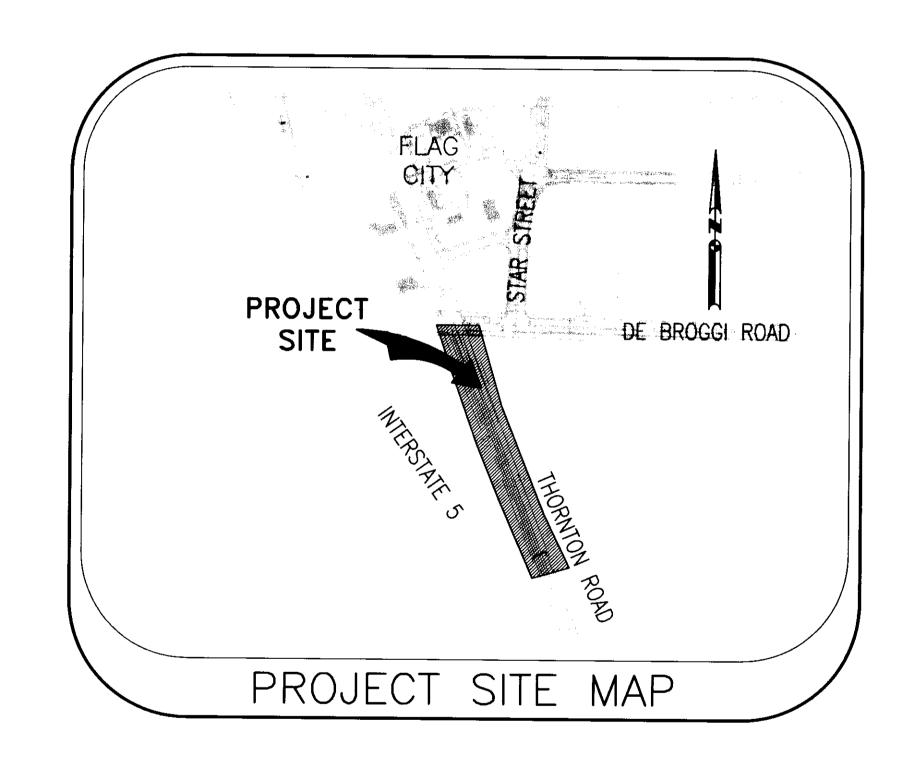
FRONTAGE AND UTILITY IMPROVEMENTS

FOR


THORNTON ROAL

SAN JOAQUIN COUNTY, CALIFORNIA







SHEET NO.	DESCRIPTION
1	TITLE SHEET
2	CIVIL NOTES & LEGEND
3	LAYOUT & CONTROL PLAN
4	KEY SHEET
5-6	PLAN & PROFILE (DE BROGGI
7–9	PLAN & PROFILE (THORNTON)
10	ON-SITE DRAINAGE PLAN
11	STRIPING PLAN
12-13	DETAILS
14	TRAFFIC CONTROL PLAN
15	EROSION CONTROL PLAN
SHEET	INDEX

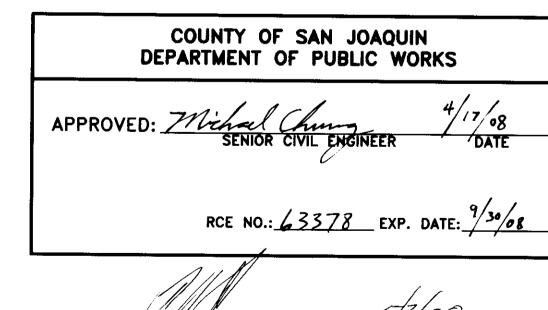


DIRECTOR OF PUBLIC WORKS COUNTY OF SAN JOAQUIN

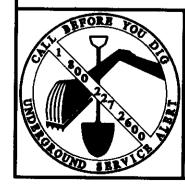



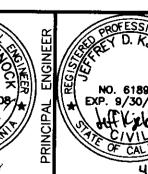



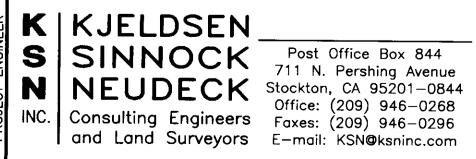

SAN JOAQUIN COUNTY THORNTON ROAD FRONTAGE IMPROVEMENT PLANS TITLE SHEET

Re	visions				Design	Scale	Date
No.	Description	Date	Ву	Aprvd. By	AMC		4/10/08
<u></u>					Drawn	N.T.S.	Sheet Number
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						0 1/" 1"	
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